



303 Najoles Road - Suite 114  
Millersville, MD 21108

Phone: 410-987-6901  
Fax: 410-987-0589

October 10, 2024

Ms. Sterling Seay  
Anne Arundel County  
Office of Planning and Zoning  
2664 Riva Road  
Annapolis MD 21401

Re: 3018 Friends Road  
**Annapolis, MD 21401**  
T.M. 50 B. 23 P. 237

Dear Ms. Seay,

Please accept this as our formal variance request to the Subdivision and Development Regulations in Article 17 on behalf of our client regarding critical area law. The variance requests are to Article 17, Section 8-301(b) prohibiting disturbance in the 100' buffer and to Article 17, Section 8-201 to disturb steep slopes in the critical area.

We are requesting this variance to allow for an existing house to go through a partial demo/remodel process. It is the intention of the owners, as shown on the proposed house plans to demo the first floor of the existing house and leave the foundation as is. There will be no increase in the foot print or impervious coverage of the lot. The proposed work can be done with little disturbance to the steep slopes and 100' critical area buffer. The renovation will require the existing foundation to be upgraded in order to support the proposed renovation. A structural engineer has designed a helical pile system to be installed to help support the existing foundation. This structural improvement can be done within the walls of the foundation. For this reason, it is hard to determine the exact disturbance required. We believe that a conservative disturbance area would be approximately 10 feet around the perimeter of the existing house foot print which equates to approximately 2,210 square feet. The entirety of the house and decks are within the 100' critical area buffer or within slopes greater than 15%.

Explanation as required by Article 18, Section 16-305(b)

The topographical conditions of this lot cause implementation of the County's critical area program to cause unwarranted hardship on the property. A variance is necessary to partially demo and remodel an existing house. Literal interpretation of COMAR, Title 27, Criteria for Local Critical Area Program Development or the County's critical area program and related ordinances will deprive the applicant of rights commonly enjoyed by other properties in similar areas and will not confer special privilege onto the applicant as adjacent residences have remodeled their homes. These variance requests are not results of actions by the applicant and there has been no


commencement of development before this application for a variance was filed and does not have any bearing or connection to building on neighboring properties. The granting of this variance will not adversely affect water quality and fish as the flow characteristics of the site remain unchanged in the proposed condition as the lot coverage will not be changed and all disturbance will be restored to natural condition. Wildlife or plant habitat will not be adversely affected as the granting of the variances will allow the disturbance to be proposed as the same foot print, minimizing any new clearing of trees and disturbance to wildlife habitat. There are no other site planning alternatives for this particular site as the request is to partially demo/remodel an existing home with same foot print which reduces the amount of disturbance as much as possible.

Explanation as required by Article 18, Section 16-305(c)

We believe the granting of this variance is warranted because the requested variance is the minimal necessary to afford relief because the proposed plan is the least intrusive way to remodel an existing house. The granting of this variance will not alter the character of the neighborhood as the proposal aims to only remodel an existing home which other adjacent properties also have done. This variance will not impair the appropriate use or development of the surrounding property as it will not deny access or the possibility to build on neighboring lots. The variance will not reduce forest cover in the LDA nor be contrary to the acceptable clearing and replanting practices in the LDA as there is no clearing proposed. The granting of this variance will not be detrimental to the welfare of the public.

If you have any questions or need any additional information, please feel free to contact me at your convenience.

Sincerely,

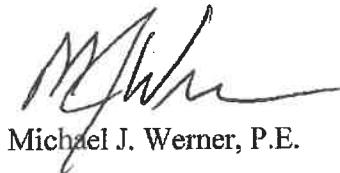A handwritten signature in black ink, appearing to read "M.J. Werner".

Michael J. Werner, P.E.



**CRITICAL AREA COMMISSION  
CHESAPEAKE AND ATLANTIC COASTAL BAYS  
1804 WEST STREET, SUITE 100  
ANNAPOLIS, MD 21401**

**PROJECT NOTIFICATION APPLICATION**

**GENERAL PROJECT INFORMATION**

Jurisdiction: *ANNE ARUNDEL County*

Date: *1/16/2025*

Tax Map #	Parcel #	Block #	Lot #	Section
50	237	23	3,4 ap/05	A

Tax ID: *02-154-10159905*

**FOR RESUBMITTAL ONLY**

- |                   |                          |
|-------------------|--------------------------|
| Corrections       | <input type="checkbox"/> |
| Redesign          | <input type="checkbox"/> |
| No Change         | <input type="checkbox"/> |
| Non-Critical Area | <input type="checkbox"/> |

\*Complete Only Page 1  
General Project Information

Project Name (site name, subdivision name, or other) *CAPE ST JOHN, SECTION A, LOT 3,4 ap/05*

Project location/Address *3018 FRIENDS ROAD*

City *ANNAPOLIS* Zip *21401*

Local case number

Applicant: Last name *SALKELD* First name *DANA*

Company *—*

**Application Type (check all that apply):**

Building Permit   
Buffer Management Plan   
Conditional Use   
Consistency Report   
Disturbance > 5,000 sq ft   
Grading Permit

Variance   
Rezoning   
Site Plan   
Special Exception   
Subdivision   
Other

**Local Jurisdiction Contact Information:**

Last name \_\_\_\_\_ First name \_\_\_\_\_

Phone # \_\_\_\_\_ Response from Commission Required By \_\_\_\_\_

Fax # \_\_\_\_\_ Hearing date \_\_\_\_\_

## SPECIFIC PROJECT INFORMATION

Describe Proposed use of project site:

RENOVATE EXISTING HOUSE TO ADD STORIES ABOVE

Intra-Family Transfer	<input checked="" type="checkbox"/>	Yes	Growth Allocation	<input type="checkbox"/>
Grandfathered Lot	<input type="checkbox"/>		Buffer Exemption Area	<input checked="" type="checkbox"/>

### Project Type (check all that apply)

Commercial	<input type="checkbox"/>	Recreational	<input type="checkbox"/>
Consistency Report	<input type="checkbox"/>	Redevelopment	<input type="checkbox"/>
Industrial	<input type="checkbox"/>	Residential	<input checked="" type="checkbox"/>
Institutional	<input type="checkbox"/>	Shore Erosion Control	<input type="checkbox"/>
Mixed Use	<input type="checkbox"/>	Water-Dependent Facility	<input type="checkbox"/>
Other	<input type="checkbox"/>		

## SITE INVENTORY (Enter acres or square feet)

	Acres	Sq Ft
IDA Area	0.45	
LDA Area		
RCA Area		
Total Area	0.45	

	Acres	Sq Ft
Total Disturbed Area		3,471

# of Lots Created

	Acres	Sq Ft		Acres	Sq Ft
Existing Forest/Woodland/Trees	0.07		Existing Lot Coverage		8,844
Created Forest/Woodland/Trees	0		New Lot Coverage		-
Removed Forest/Woodland/Trees	6		Removed Lot Coverage		-
			Total Lot Coverage		8,846

## VARIANCE INFORMATION (Check all that apply)

	Acres	Sq Ft		Acres	Sq Ft
Buffer Disturbance		2991	Buffer Forest Clearing	0	0
Non-Buffer Disturbance		480	Mitigation	TBD	TBD

Variance Type	
Buffer	<input type="checkbox"/>
Forest Clearing	<input type="checkbox"/>
HPA Impact	<input type="checkbox"/>
Lot Coverage	<input type="checkbox"/>
Expanded Buffer	<input type="checkbox"/>
Nontidal Wetlands	<input type="checkbox"/>
Setback	<input type="checkbox"/>
Steep Slopes	<input checked="" type="checkbox"/>
Other	<input type="checkbox"/>

Structure	
Acc. Structure Addition	<input type="checkbox"/>
Barn	<input type="checkbox"/>
Deck	<input type="checkbox"/>
Dwelling	<input type="checkbox"/>
Dwelling Addition	<input checked="" type="checkbox"/>
Garage	<input type="checkbox"/>
Gazebo	<input type="checkbox"/>
Patio	<input type="checkbox"/>
Pool	<input type="checkbox"/>
Shed	<input type="checkbox"/>
Other	<input type="checkbox"/>

# **Chesapeake Bay Critical Area Report**

**3018 Friends Road  
Tax Map: 50 Grid: 23 Parcel: 237  
Lots: 3-4, & p/o 5  
Annapolis, MD**

**December 2024**

*Prepared for:*

3025 , LLC  
3025 Friends Road  
Annapolis, MD

*Prepared by:*

Holly Oak Consulting, LLC  
303 Sycamore Rd  
Severna Park, MD 21146  
[khaines@hollyoakconsulting.com](mailto:khaines@hollyoakconsulting.com)



## **1.0 - INTRODUCTION**

The subject property is located at 3018 Friends Road in Annapolis, Maryland. The property is identified on Tax Map 50, Grid 23, as Parcel 237, Lots 3-4, p/o Lt 5. The site is zoned R2 per the Anne Arundel County Zoning Map. Field work for this report was completed on October 17, 2024 by Kevin C. Haines of Holly Oak Consulting, LLC.

## **2.0 – EXISTING CONDITIONS**

The site contains 0.45-acre all of which is within the Chesapeake Bay Critical Area. More specifically, the site is mapped within the Intensley Developed Area (IDA). The site falls from east to west towards the South River. The property is entirely developed with a residence, driveway, and accessory structures.

The site is bordered to the north and south by residences, to the west by the South River, and to the east by Friends Road.

The United States Department of Agriculture Natural Resources Conservation Service has mapped the soils throughout Anne Arundel County and makes the mapped soils and descriptions available online through the Web Soil Survey. The data that was retrieved on October 2, 2024 and showed two (2) soil types exist in the study area. The soil type and description can be found below. A copy of the soil mapping can be found in Appendix A.

<i>Map Unit Symbol</i>	<i>Map Unit Name</i>	<i>Hydric (%)</i>	<i>K-Factor (Whole Soil)</i>
AsF	Annapolis Fine Sandy Loam, 25-40% slopes	5	0.24
AuD	Annapolis-Urban land complex, 5-15% slopes	0	-

## **3.0 – AERIAL IMAGERY REVIEW & SITE HISTORY**

This site is located along the shores of the South River, near Riva, MD a suburb of the greater Baltimore and Annapolis areas. The surrounding area was largely used as a summering location from the 1920s through the 1950s, when the surrounding areas began to become developed with residential subdivisions. A copy of the USGS Topographical map can be found in Appendix A.

Per aerial photos from 1970-2024, the site has remained in a similar vegetative state. Aerial images are available upon request.

## **4.0 – PROPOSED CONDITIONS**

The applicant proposes to add a second story addition to the structure. No ground disturbance is proposed.

Forest clearing and ground disturbance within the buffer are not proposed.

Stormwater management is not required for this project as the proposal does not include disturbance above 5,000 square feet, and forest clearing is not required.

## **5.0 – HABITAT PROTECTION AREAS**

State and County Critical Area Law identifies certain areas of high environmental value as habitat protection areas (HPAs). Below is a discussion of HPA's existing within the subject site.

### **5.1 - Steep Slopes**

Anne Arundel County designates steep slopes within the Critical Area as slopes of 15% that are at least 6' high. The site includes steep slopes and their buffer and disturbance to both areas is proposed. The disturbance is minimal and has been minimized to footer installation only for the deck.

### **5.2 - Rare, Threatened & Endangered Species**

A request for Environmental Review was submitted to the Maryland Department of Natural Resources Wildlife and Heritage Services on October 15, 2024 and a response is forthcoming. Per initial research of DNR records there does not appear to be records of RTEs within or adjacent to the boundary of this site. RTEs were not noted during the field visits to this site. The site is not mapped as FIDS habitat per MDDNR's MERLIN Online GIS Database.

### **5.3 - Wetlands, Streams, & 100-Year Floodplain**

The site does not contain tidal wetlands, non-tidal wetlands, or streams per the field observations. Furthermore, neither the USFWS National Wetland Inventory nor the MD DNR Wetland Inventory indicates the presence of wetlands or streams within the site boundary.

The site is located within the South River Watershed (MD 02131003 8-digit).

The site lies within Zone X (areas of minimal flood hazard) except for the directly adjacent to the South River (zone AE) per FEMA Flood Insurance Rate Maps #24003C0229F (eff. 2/18/15).

### **5.4 – Buffer and Expanded Buffer**

The site contains the 100' buffer to Tidal Waters. The buffer is not expanded on site as the property lies within a buffer modified area.

### **5.5 – Other HPAs Not Contained within Study Area**

Several HPAs are not mapped within or adjacent to the study area. MDDNR's MERLIN online mapping database was reviewed and showed that the following HPA's are not located within or near the study area: Submerged aquatic vegetation, shellfish beds, historical waterfowl staging and concentration areas, sensitive species project review areas, and natural heritage areas.

## **6.0 – EXISTING VEGETATION & WILDLIFE**


Except for landscaping provided on site, no notable vegetation is present on site.

## References


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- Foell, Stephanie (2004). *McLean Property, Maryland Historical Trust Determination of Eligibility Form*. Baltimore, MD: Maryland Historical Trust.
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- Kaufman, S. R., & Kaufman, W. (2013). *Invasive plants: a guide to identification, impacts, and control of common North American species*. Mechanicsburg, PA: Stackpole Books.
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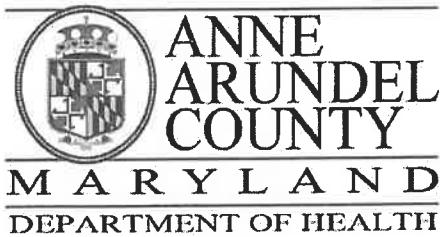
 <p><b>HOLLY OAK</b> CONSULTING, LLC</p> <p>303 Sycamore Rd Severna Park, MD 21146 P: (410) 906-3119 Email: info@hollyoakconsulting.com</p>	<p><b>PROJECT</b></p> <p><b>3018 FRIENDS ROAD</b></p> <p>ANNAPOLIS, MD ANNE ARUNDEL CO.</p>	<p><b>DRAWING TITLE</b></p> <p><b>VICINITY MAP</b></p>	<p><b>PROJ. NO.</b> <b>24-110</b></p> <p><b>DRAWN BY</b> <b>KCH</b></p> <p><b>SCALE</b> <b>1" = 1,000'</b></p> <p><b>DATE</b> <b>12/15/2024</b></p>	<p><b>FIGURE</b></p> <p><b>1</b></p>



 <b>HOLLY OAK CONSULTING, INC.</b> 303 Sycamore Rd Severna Park, MD 21146 P: (410) 906-3119 Email: info@hollyoakconsulting.com	PROJECT	DRAWING TITLE	PROJ. NO. 24-110	FIGURE 2
	3018 FRIENDS ROAD	USGS 24K TOPOGRAPHICAL MAP	DRAWN BY KCH SCALE 1"=500' DATE 12/15/2024	
ANNE ARUNDEL CO.				

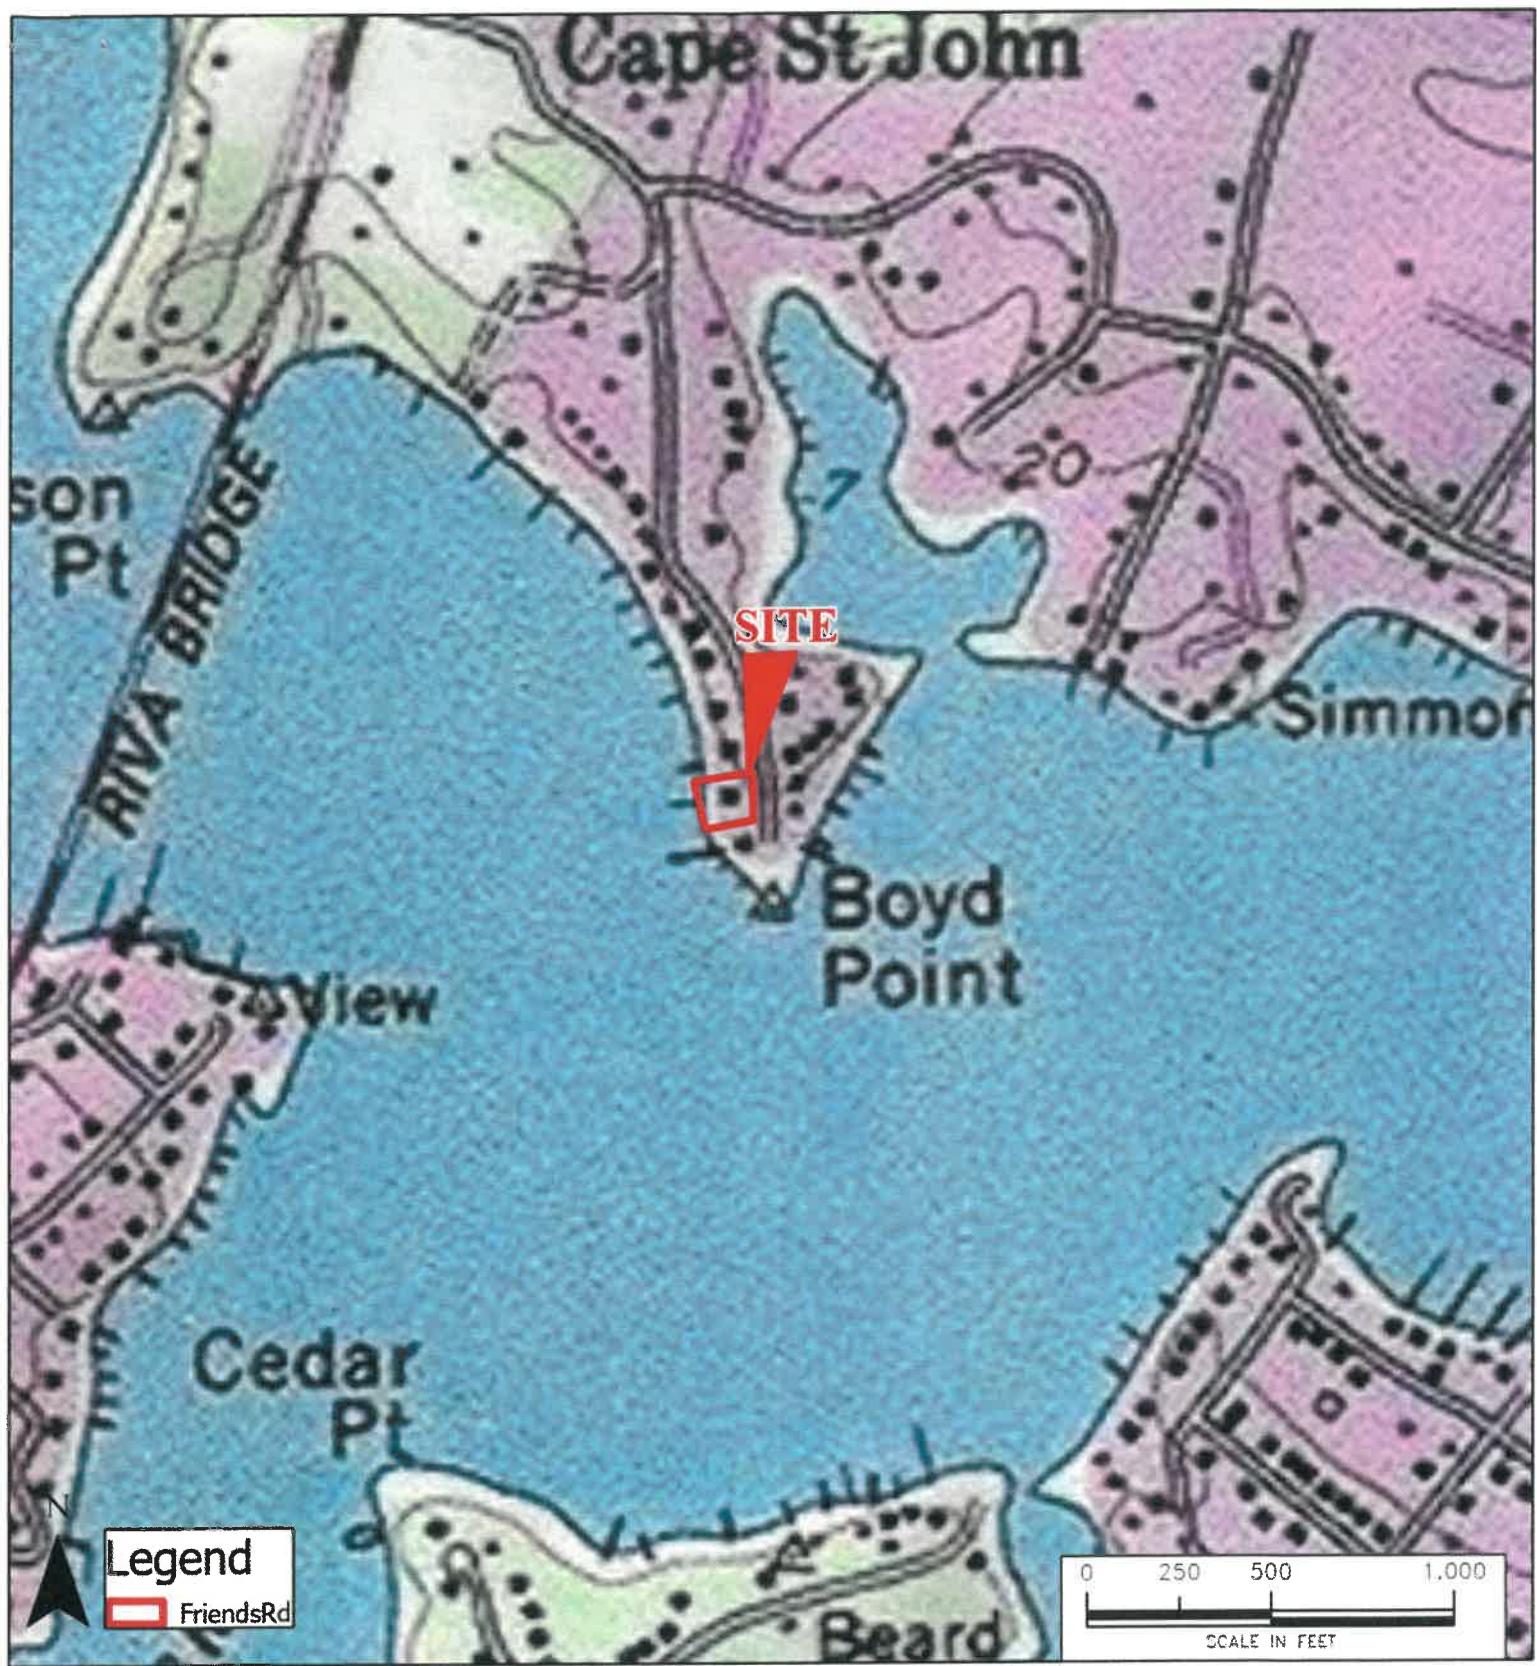

PROJECT	DRAWING TITLE	PROJ. NO.	FIGURE
3018 FRIENDS ROAD ANNAPOLIS, MD ANNE ARUNDEL CO.	USDA NRCS SOIL SURVEY	24-110 DRAWN BY KCH SCALE 1"=500' DATE 12/15/2024	3
HOLLY OAK CONSULTING, LLC 303 Sycamore Rd Severna Park, MD 21146 P: (410) 906-3119 Email: info@hollyoakconsulting.com			

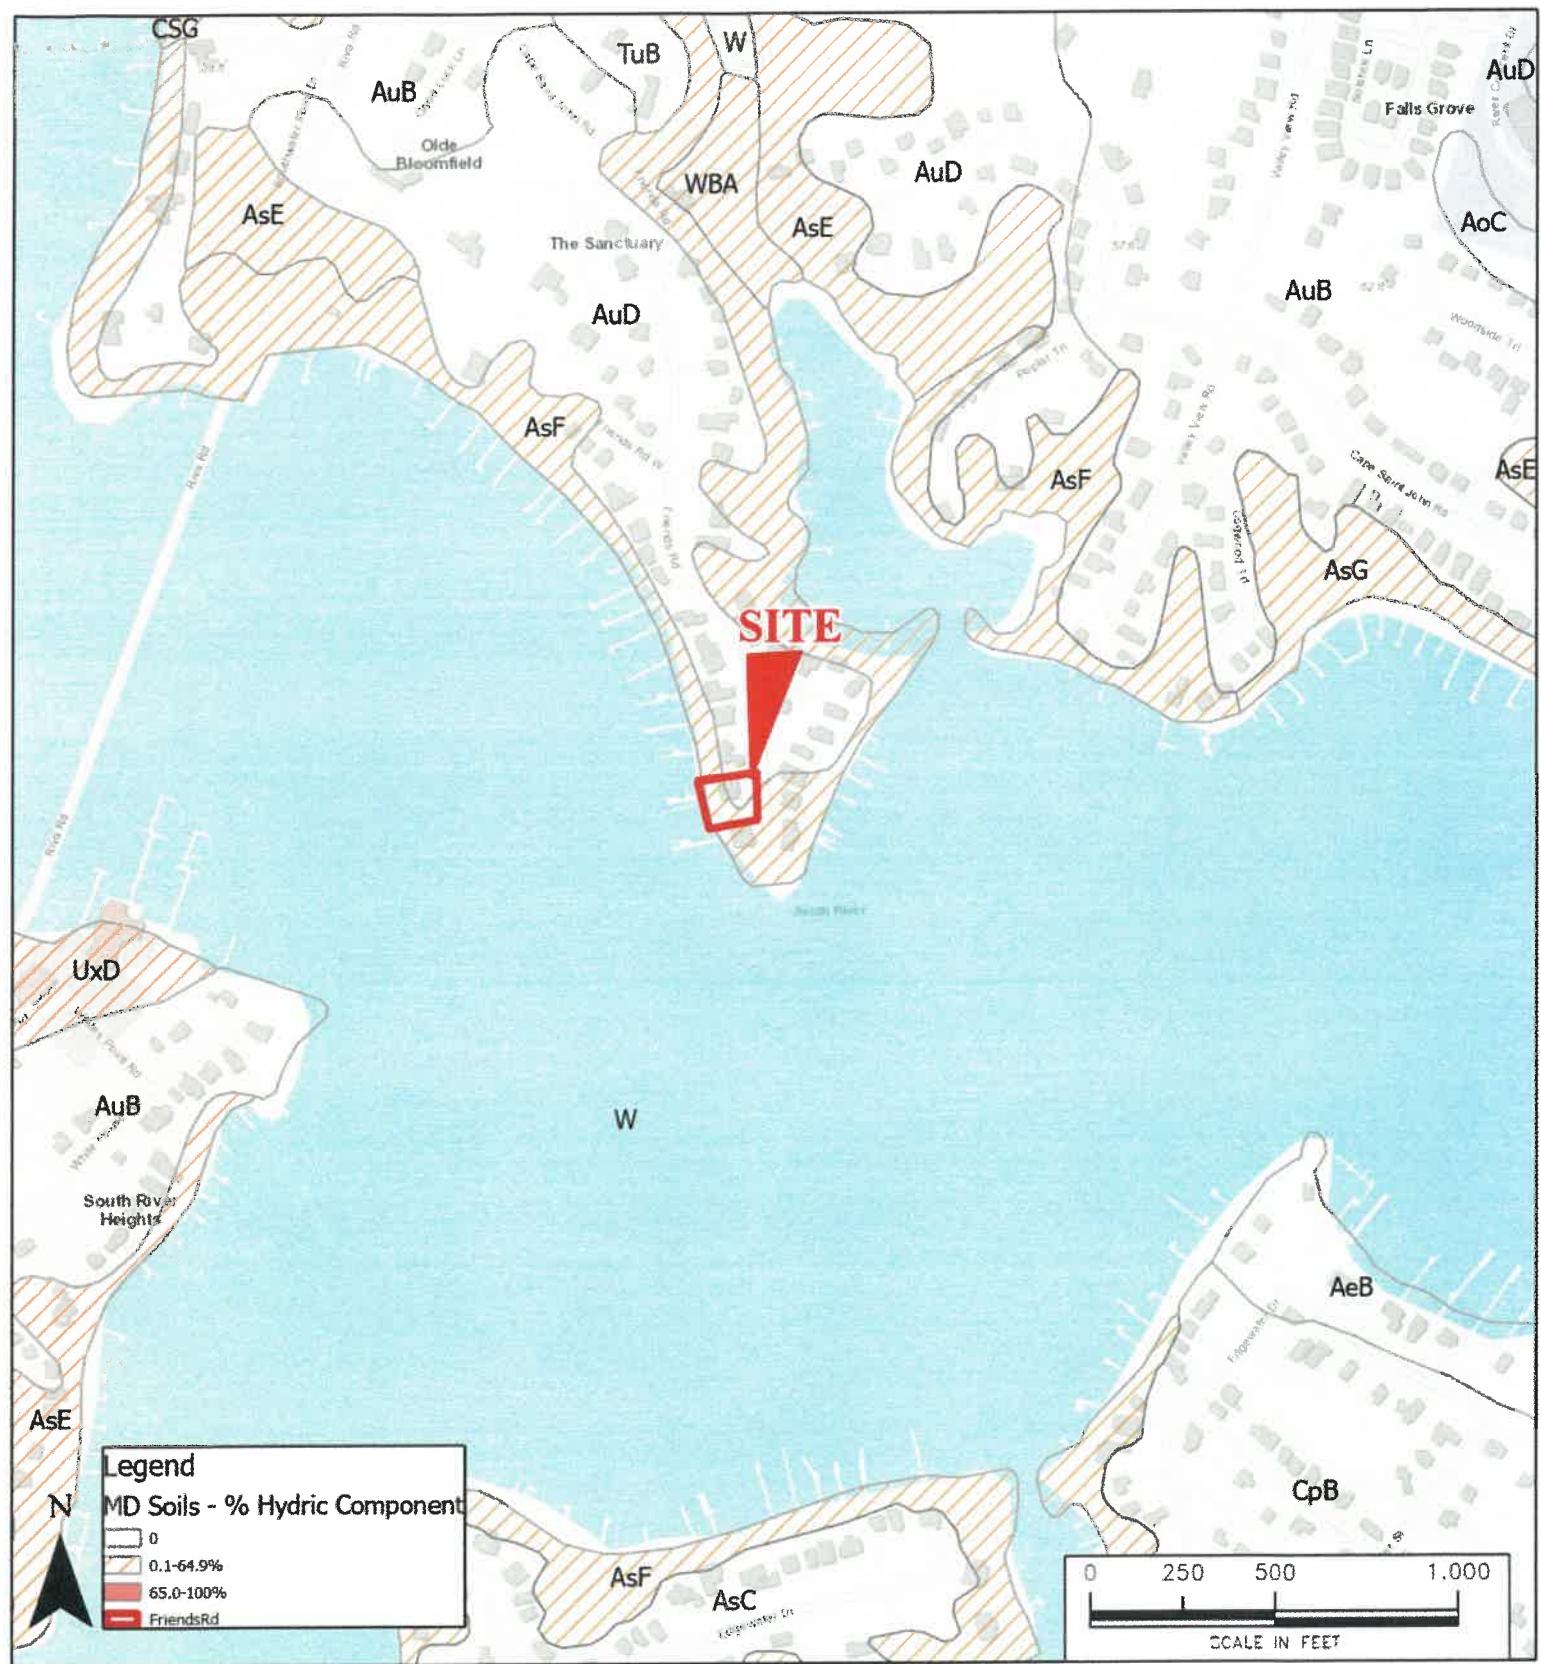

J. Howard Beard Health Services Building  
3 Harry S. Truman Parkway  
Annapolis, Maryland 21401  
Phone: 410-222-7095 Fax: 410-222-7294  
Maryland Relay (TTY): 711  
[www.aahealth.org](http://www.aahealth.org)

**Tonii Gedin, RN, DNP**  
Health Officer

**MEMORANDUM**

TO: Sadé Medina, Zoning Applications  
Planning and Zoning Department, MS-6301

FROM: Brian Chew, Program Manager  
Bureau of Environmental Health 

DATE: February 7, 2025

RE: 3025, LLC  
3018 Friends Road  
Annapolis, MD 21401

NUMBER: 2025-0010-V

SUBJECT: Variance/Special Exception/Rezoning

The Health Department has reviewed the above referenced variance to allow a dwelling addition (first floor renovation, second floor addition, third floor half-story attic) with less setbacks than required and with disturbance to slopes of 15% or greater.

The Health Department has reviewed the above-referenced request. The property is served by public water and sewer facilities. The Health Department has no objection to the above-referenced request.

If you have further questions or comments, please contact Brian Chew at 410-222-7413.

cc: Sterling Seay

# SALKELD RESIDENCE

ANNAPOULS, MARYLAND

## CONSTRUCTION DRAWINGS

DESIGN CRITERIA PER 2018 IRC AND 2018 IEEC

INSTALL FIRE SUPPRESSION SYSTEM IN ACCORDANCE WITH NFPA 13D

EXISTING FIRST FLOOR FINISHED AREA: 2,352 SQ.FT.  
REMODELED FIRST FLOOR AREA: 2,352 SQ.FT.

EXISTING SECOND FLOOR FINISHED AREA: 0 SQ.FT.  
ADDITION SECOND FLOOR AREA: 1,615 SQ.FT.

EXISTING FIRST & SECOND FLOOR FINISHED  
AREA: 3,923 SQ.FT.

REMODELED AND ADDITION FIRST & SECOND  
FLOOR FINISHED AREA: 4,021 SQ.FT.

EXISTING BASEMENT FINISHED: 990 SQ. FT.

ADDITION BASEMENT FINISHED: 400 SQ. FT.  
REMODELED AND ADDITION BASEMENT  
FINISHED AREA: 1,390 SQ.FT.

### SCOPE OF WORK

DEMO PER SHEETS A009 - A011  
 INSTALL NEW WINDOWS, ROOF & SIDING  
 INSTALL NEW WALLS PER PLAN  
 INSTALL NEW SECOND FLOOR PER PLAN  
 INSTALL NEW ROOF PER PLAN  
 INSTALL NEW HVAC, PLUMBING & ELECTRIC  
 INSTALL NEW INSULATION & DRYWALL  
 INSTALL NEW TRIM, FLOOR COVERING & PAINT  
 INSTALL NEW CABINETS, TOPS & APPLIANCES

PROFESSIONAL CERTIFICATION I HEREBY  
 CERTIFY THAT THESE DOCUMENTS ARE  
 THE PROPERTY OF THE SALKELD RESIDENCE,  
 AT FULL SCALE AND PREPARED IN ACCORDANCE  
 WITH THE LAWS OF THE STATE OF MARYLAND,  
 LICENSE NO. 16426, EXPIRATION DATE 10/24.

	DATE: 12/13/23
	REVISIONS

	ADDITION/REMODEL FOR SALKELD FAMILY RETREAT BUILDING SITE: 3018 FRIENDS ROAD ANNAPOLIS, MD 21401
--	--

### DRAWING INDEX

#### ARCHITECTURAL:

A001	COVER SHEET	NO SCALE
A002	NOTES DIVISION 1 - 4	NO SCALE
A003	NOTES DIVISION B - 16	NO SCALE
A001	FRONT ELEVATION	1/4" = 1'-0"
A002	REAR ELEVATION	1/4" = 1'-0"
A003	REAR & SIDE ELEVATIONS	3/16" = 1'-0"
A004	FIRST FLOOR PLAN	1/4" = 1'-0"
A005	SECOND FLOOR PLAN	1/4" = 1'-0"
A006	FOUNDATION PLAN	1/4" = 1'-0"
A007	EXISTING FRONT & REAR ELEVATIONS	1/4" = 1'-0"
A008	EXISTING SIDE ELEVATIONS	3/16" = 1'-0"
A010	EXISTING FIRST FLOOR PLAN	1/4" = 1'-0"
A011	EXISTING FOUNDATION PLAN	1/4" = 1'-0"
A001	FIRST FLOOR FRAMING PLAN	1/4" = 1'-0"
A002	SECOND FLOOR FRAMING PLAN	1/4" = 1'-0"
A003	ROOF FRAMING PLAN	1/4" = 1'-0"
A004	SECTION 1	3/16" = 1'-0"
A005	SECTION 2	3/16" = 1'-0"
A006	SECTION 3	1/2" = 1'-0"
A007	SECTION 4	1/2" = 1'-0"
A008	SECTION 4	1/2" = 1'-0"
A009	SECTION 4	1/2" = 1'-0"
	CALCS	NO SCALE
E001	FIRST FLOOR ELECTRICAL	1/4" = 1'-0"
E002	SECOND FLOOR ELECTRICAL	1/4" = 1'-0"
E003	BASEMENT ELECTRICAL	1/4" = 1'-0"

SHEET  
001

#### DIVISION 1 - GENERAL REQUIREMENTS

ALL CONSTRUCTION SHALL COMPLY WITH THE INTERNATIONAL RESIDENTIAL CODE (IRC 2018 EDITION) AND THE INTERNATIONAL ENERGY CODE (IEC 2018 EDITION). ALL MECHANICAL, ELECTRICAL, AND PLUMBING ARE TO BE INSTALLED PER IFCC, INC. AND IRC 2018. CONSTRUCTION DOCUMENTS INCLUDE: MECHANICAL, ELECTRICAL, AND PLUMBING, WHICH ARE APPROPRIATE EDITIONS BUT NOT LIMITED TO THOSE PERTAINING TO TAXES, PERMIT AND INSURANCE REGULATIONS.

1. THE ENCLUE OF THE WORK SHALL BE EXECUTED IN STRICT ACCORDANCE WITH THE REGULATIONS AND CODES OF THE GOVERNMENT OF MARYLAND, WHICH ARE APPROPRIATE EDITIONS BUT NOT LIMITED TO THOSE PERTAINING TO TAXES, PERMIT AND INSURANCE REGULATIONS.
2. THE CONSTRUCTION DOCUMENTS FOR THIS PROJECT SHALL CONSIST OF THREE DRAWINGS AND SPECIFICATIONS. THE DOCUMENTS ARE FOR THE USE OF CONTRACTORS, ARCHITECTS AND OTHER PROFESSIONALS.
3. THE DRAWINGS AND SPECIFICATIONS PREPARED BY THE DESIGNER ARE INTENTED FOR THE DESIGNERS SERVICES THROUGH WHICH THE WORK TO BE DESCRIBED IS DESIGNED. THE DESIGNER IS DEEMED THE AUTHORITY FOR THE DRAWINGS AND SPECIFICATIONS PREPARED BY HIM OR HER.
4. THE DRAWINGS AND SPECIFICATIONS AND OTHER DOCUMENTS PREPARED BY THE DESIGNER ARE INTENTED FOR THE DESIGNERS SERVICES THROUGH WHICH THE WORK TO BE DESCRIBED IS DESIGNED. THE DESIGNER IS DEEMED THE AUTHORITY FOR THE DRAWINGS AND SPECIFICATIONS PREPARED BY HIM OR HER.
5. THE INTENT OF THESE DOCUMENTS IS TO PROVIDE A FINISHED BUILDING, WITH THE EXCEPTION OF THOSE ITEMS WHICH ARE NOT THE RESPONSIBILITY OF THE CONTRACTOR, SUCH AS EXHAUST FAN, AIR CONDITIONER, KITCHEN EQUIPMENT, LABOR, ETC. TO COMPLETE THE WORK EVEN THOUGH SUCH ITEMS MAY NOT BE INDICATED ON THE DOCUMENTS, IT CAN BE ASSUMED THAT THE CONTRACTOR IS RESPONSIBLE FOR THESE ITEMS.
6. THE CONTRACTOR SHALL HAVE NO SUPERVISION, ADVISE OR INSPECTION PRIVILEGES IN THE FIELD DURING THE CONSTRUCTION OF THE WORK ACCORDING TO THE CONTRACT. ALL INFORMATION CONTAINED IN THE DRAWINGS AND IN DOCUMENT A-H, GENERAL CONDITIONS OF THE CONTRACT FOR CONSTRUCTION, AND PREPRINT H-B SERVICES IN ACCORDANCE WITH THE CONTRACT, AS WELL AS THE OTHER SERVICES AS DESCRIBED UNDER ARTICLE 2 ARE NOT PART OF THE SCOPE OF THE WORK FOR THIS PROJECT.
7. THESE ARTICLES OF MATERIAL APPROVED BY PROPERTY OWNER OR VENDOR OF MANUFACTURE ARE EXPECTED TO ENSURE QUALITY OF MATERIAL PROVIDED. THE CONTRACTOR IS RESPONSIBLE FOR THE INSPECTION AND APPROVAL OF MATERIAL PROVIDED. APPROVED IS ACCEPTABLE TO THE OWNER. ACCEPTANCE OF AN APPROVED EQUAL IS ENTIRELY AT THE DISCRETION OF THE OWNER.
8. EQUAL IN QUALITY OF MATERIAL SPECIFIED, BOTH IN STRUCTURAL STRENGTH AND IN DETAIL OF CONSTRUCTION.
9. EQUAL IN PRICES OR CHARACTERISTICS PERMITTED SPECIFIED PRIOR TO BE APPLIED.
10. CONTRACTOR SHALL PROTECT ADJACENT PROPERTY, INCLUDING STREETS AND PLAZAS, DURING CONSTRUCTION OR DEMOLITION, AND IN ACCORDANCE WITH THE CONTRACT, SHE WILL REPAIR ANY DAMAGE CAUSED TO PROPERTY OR TO OTHER PROPERTY.
11. CONTRACTOR SHALL TAKE APPROPRIATE PRECAUTIONS THEREABOUT TO GUARD AGAINST AND ELIMINATE FIRE HAZARDS ON THE SITE.
12. CONTRACTOR SHALL CARRY OUT PERIODIC CLEANING OF CONSTRUCTION SITE TO KEEP FREE OF DUST.
13. DIMENSIONS, SIZES OR DRAWINGS FOR WOOD CONSTRUCTED WALLS ARE FACE TO FACE, OR CENTER, UNLESS OTHERWISE SPECIFIED IN DRAWINGS.
14. DIMENSIONS, SIZES OR DRAWINGS FOR STEEL, TUBULAR, TRUSSES, I-DECKERS, ETC. ARE NOMINAL. CONTRACTOR SHALL VERIFY REFLECTIONS ON DRAWINGS.
15. DO NOT HIGHLIGHT DRAWINGS FOR DIMENSIONS. DIMENSION IS TO BE ADVISED OF ANY HIGHLIGHT DIMENSIONS NOT REFLECTED ON DRAWINGS.
16. CONTRACTOR SHALL NOT ENGAGE IN ACTS AND/OR CONDITIONS WHICH MAY EFFECT THE CONSTRUCTION OF THEIR PART OF WORK. THE DESIGNER SHALL BE NOTIFIED OF ANY CONDITIONS WHICH ARE NOT IN CONFORMANCE WITH THE CONTRACT DOCUMENTS, COMPLIANCE WITH CODE, OR WHICH MAY SUBSTANTIALLY EFFECT THE CONSTRUCTION OF THEIR PART OF WORK.
17. THE DESIGNER WILL NOT BE RESPONSIBLE FOR AND WILL NOT HAVE CONTROL OVER CONSTRUCTION METHODS, TECHNIQUES, SEQUENCES OR PROCEDURES, OR FOR SAFETY PRECAUTIONS AND PROGRAMS IN CONSTRUCTION. THE CONTRACTOR SHALL BE RESPONSIBLE FOR THE SAFETY OF ANYONE PERFORMING ANY WORK TO CARRY OUT THE WORK IN ACCORDANCE WITH THE CONSTRUCTION DOCUMENTS.
18. PINT-SHOT DESIGN LOADS:  
A. ROOF: 40 PSF (1800 LB/SQFT)  
B. FLOR: 40 PSF (1800 LB/SQFT)  
C. LOUNGE (NEUTRAL AREA): 16 PSF (720 LB/SQFT)  
D. EXTERIOR DECK: 40 PSF (1800 LB/SQFT)  
E. ELEVATOR: 40 PSF (1800 LB/SQFT)  
F. ATTIC AND STOREROOM: 16 PSF (720 LB/SQFT)  
G. ATTIC AND STOREROOM: 16 PSF (720 LB/SQFT)  
H. STAIRS: 40 PSF (1800 LB/SQFT)  
I. ELEVATORS: 40 PSF (1800 LB/SQFT)  
J. MASONRY: LATERAL FORCE OF 364 PSF AT ANY GIVEN POINT  
K. EXTERIOR WALL: 16 PSF (720 LB/SQFT)  
L. SEISMIC DESIGN: RDICTION B
19. CONSTRUCTION CLAMMATION:  
A. LOCAL (NON-RESIDENTIAL)  
B. CONSTRUCTION TYPE: S-B (CONCRETE UNPROTECTED)
20. FIRE SEPARATION:  
A. EXTERIOR WALLS (NON-BEARING): 1/2 HOUR  
B. EXTERIOR WALLS (WITH-BEARING): 1/2 HOUR  
C. INTERIOR WALLS: 1/2 HOUR  
D. INTERIOR WALLS (WITH-BEARING): 1/2 HOUR  
E. EXTERIOR DOORS: 1/2 HOUR  
F. ROOF/Ceiling CONSTRUCTION: 1/2 HOUR  
G. SLAB: 1/2 HOUR
21. CEILING AND ROOFING DESIGN CRITERIA  
A. ROOF LOAD: 30 PSF  
B. FROST LINE DEPTH: 30'
22. WALL FRAGGS:  
A. WALL FRAGGS TO BE IN ACCORDANCE WITH 2018 INTERNATIONAL BUILDING CODE SECTION R602.10

#### DIVISION 2 - SITE WORK

1. PROSPECTIVE AND ACTUAL 3 INCH PSF ON UNDISTURBED SOIL OR COMPACTED FILL. IT SHALL BE THE OWNER'S RESPONSIBILITY TO VERIFY THAT THE BEARING CAPACITY IS SUFFICIENT PRIOR TO START OF CONSTRUCTION.
2. EXCAVATE EARTH IMPROVEMENT TO PROVIDE PROPER CERTAIN AND OPINION AS ASHORE ON THE DRAWINGS ALLOWING APPROPRIATE ROOM FOR INSTALLATION OF FORMS AND SERVICES. NO EXCAVATION SHALL BE MADE BEYOND THE FOOTING BY GREATER THAN ONE-HALF THE HORIZONTAL DISTANCE FROM THE NEAREST EDGE OF THE FOOTING.
3. DURING CONSTRUCTION IT SHALL BE THE CONTRACTOR'S RESPONSIBILITY TO ENHANCE THE SERVICES OF A SOIL ENGINEER TO CERTIFY THAT THE BEARING CAPACITY AND COMPATIBILITY OF THE SOIL IS APPROPRIATE FOR THE SOILS ON WHICH THE SOILS ARE BEING USED.
4. THE CONTRACTOR SHALL NOT EXCAVATE IN EXCESS OF THE DRAWINGS, AND FOR THE SOILS USE TO NOT UNDERMINED SOILS OR TO SOL-COMPACTED TO 95% OF THE FROST LINE DENSITY AT GIVEN MOISTURE CONTENT AND MAINTAIN THE MOISTURE CONTENT AT 95% OF FROST LINE DENSITY FOR NOT LESS THAN 48 HOURS AFTER EXCAVATION.
5. FILL MATERIAL SHALL BE OBTAINED PRIOR TO SITE EXCAVATION OR PURCHASED BY THE CONTRACTOR FROM OTHER SOURCES. FILL MATERIAL SHALL NOT EXCEED ONE-YARD DRAINS, ROCKS, STONES, ETC. AND FILL MATERIAL MUST BE PLACED IN LAYERS NOT EXCEEDING 12 INCHES THICK AND SHALL BE COMPACTED BY POWER OPERATED MECHANICAL EQUIPMENT CONFORM TO ASCE 24 STANDARD.
6. FREE DRAVING GRANULAR BACKFILL (CLEARAGGREGATE 3/4 INCH UNPFILLED) SHALL BE USED AGAINST FOUNDATION WALLS. EQUIVALENT FRICTION PRESSURE OF BACKFILL SHALL NOT EXCEED 30 PSF. IF BACKFILL PRESSURE EXCEEDS 30 PSF,

#### DIVISION 4 - MASONRY

1. CONCRETE MASONRY UNITS SHALL HAVE MINIMUM COMPRESSIVE STRENGTH OF 2500 PSF AND CONFORM TO THE FOLLOWING:
  - A. PORTLAND CEMENT: ASTM C-190
  - B. SILICA GRADE: ASTM C-148
2. MORTAR SHALL BE TYPE N WITH MINIMUM COMPRESSIVE STRENGTH OF 2000 PSF. MATERIALS SHALL BE AS FOLLOWS:
  - A. PORTLAND CEMENT: ASTM C-190
  - B. HYDRATED LIME: ASTM C-270
  - C. HYDRATED LIME: ASTM C-270
  - D. MASONRY: CLEAN, DRY AND FREE OF ANY DETERIORATING SUBSTANCE.
  - E. WATER SHALL BE CLEAR AND POTABLE.
3. BRICK SHALL CONFORM TO ASTM C-24. BRICK VENEER SHALL BE ATTACHED TO BLOCK CONSTRUCTION UNITS AND IN-PLACE CONCRETE UNITS WITH MECHANICAL ATTACHMENT SYSTEMS. BRICK VENEER SHALL BE ATTACHED TO BLOCK CONSTRUCTION UNITS AND IN-PLACE CONCRETE UNITS WITH MECHANICAL ATTACHMENT SYSTEMS. PROVIDE 1/8 INCH FLOOR VAPOR BARRIER OVER WALL SHEATHING AND DRAINSAGE DRAWS, SPACED 16' ON CENTER.
4. ALL STEEL ANGLES IN MASONRY UNITS SHALL BE PLATED AND FLASHED WITH 20 MIL PVC FLASHING AND DRAINSAGE DRAWS SPACED 24" ON CENTER.
5. ALL MASONRY WORK SHALL BE PROTECTED FROM FREEZING FOR NOT LESS THAN 48 HOURS AFTER INSTALLATION AND DURING THE FROST LINE DURATION. CONTRACTOR IS RESPONSIBLE FOR THE PROTECTION OF MASONRY UNITS FROM FREEZING. UNLESS AIR TEMPERATURE IS BELOW 40 DEGREES FAHRENHEIT BUT ABOVE 25 DEGREES FAHRENHEIT, DAY-TO-NIGHT VARIATION IS DEEMED AS 10 DEGREES FAHRENHEIT. IF DAY-TO-NIGHT VARIATION IS LESS THAN 10 DEGREES FAHRENHEIT, DAY-TO-NIGHT VARIATION IS DEEMED AS A TWO DEGREE FAHRENHEIT. IF THE DAY-TO-NIGHT VARIATION IS LESS THAN 10 DEGREES FAHRENHEIT, AND ANTI-FREEZE ADDITIVES SHALL BE ADDED TO THE MORTAR.

#### SUNSET DESIGN

891 MORAN COURT  
ANNAPOLIS, MD 21401  
PHONE: 443-588-9985  
DRAWN BY: MICHAEL STEVENSON

ADDITION/REMODEL FOR  
SALKELD FAMILY RETREAT  
BUILDING SITE:  
3616 FRIENDS ROAD  
ANNAPOLIS, MD 21401

SHEET  
002

PROFESSIONAL LICENSURE, CERTIFICATION, LICENSE,  
REGISTRATION, AND/OR APPROVALS ARE REQUIRED FOR THIS CONSTRUCTION.  
THIS DOCUMENT WAS DRAWN, COMPUTED, AND PREPARED BY THE CONTRACTOR.  
THE CONTRACTOR AGREES THAT THIS DRAWING IS FOR THE USE AND BENEFIT OF THE CONTRACTOR,  
AND NOT FOR PUBLIC RELEASE.  
NOTICE OF PRACTICE: THE CONTRACTOR IS PRACTICING IN THE STATE OF MARYLAND.  
LICENSE NO. 02345. EXPIRATION DATE: 11/24/24

DATE: 12/13/23  
REVISIONS:



MARYLAND  
NOTARY PUBLIC  
NO. 12345  
EXPIRED: 12/13/23

<b>DIVISION 1 - THERMAL AND MOISTURE PROTECTION</b> <p>1. ROOFING MATERIAL: THINNY (16) YEAR PINEGROVE G300 APPALACHIAN SHingles OVER ONE LAYER OF 100 ASPHALT SATURATED FELT UNDERLayment UNLESS NOTED OTHERWISE. INSTALL ACCORDING TO MANUFACTURER'S INSTRUCTIONS.      2. PERIMETER INSULATION: ALL SLATES ON GRADE IN HAMMERED SPACES SHALL BE DRAINED WITH THREE 1-1/2" DIA. HOLE DRILLED IN THE CENTER OF EACH SLATE. DRAINS ARE TO BE LOCATED 24" FROM THE BOTTOM FACE OF SLATE AT ALL SLANT PERIMETER AREAS IN HAMMERED SPACES.</p> <p>3. WATERPROOFING/FLASHING: APPROVING WATERPROOFING: ALL EXTERIOR FOUNDATION WALLS BELOW Grade ENCLOSING FOUNDATION WALLS SHALL BE WATERPROOFED AT THE INTERSECTION OF GUTTER, DRAINS, ROOF, OR AT FOUNDATION WALLS EXCLUDING DRAINAGE AND CRAWL SPACES WITH DAP™-PROOFING AS SPECIFIED BY CODE AT ALL JOINTS.</p> <p>4. FLASHING: CODE APPROVED COMMON PREMIUM FLASHING SHALL BE PROVIDED AT TOP AND BOTTOM OF ALL EXTERIOR SIDWALL AND DOOR OPENINGS. SIMILAR FLASHING SHALL BE INSTALLED AT THE INTERSECTION OF GUTTER, DRAINS, ROOF, OR AT FOUNDATION WALLS EXCLUDING DRAINAGE AND CRAWL SPACES. ALL EXTERIOR ROOF EDGES, DRAINS, ROOF, OR AT FOUNDATION WALLS EXCLUDING DRAINAGE AND CRAWL SPACES WITH DAP™-PROOFING AS SPECIFIED BY CODE AT ALL JOINTS.</p> <p>5. DRAILING: PAPER: AT BRICK VENEER APPLICATIONS: 1/4" FLOOR Felt OR PAPER SHALL BE ATTACHED TO WALL, GROUTING WITH FLASHING WHEREVER NECESSARY TO PREVENT FOUNTAIN PENETRATION BEHIND THE VENEER.</p> <p>6. ALL EXTERIOR GALLS TO HAVE VAPOR BARRIER INSTALLED OVER SHEATHING.</p> <p>7. INSULATION: MINIMUM INSULATION REQUIREMENTS TO BE AS NOTED ON DRAWINGS.</p> <p>8. GUTTERS AND DOWNSPOUTS: #60 PREPAINTED ALUMINUM GUTTERS AND #604 PREPAINTED ALUMINUM DOWNSPOUTS.</p> <p>9. VENTILATION: EXCLUDED ATTIC TRUSS SPACES AND ENCLOSED ROOF PLATES SHALL HAVE CROSS VENTILATION FOR EACH SEPARATE SPACE WITH SCREWS VENTILATING OPENINGS PROTECTED AGAINST THE INTRUSION OF MOISTURE AND KAN IN ACCORDANCE WITH THE IBC 2018 CODE.</p>	<b>DIVISION 10 - SPECIALTIES</b> <p>1. METAL PRE-FABRICATED SHALL BE APPROVED BY UNDERWRITERS LABORATORY AND INSTALLED IN ACCORDANCE WITH MANUFACTURER'S RECOMMENDED PROCEDURES.</p> <p>2. HEARTH EXTENSIONS SHALL NOT BE LESS THAN 3/8" THICK AND BE OF AN APPROVED NON-COMBUSTIBLE MATERIAL.</p>	PROFESSIONAL CERTIFICATION: I HEREBY CERTIFY THAT THESE DRAWINGS WERE PREPARED OR APPROVED BY ME AND THAT I UNDERLY THE LAWS OF THE STATE OF MARYLAND. NUMBER NO. 62649, EXPIRATION DATE: 11/02/24  DATE: 12/13/23 REVISIOnS: 
<b>DIVISION 6 - WOOD</b> <p>1. ALL FRAMING LUMBER SUCH AS JOIST, HEADER AND TRIMMER SHALL BE #2 SPRUCE/WHITE FIR, 16" ON CENTER. ALL JOISTS SHALL BE SPANNED ACROSS THE SPANS AND SUPPORTED BY APPROVED SPANNING SYSTEMS. ALL JOISTS SHALL BE GRADE OR BETTER. #2GP300 PS. STRUCTURAL JOIST TO BE IN ACCORDANCE WITH NDS AND IBCA SPECIFICATIONS. ALL JOISTS MUST BE SPANNED ACROSS THE SPANS AND SUPPORTED BY APPROVED SPANNING SYSTEMS. OTHER SPECIES USED SHALL NOT EXCEED THE REQUIREMENTS NOTED ABOVE.</p> <p>2. ALL WOOD FRAME EXTERIOR CORNERS SHALL BE LATERALLY BRACED WITH CONTINUOUS STRUCTURAL SHEATHING AS INDICATED ON THE DRAWINGS. EXTERIOR CORNERS SHALL BE SECURED BY APPROVED SPANNING SYSTEMS. ALL EXTERIOR CORNERS SHALL BE IN ACCORDANCE WITH IBCA SPECIFICATIONS. OTHER SPECIES USED SHALL NOT EXCEED THE REQUIREMENTS NOTED ABOVE.</p> <p>3. ALL LAMINATED VENEER LUMBER (AVAIL. AS PIGEON LAM) ON THE DRAWINGS SHALL HAVE THE FOLLOWING PROPERTIES: FEM300 PS, 0.75" x 6.666666666666666 PS (GLOBAL) TO VERSA-LAM 1500 PS.</p> <p>4. MANUFACTURED WOOD AND FLOOR TRIM, HEADERS AND GIRDERS TRIM SHALL BE DESIGNED BY THE TRIM MANUFACTURER AND APPROVED BY THE LOCAL BUILDING OFFICE. ALL DESIGN AND EJECTION SHALL BE IN ACCORDANCE WITH THE MANUFACTURER'S SPECIFICATIONS. ALL MANUFACTURED WOOD AND FLOOR TRIM SYSTEMS REQUIRED FOR STRUCTURAL INTEGRITY OF ROOF TRIM SYSTEMS SHALL BE DESIGNED BY THE TRIM MANUFACTURER.</p> <p>5. ALL GOOD EXPOSED TO THE WEATHER, EXCEPT #3 OR PRIMER GRADE OR REARMS DIRECTLY ON CONCRETE OR MASONRY SHALL BE PRESERVED TREATED WITH APPROVED MATERIALS TO PREVENT DECAY AND INFESTATION BY TERMITE AND INSECT.</p> <p>6. PRE-STOP ALL DUCT CHAMBERS, INCREDIBAR, LAUNDRY CHAMBERS AND SHAFTS AT EACH FLOOR. ALL PARTITIONS OVER A FLOOR TALL ENOUGH TO ALLOW FOR PRE-STOP BLOCKERS INSTALLED AT THE BEARING SPACES OR 4' 0" ABOVE FLOOR. ALL PARTITIONS OVER A FLOOR TALL ENOUGH TO ALLOW FOR PRE-STOP BLOCKERS INSTALLED AT THE BEARING SPACES OR 4' 0" ABOVE FLOOR.</p> <p>7. INSULATORS SHALL BE IN TORSION AND GROVE STRUCTURAL GRADE, GLUED AND HADED TO PLATE FRAMING STUD AND APPROVED STRUCTURAL ADHESIVE AND #6-RING SHANK OR SPIRAL THREAD NAILS SPACED 6" ON CENTER ALONG THE JOISTS AND TRIMMERS AND PARALLEL TO THE STUDS.</p> <p>8. ROOF SHEATHING SHALL BE IN EXTERIOR PLYWOOD AS NOTED ON DRAWINGS.</p> <p>9. ALL GALL PLATES SHALL BE THERMO 2X4 AND SHALL BE ANCHORED INTO FOUNDATION WALL WITH APPROVED GALL PLATE ANCHORS. ANCHORS SHALL BE SPACED 16" ON CENTER AND SPANNED BY A 1/2" DIAMETER HANGER. ANCHORS SHALL BE SPANNED BY A 1/2" DIAMETER HANGER. ANCHORS SHALL BE SPANNED BY A 1/2" DIAMETER HANGER. ANCHORS SHALL BE SPANNED BY A 1/2" DIAMETER HANGER.</p> <p>10. ALL PLATE, JOIST AND BEAM SPANNED OVER SUPPORTING MEMBERS SHALL BE SUPPORTED BY MEANS OF HANGERS AND HANGER PLATES.</p> <p>11. NO STRUCTURAL MEMBER SHALL BE OMITTED, NOTCHED, CUT OUT OR RELOCATED WITHOUT APPROVAL BY THE DESIGNER.</p> <p>12. PARALLEL JOIST CENTERED UNDER ALL PARTITIONS TO PARALLEL TO FLOOR.</p> <p>B. PROVIDED GALL TOP AT 4' 0" ON CENTER BETWEEN THE JOIST AND FIRST INTERIOR PARALLEL JOIST. C. 1/2" DIAMETER HANGER PLATE SPANNED OVER THE GALL TOP PLATE THAT IS SPANNED A LENGTH OF 4' 0". D. SPLICES SHALL OCCUR 6' 0" DIRECTLY OVER STUD.</p> <p>B. ALL HANGERS AND HANGER PLATES ARE TO BE SPANNED.</p> <p>13. WOOD STAIRS AND RAMPS:</p> <p>A. STAIRWAYS SHALL BE DESIGNED TO SUPPORT THE FIRMEST DESIGN LOADS LISTED IN DIVISION 1 AND SHALL HAVE A THICKNESS OF 1" AT THE DECK AND 1" AT THE Treads. THE DECK AND Treads SHALL BE SPANNED BY THE STAIR RISERS.</p> <p>B. RISERS SHALL HAVE A MAXIMUM RISER HEIGHT OF 7" AND MAXIMUM TREAD DEPTH OF 10" MEASURED HORIZONTALLY FROM NOSING TO NOSING.</p> <p>C. STAIRS SHALL BE DESIGNED SO THAT THE RISE OF STAIRS HAVING TWO OR MORE RISERS, HORIZONTAL LENGTH MEASURED VERTICALLY ABOVE STAR NOSING SHALL BE 100% 54" BUT NOT GREATER THAN 50". RISERS SHALL NOT EXCEED 7" IN DEPTH AND 10" IN LENGTH. Treads SHALL NOT EXCEED 10" IN DEPTH AND 10" IN DIAMETER AND 7" DIAMETER HANGERS.</p> <p>D. ALL STAIRS SHALL BE DESIGNED TO SUPPORT THE TOTAL FLOOR LOAD OF 400 LB/SF.</p> <p>E. GUARDRAILS SHALL BE PRIMER 1/4" IN HEIGHT MEASURED VERTICALLY FROM THE SLOPED PLANE OF THE TREAD. GUARDRAILS SHALL BE PRIMER 1/4" IN HEIGHT MEASURED VERTICALLY FROM THE SLOPED PLANE OF THE TREAD. GUARDRAILS SHALL BE PRIMER 1/4" IN HEIGHT MEASURED VERTICALLY FROM THE SLOPED PLANE OF THE TREAD.</p> <p>F. VERICAL LOAD TRANSFER: ALL STRUCTURAL POST MUST BE VERTICALLY ALIGNED AND BLOCKED TO PROVIDE CONTINUOUS BEARING TO FOUNDATION. PROVIDE DOUBLE STUDS AT EIDS OF ALL BEAMS AND LUMBER UNLESS OTHERWISE NOTED. COLLECTIVE LOADS ARE TO BE SPANNED BY THE STAIR RISERS.</p> <p>G. STEEL CHANNELS USED AS REINFORCE: NAILS POKED INTO STEEL SHALL NOT EXCEED 1/8" WIDTH OF THE ANG. NO/14 DPN IN THE TOP OR BOTTOM OF JOIST AND BEAMS. NAILS SHALL NOT EXCEED 1/8" IN DEPTH OF THE FIBER AND SHALL NOT BE LOCATED ON THE HOOLES OF THE BEAM. NAILS BORN ON OR SET INTO JOIST AND BEAMS SHALL NOT EXCEED 1/8" IN DEPTH. REINFORCE TOP PLATES WITH #6 GAUGE, 1" METAL TEES WHERE CUTTING EXCEEDS MORE THAN 1/8" IN THEIR LENGTH.</p> <p>14. STUD COUNT: QUANTITY FOR Headers IS NUMBER OF JACK STUDS. ADD 1 KING TO OPENING LESS THAN 4' AND 2 KING STUDS FOR OPENINGS GREATER THAN 4'.</p>	<b>DIVISION 11 - EQUIPMENT</b> NOT APPLICABLE  <b>DIVISION 12 - FURNISHINGS</b> NOT APPLICABLE  <b>DIVISION 13 - SPECIAL CONSTRUCTION</b> NOT APPLICABLE  <b>DIVISION 14 - CONVENTING SYSTEMS</b> NOT APPLICABLE  <b>DIVISION 15 - MECHANICAL/PLUMBING</b> <p>1. ALL WORK AND MATERIAL SHALL CONFORM TO INTERNATIONAL PLUMBING CODE (2018 EDITION).</p> <p>2. ALL WORK AND MATERIAL SHALL CONFORM TO INTERNATIONAL MECHANICAL CODE (2018 EDITION).</p> <p>3. THE MECHANICAL AND PLUMBING SYSTEMS SHALL BE DESIGNED AND COORDINATED WITH THE ARCHITECTURAL DRAWINGS INCLUDING OPENINGS IN JOISTS, TRUSSES, CONCRETE, ETC. CONTRACTOR SHALL SEPARATELY SUBMIT A MECHANICAL AND PLUMBING SYSTEMS DESIGN. THE CONTRACTOR SHALL BE RESPONSIBLE TO THE STATE AND LOCAL JURISDICTION IN WHICH THE PROJECT IS BEING CONSTRUCTED.</p> <p>4. EXTERIOR HOME DRAINS SHALL BE FREEZE PROOF TYPE.</p> <p>5. ALL DUCT CHAMBERS, BILLBOARD, LAUNDRY CAVES, METAL PLUES AND VERTICAL SHAPS SHALL BE DRAFTSTOPPED AT EACH PLUGGING/LEAKING LOCATION.</p> <p>6. ALL EXTERIOR ROOF DRAINS TURBINES WITH OPERABLE UNDERS, SHALL BE MECHANICALLY VENTED TO EXTERIOR AIRPORT 10' CFT EXHAUST FAN.</p> <p>7. FURNACE SHALL BE HIGH EFFICIENCY UNIT CAPACITIES 80%.</p>	<b>SUNSET DESIGN</b> SUNSET DESIGN 561 MORAN COURT ANNAPOLIS, MD 21401 PHONE: 410-935-8395 DRAWN BY: MICHAEL STEVENSON
<b>DIVISION 16 - ELECTRICAL</b> <p>1. ALL WORK AND MATERIAL SHALL CONFORM TO NATIONAL ELECTRICAL CODE FOR ONE AND TWO FAMILY DWELLING, NFPA 70-18 (2018 EDITION).</p> <p>2. ALL RECEPTACLES AT KITCHEN COUNTERS, VANITY AND BEIND REFRIGERATOR SHALL BE POSITIONED 41" ABOVE FLOOR. ALL RECEPTACLES AT BATHROOMS, VANITY AND BEIND SINKS SHALL BE POSITIONED 41" ABOVE FLOOR. ALL RECEPTACLES AT BEDROOMS, VANITY AND BEIND SINKS SHALL BE POSITIONED 41" ABOVE FLOOR. ALL RECEPTACLES WITHIN 6' 0" OF SINKS, VANITIES, TUBS, ETC. SHALL BE WIRED TO A GROUND FAULT INTERRUPTED CIRCUIT IN ACCORDANCE TO ELECTRICAL CODE.</p> <p>3. ALL RECEPTACLES IN BEDROOMS TO BE ARC FAULT TYPE.</p> <p>4. ALL OUTLETS, UNLESS NOTED OTHERWISE ON DRAWING, SHALL BE MOUNTED 45" ABOVE FLOOR.</p> <p>5. ALL PLATES AND ACCESSORIES INSTALLED OUTDOORS AND EXPOSED TO THE WEATHER SHALL BE WEATHERPROOF.</p> <p>6. SMOKE DETECTORS SHALL BE PROVIDED IN EACH SLEEPING AREA AND ON EACH LEVEL. DETECTORS SHALL HAVE BATTERY BACK-UP AND BE WIRED TOGETHER FOR SIMULTANEOUS ACTIVATION.</p>	<b>ADDITION/REMODEL FOR SAKLED FAMILY RETREAT</b> BUILDING SITE 3618 FRIENDS ROAD ANNAPOLIS, MD 21401	SHEET 003



PROFESSIONAL STATEMENT OF THE DESIGNER/ARCHITECT I CERTIFY THAT THESE DRAWINGS HAVE BEEN PREPARED OR APPROVED BY ME, AND THAT I AM THE PERSON NAMED ON THE TITLE BLOCK OF THIS DRAWING. NAME: MICHAEL STEVENSON ADDRESS: 3616 FRIENDS ROAD CITY: ANNAPOLIS STATE: MD ZIP: 21401 PHONE: 443-939-5555 LICENSE NO. 16349 EXPIRATION DATE: 11/15/24		DATE: 12/13/23
SHEET	A001	REVISES
ADDITION/REMODEL FOR <b>SALKELD FAMILY RETREAT</b> BUILDING SITE: 3616 FRIENDS ROAD ANNAPOLIS, MD 21401		SUNSET DESIGN Bei MORAN CO., INC. ANNAPOLIS, MD 21401 PHONE: 443-939-5555 DRAWN BY: MICHAEL STEVENSON

PROFESSIONAL CERTIFICATION LIVERY  
COUNTRY THAT THIS DOCUMENT IS ISSUED  
PROMPTED OR APPROVED BY THE  
DRAFTS PERSON OR THE OWNER  
DURING THE COURSE OF THE STATE OF MARYLAND.  
LICENSE NO. 1646. EXPIRATION DATE 11/05/24

ADDITION/REMODEL FOR <b>SALKELD FAMILY RETREAT</b>	SUNSET DESIGN	DATE 12/13/23
BUILDING SITE: 3018 FRIENDS ROAD ANNAPOLIS, MD 21401	EE MORAN COURT ANNAPOLIS, MD 21401 PHONE: 443-399-5555	REVISIONS
	DRAWN BY: MICHAEL STEVENSON	




**REAR ELEVATION**


SCALE: 1/4" = 1'-0"

SHEET  
**A002**

PROFESSIONAL CERTIFICATION STATEMENT I, JAMES M. MORAN, DOCKETS THIS DRAWING AS A PROFESSIONAL DOCUMENT TO THE BEST OF MY KNOWLEDGE AND BELIEF. I CERTIFY THAT THE INFORMATION CONTAINED HEREIN WAS PREPARED AND APPROVED BY ME, AND IS IN ACCORDANCE WITH THE STANDARDS OF PRACTICE OF THE STATE OF MARYLAND AND THE LAWS OF THE STATE OF MARYLAND. LICENSE NO. 16149, EXPIRATION DATE 10/14/24		DATE: 12/1/23
		REVISIONS
		
<b>SUNSET DESIGN</b> 301 MORAN COURT ANNAPOLIS, MD 21401 PHONE: 443-388-5898 DRAWN BY MICHAEL STEVENSON		
<b>ADDITION/REMODEL FOR</b> <b>SALKELD FAMILY RETREAT</b> BUILDING SITE: 3018 FRIENDS ROAD ANNAPOLIS, MD 21401		
		
SHEET <b>A003</b>		



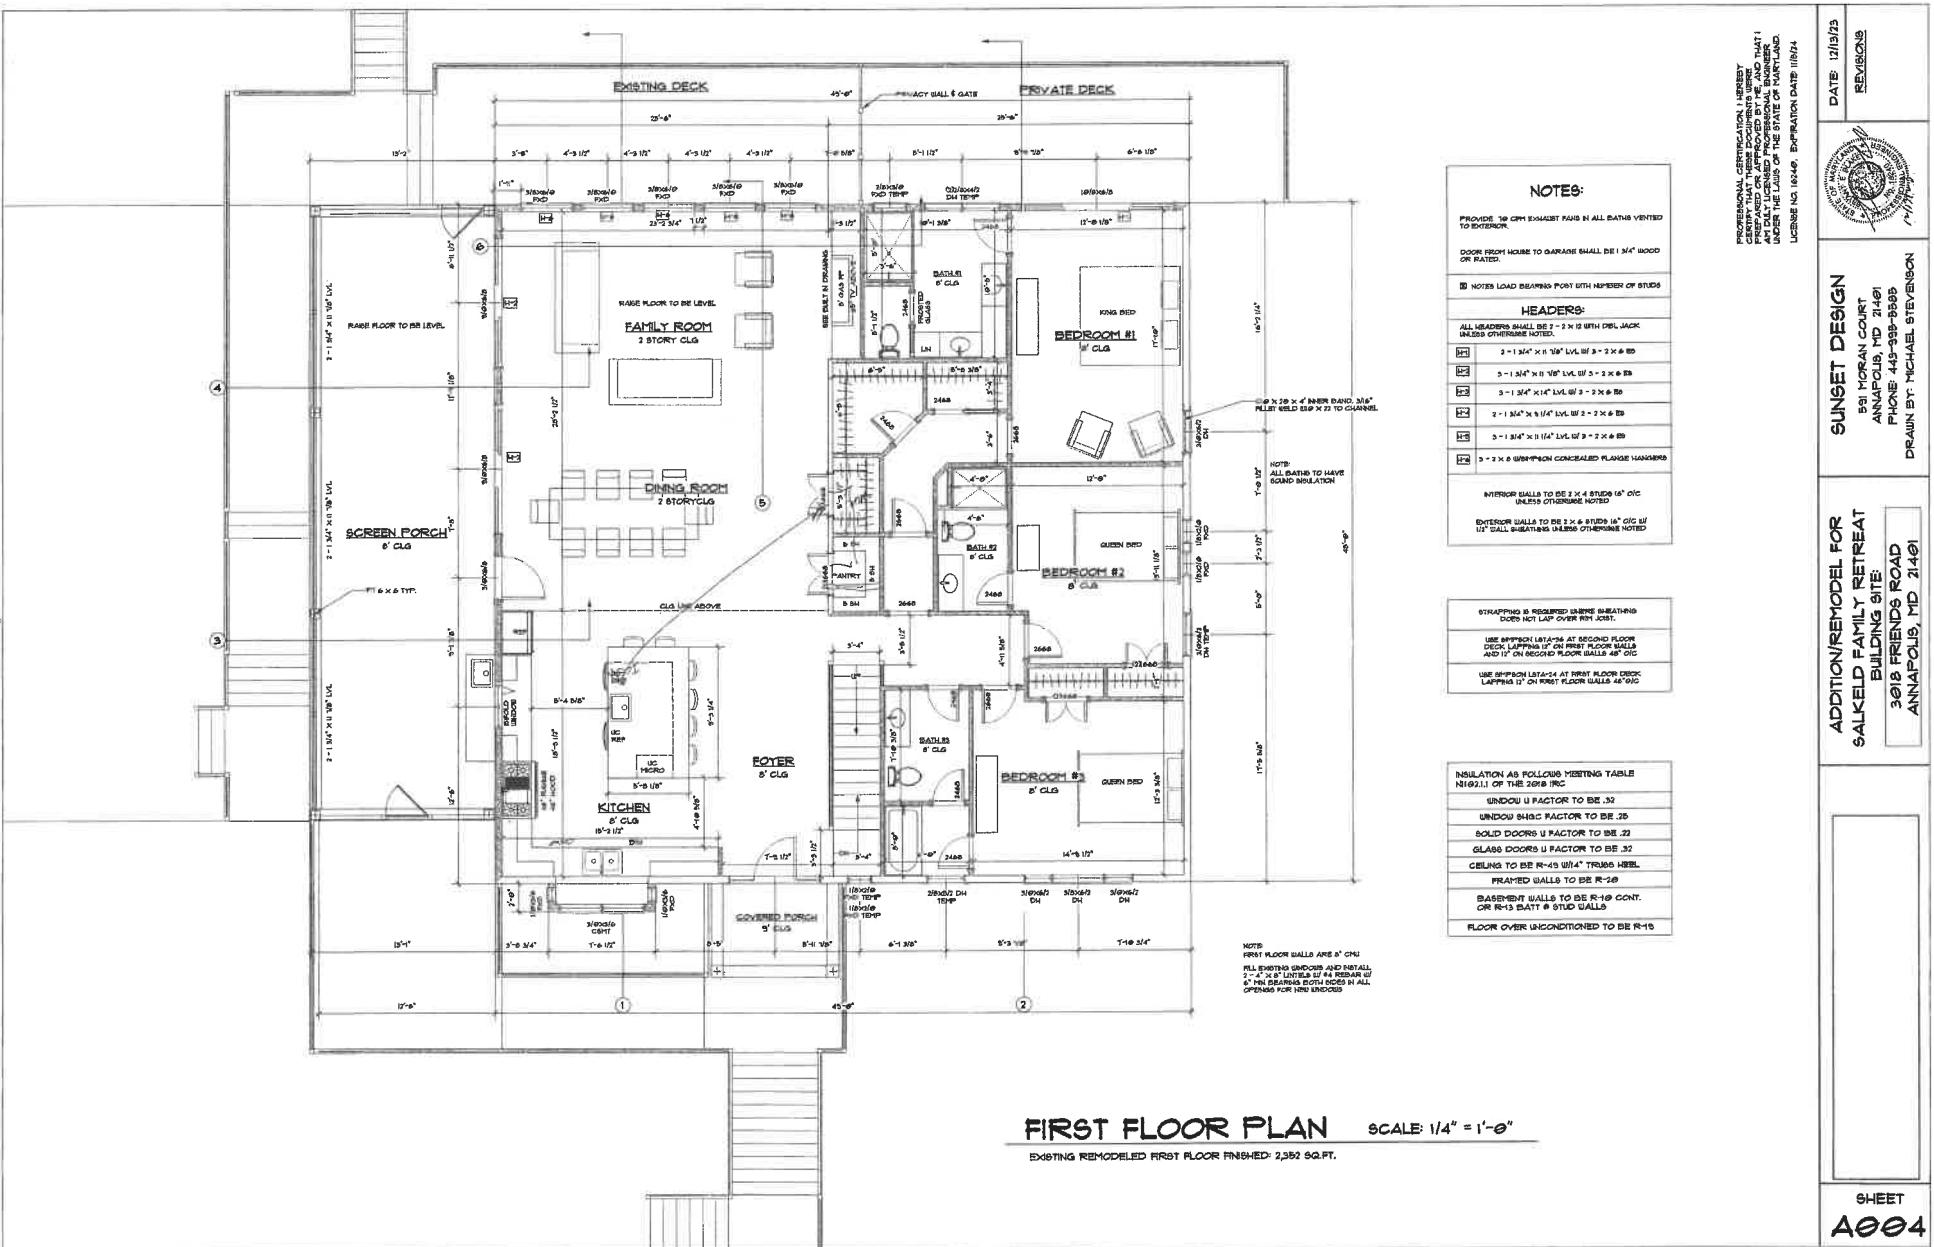

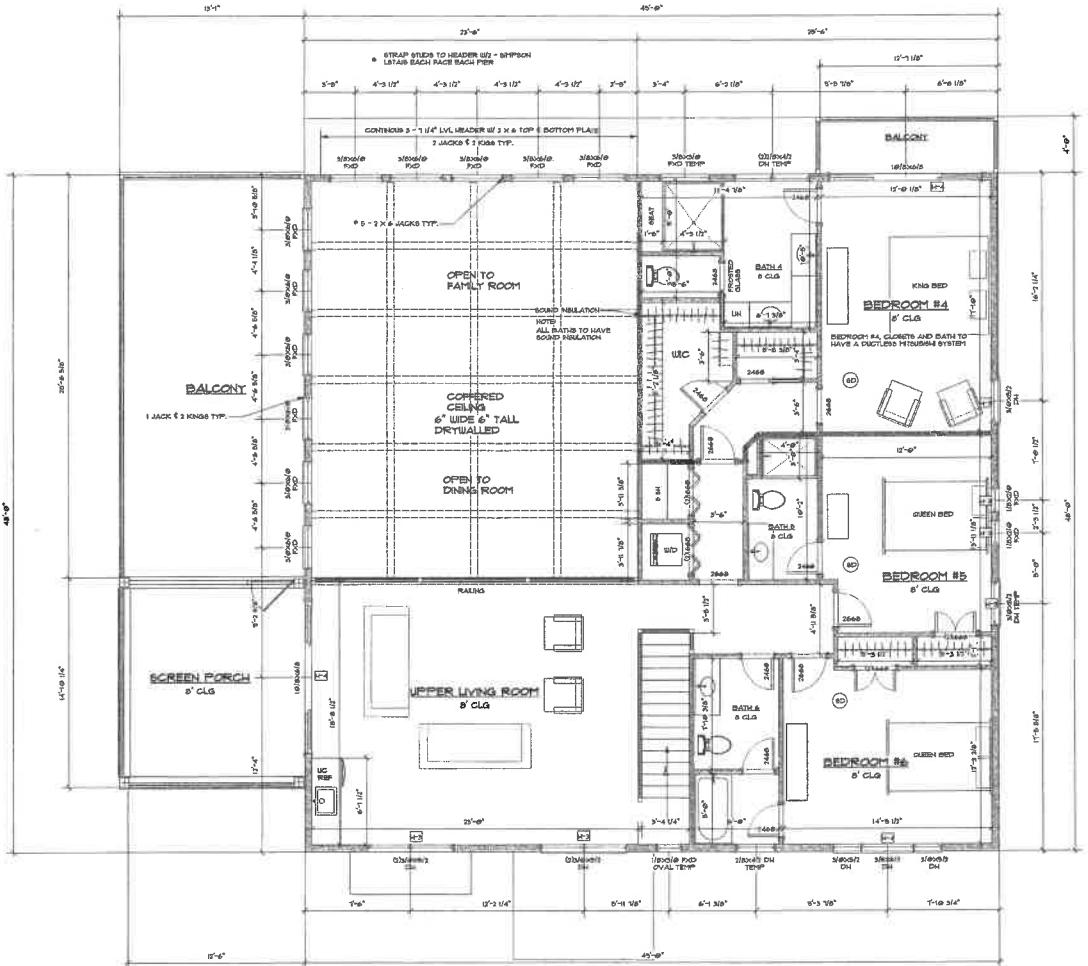

**SECOND FLOOR PLAN**

ADDED SECOND FLOOR FINISHED: 1,616 SQ.FT.

ADDED SECOND FLOOR SCREEN PORCH: 185 SQ.FT.

ADDED SECOND FLOOR OPEN BALCONY: 384 SQ.FT.

ADDED SECOND FLOOR OPEN BR#4 BALCONY: 50 SQ.FT.

SCALE: 1/4" = 1'-0"

PROFESSIONAL CERTIFICATION STATEMENT  
I, MICHAEL STEVENSON, DOB: 10/17/1984, RESIDENCE: 3016 FRIENDS ROAD, ANNAPOLIS, MD 21401,  
HEREBY CERTIFY THAT THE DRAWINGS AND SPECIFICATIONS CONTAINED ON THIS SHEET ARE  
ACCURATE TO THE BEST OF MY KNOWLEDGE AND ABILITY.  
THESE DRAWINGS WERE PREPARED OR APPROVED BY ME AND ARE FOR THE USE OF THE  
OWNER, THE CONTRACTOR, AND THE INSPECTOR ONLY.  
THIS DRAWING WAS PREPARED IN ACCORDANCE WITH THE  
2018 EDITION OF THE INTERNATIONAL RESIDENTIAL CODE.  
LICENSE NO. 16419, EXPIRATION DATE: 11/14/24

ADDITION/REMODEL FOR <b>SALKED FAMILY RETREAT</b>	<b>SUNSET DESIGN</b>
BUILDING SITE: 3016 FRIENDS ROAD ANNAPOLIS, MD 21401	DRAWN BY: MICHAEL STEVENSON

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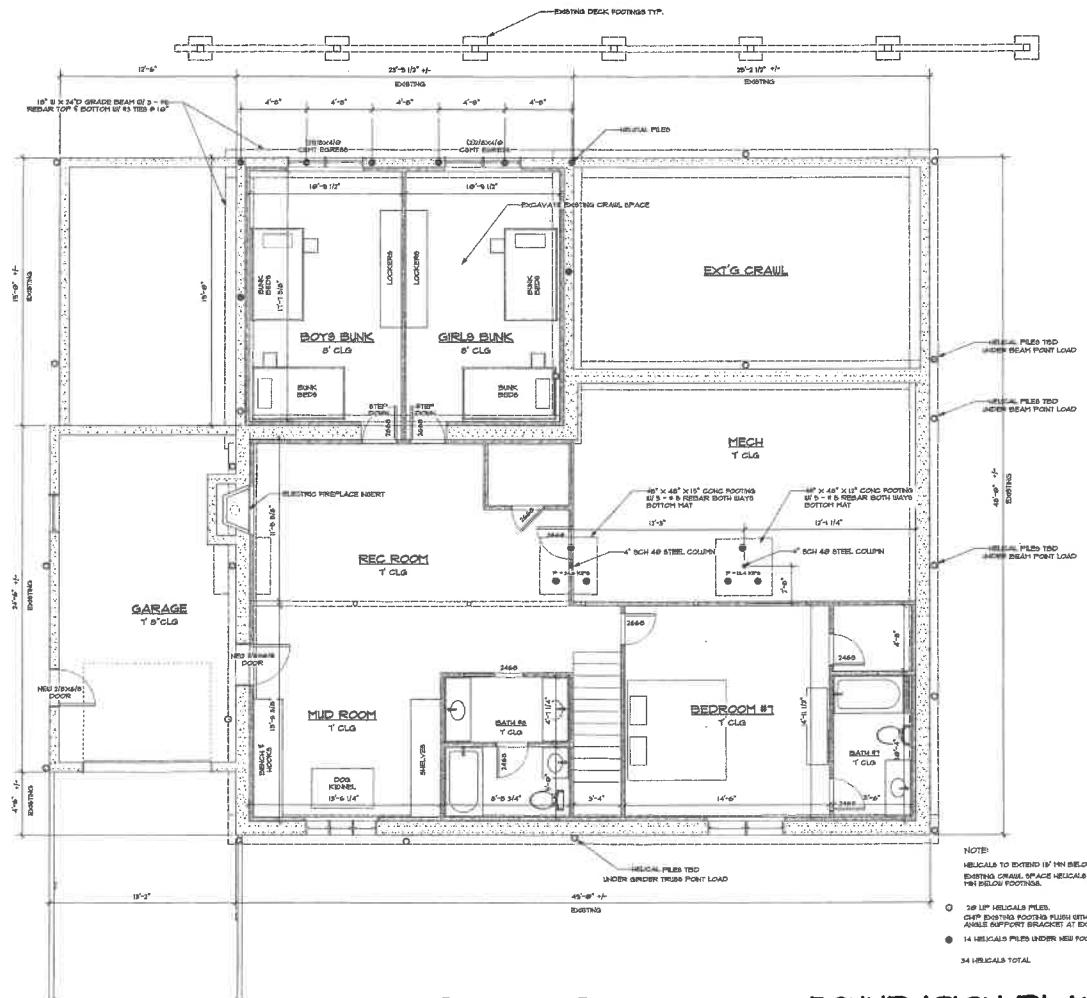
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**A005**

<b>NOTES:</b>	
ALL HEADERS SHALL BE AT 8'-11" ABOVE FLOOR LEVEL UNLESS OTHERWISE NOTED.	
PROVIDE 30 CFM EXHAUST FANS IN ALL BATHS VENTED TO EXTERIOR.	
DO NOT LOAD BEARING POST WITH NUMBER OF STUDS	
<b>HEADERS:</b>	
ALL HEADERS SHALL BE 2 - 2 X 4 ING WITH DEL JACK UNLESS OTHERWISE NOTED.	
<ul style="list-style-type: none"> <li>2 - 1 3/4" x 11 7/8" LVL SFL 2 - 2 X 6 89</li> <li>3 - 1 3/4" x 11 7/8" LVL SFL 3 - 2 X 6 89</li> <li>2 - 1 5/8" x 11 1/4" LVL SFL 2 - 2 X 6 89</li> <li>3 - 1 5/8" x 9 1/4" LVL SFL 3 - 3 X 6 89</li> </ul>	
INTERIOR WALLS TO BE 2 X 4 STUDIO 16" O.C. UNLESS OTHERWISE NOTED.	
EXTERIOR WALLS TO BE 2 X 6 STUDIO 16" O.C. W/ 1/2" WALL SHEATHING UNLESS OTHERWISE NOTED.	

STRAPPING IS REQUIRED WHERE SHEATHING DOES NOT LAP OVER RIM JOIST.
USE SIMPSON LATA-24 AT GROUND FLOOR DECK LAPPING 12" ON FIRST FLOOR WALLS AND 12" ON SECOND FLOOR WALLS 48" O.C.
USE SIMPSON LATA-12 AT FIRST FLOOR DECK LAPPING 12" ON FIRST FLOOR WALLS 48" O.C.

INSULATION TO FOLLOW MEETING TABLE NI-021.1 OF THE 2018IRC
WINDOW U FACTOR TO BE .37
UNCOUPLED SHINGE FACTOR TO BE .25
SOLID DOORS U FACTOR TO BE .22
GGLASS DOORS U FACTOR TO BE .32
CEILING TO BE R-49 UNF TRUSS HEAT FRAMED WALLS TO BE R-20
BASEMENT WALLS TO BE R-19 CONT. OR R-13 Batt & Stud Walls
FLOOR OVER UNCONDITIONED TO BE R-19


DATE: 12/13/23
REVISIONS



## FOUNDATION PLAN

EXISTING FINISHED: 990 SQ.FT.  
ADDITION FINISHED: 400 SQ.FT.

SCALE: 1/4" = 1'-0"
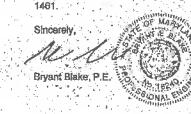
<b>FOUNDATION CERTIFICATION</b>  <b>BLAKE STRUCTURAL</b> <small>Registered in Maryland &amp; Virginia 12510 Ridgely Road Annapolis, MD 21401 Office: (410) 534-0192 Cell: (410) 504-5455</small>		
December 13, 2023 Anne Arundel County Permit Department Subject: Evaluation of Existing Foundation for Additional Load 3018 Friends Road Annapolis, MD 21401 Attention: Building Permit Department  On October 13, 2023, Mr. Bryant Blake inspected a portion of the existing house footing and evaluated the existing bearing soil beneath the footing with a dynamic penetrometer. Based on the inspection, the existing footing is a minimum of 8" thick and 16" wide and sits on medium dense sand with an allowable bearing capacity of 2,000 psf. The penetrometer readings were 6, 11, 11, and 15. The existing soil bearing capacity of the perimeter footing at the checked area is thus 1.33 x 2,000 psf = 2,667 psf.  The grade at the existing house varies greatly and slightly above the tested footing level the soils were much softer. It is a concern of mine that any areas of the existing footing that are bearing at a more shallow depth have less than the 2000 psf soil bearing capacity due to the great variation of soil horizons. At approximately over about 30 feet horizontally and in the area of the rear fall there is concern of failure. In order to eliminate potential soil bearing overspeed and loading adjacent to the slope, I have specified 20 kip capacity x 15' deep minimum helical piles throughout the house foundation to support the added weight and to prevent loading of the rear slope. These helical piles are to be detailed and installed by a company specializing in pile installation.  If you have any questions regarding this evaluation, please contact me at 443-604-1461. Sincerely,  Bryant Blake, P.E.		


ADDITION/REMODEL FOR <b>SALKELD FAMILY RETREAT</b> BUILDING SITE: 3018 FRIENDS ROAD ANNAPOLIS, MD 21401	SUNSET DESIGN <small>SA MORN COURT ANNAPOLIS MD 21401 PHONE: 410-955-9888 DRAWN BY: MICHAEL STEVENSON</small>
DATE: 12/13/23 REVISONS 	



**DEMO NOTES:**  
 DEMO ALL FLOOR COVERINGS  
 DEMO ALL DRYWALL  
 DEMO ALL ELECTRICAL INCLUDING WIRING  
 DEMO ALL PLUMBING INCLUDING WATER & SEWAGE PIPES  
 DEMO ALL HVAC INCLUDING DUCTWORK AND UNITS  
 DEMO KITCHEN INCLUDING APPLIANCES  
 DEMO ROOF INCLUDING SHEATHING AND RAFTERS  
 DEMO ALL INTERIOR FINISHED WALLS  
 DEMO INTERIOR AND EXTERIOR DOORS  
 DEMO EXTERIOR SIDING


PROFESSIONAL LICENSING COMMISSION, MARYLAND  
 CERTIFY THAT THESE DRAWINGS WERE PREPARED BY A PROFESSIONAL ENGINEER OR ARCHITECT  
 PURSUANT TO THE PROFESSIONAL ENGINEERING AND ARCHITECTURAL  
 PRACTICE ACT OF MARYLAND, AND THAT THEY ARE IN ACCORDANCE  
 WITH THE LAWS OF THE STATE OF MARYLAND.  
 LICENSE NO. 16246, EXPIRATION DATE 10/24/24

SUNSET DESIGN	BRI MORAN COURT ANNAPOLIS, MD 21401 PHONE: 443-989-8888	DATE: 12/13/23
ADDITION/REMODEL FOR SALKELD FAMILY RETREAT BUILDING SITE: 3018 FRIENDS ROAD ANNAPOLIS, MD 21401	REVISIONS	

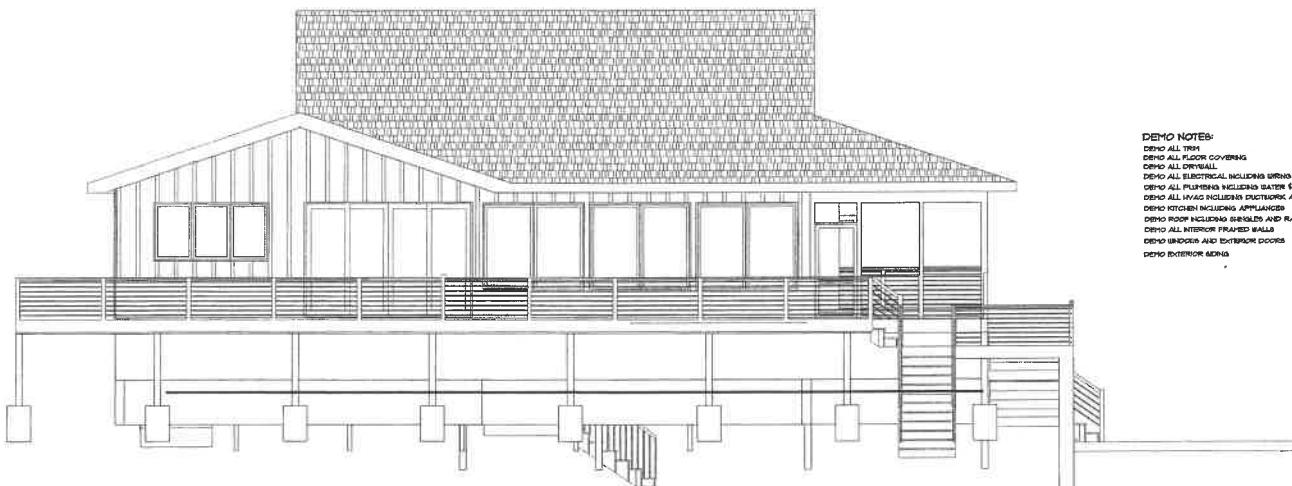


**DEMO NOTES:**  
 DEMO ALL FLOOR COVERINGS  
 DEMO ALL DRYWALL  
 DEMO ALL ELECTRICAL INCLUDING WIRING  
 DEMO ALL PLUMBING INCLUDING WATER & SEWAGE PIPES  
 DEMO ALL HVAC INCLUDING DUCTWORK AND UNITS  
 DEMO KITCHEN INCLUDING APPLIANCES  
 DEMO ROOF INCLUDING SHEATHING AND RAFTERS  
 DEMO ALL INTERIOR FINISHED WALLS  
 DEMO INTERIOR AND EXTERIOR DOORS  
 DEMO EXTERIOR SIDING

SHEET  
**A001**

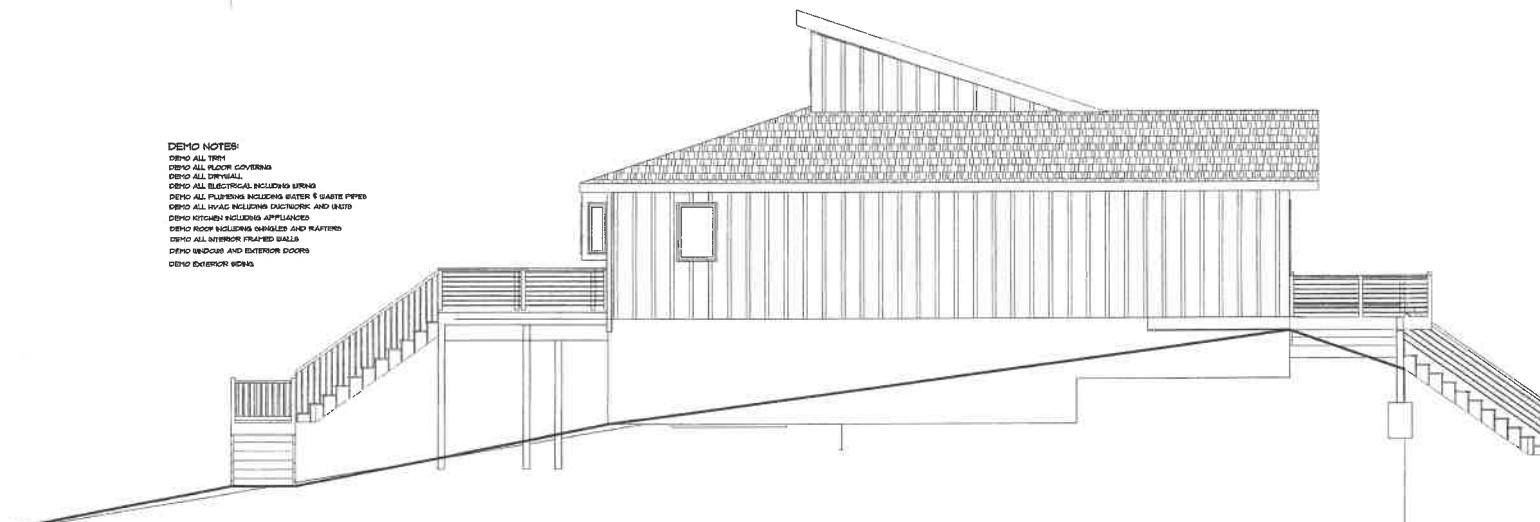

ADDITION/REMODEL FOR SALKELD FAMILY RETREAT BUILDING SITE 301B FRIENDS ROAD ANNAPOLIS, MD 21401	SUNSET DESIGN	DATE: 12/13/23
	REVISIONS	

**SHEET**  
**A008**

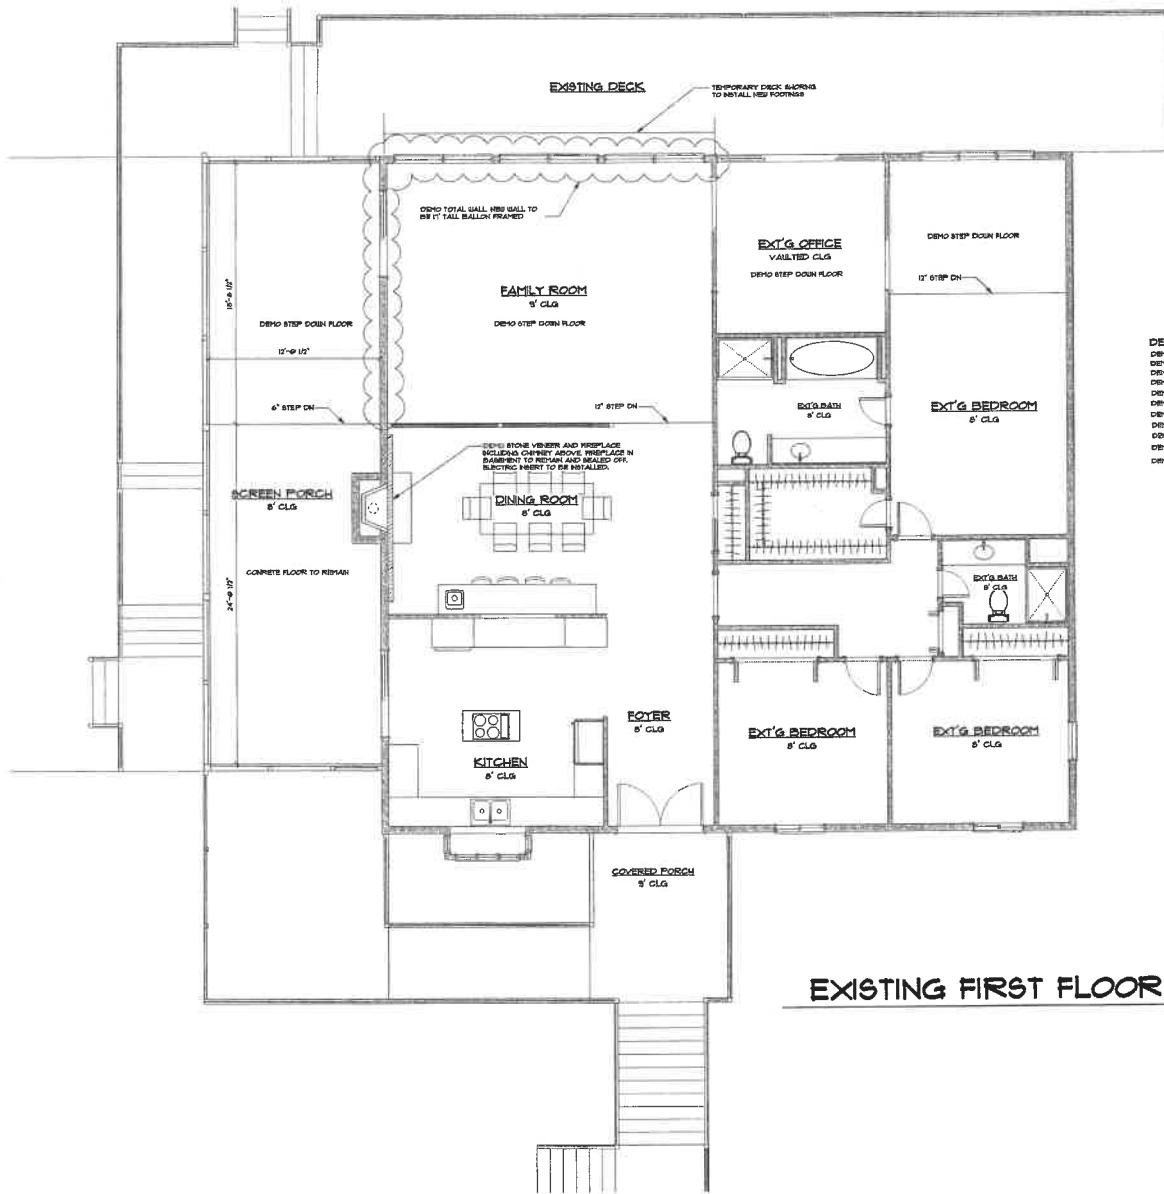

### EXISTING FIRST FLOOR & DEMO

SCALE: 1/4" = 1'-0"

ADDITION/REMODEL FOR SALKELD FAMILY RETREAT BUILDING SITE: 3618 FRIENDS ROAD ANNAPOLIS, MD 21401	SUNSET DESIGN 99 MORAN COURT ANNAPOLIS, MD 21401 PHONE: 443-925-3555 DRAWN BY: MICHAEL STEVENSON	DATE: 12/3/23 REVISIONS:
SHEET <b>A009</b>		

PROFESSIONAL CERTIFICATION I HEREBY  
CERTIFY THAT THIS DOCUMENT IS TRUE  
AND CORRECT TO THE BEST OF MY KNOWLEDGE  
AND DULY SIGN THIS DOCUMENT IN THE CITY OF ANNAPOLIS,  
UNDER THE SEAL OF THE STATE OF MARYLAND,  
LICENSE NO. 16249. EXPIRATION DATE 11/1/24



PROFESSIONAL CERTIFICATION I HEREBY  
CERTIFY THAT THESE DOCUMENTS ARE  
TRUE AND CORRECT TO THE BEST OF MY  
KNOWLEDGE AND BELIEF.  
UNDER THE LAWS OF THE STATE OF MARYLAND,  
LICENSE NO. 16249, EXPIRATION DATE 01/24


DATE: 12/13/23  
REVISIONS  




**SUNSET DESIGN**  
BRI MORAN COURT  
ANNAPOLIS, MD 21401  
PHONE: 443-930-5585  
DRAWN BY: MICHAEL STEVENSON

**ADDITION/REMODEL FOR**  
**SALKELD FAMILY RETREAT**  
**BUILDING SITE:**  
**3018 FRIENDS ROAD**  
**ANNAPOLIS, MD 21401**

**SHEET**  
**A010**

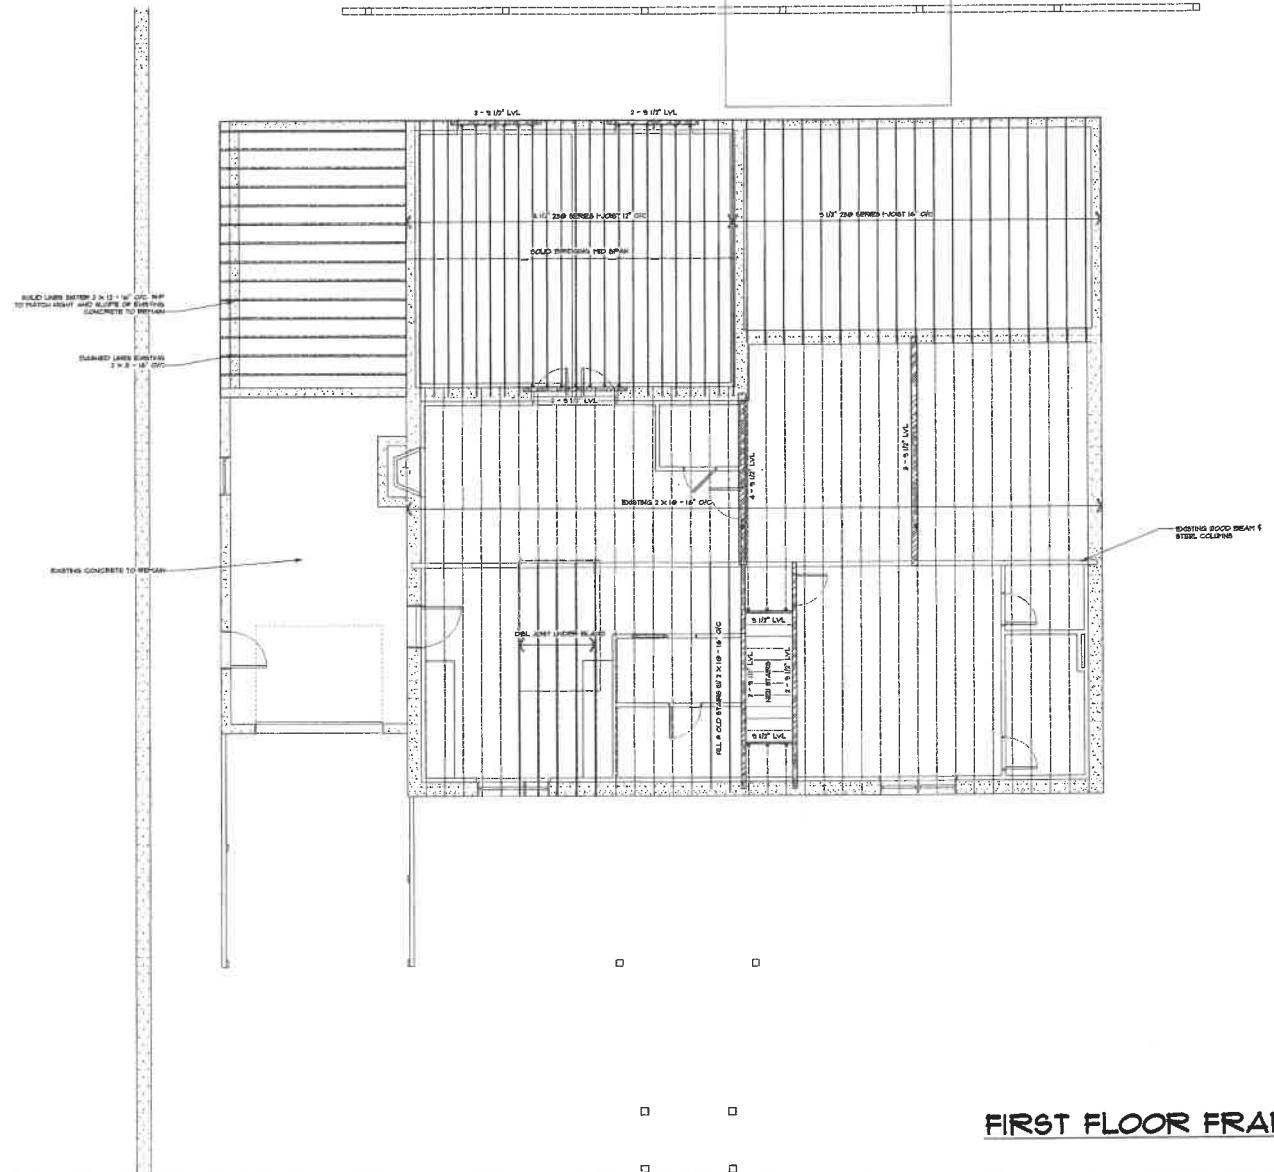


FIRST FLOOR FRAMING PLAN

SCALE: 1/4" = 1'-0"



SHEET  
5001


PROFESSIONAL CERTIFICATION: I HEREBY  
CERTIFY THAT THESE DOCUMENTS WERE  
PREPARED OR DRAWN BY ME OR IN MY AUTHORITY  
UNDER THE LAWS OF THE STATE OF MARYLAND.  
LICENSE NO. 16249, EXPIRATION DATE 11/24


ADDITION/REMODEL FOR SALKELD FAMILY RETREAT BUILDING SITE: 3618 FRIENDS ROAD ANNAPOLIS, MD 21401		SUNSET DESIGN	DATE: 12/13/23
			REVISIONS 

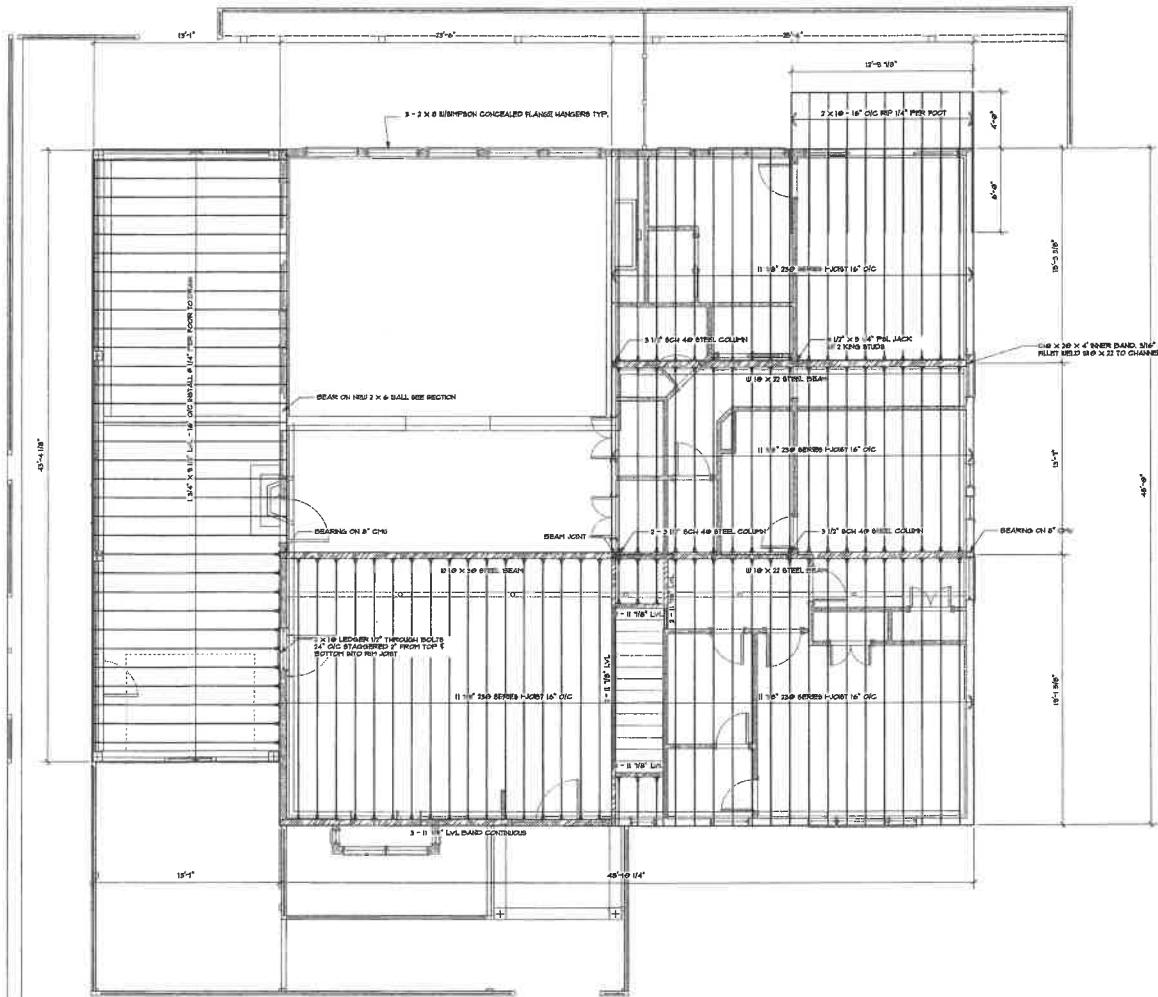

PROFESSIONAL CERTIFICATION STATEMENT CERTIFY THAT THESE DOCUMENTS ARE PREPARED FOR AND APPROVED BY THE OWNER FOR USE IN THE STATE OF MARYLAND UNDER THE LAWS OF THE STATE OF MARYLAND. LICENSE NO. MD046 EXPIRATION DATE 11/16/24		
	DATE: 12/13/23	REVISIONS:
ADDITION/REMODEL FOR SALKELD FAMILY RETREAT	SUNSET DESIGN	
Bldg. Site: 3018 FRIENDS ROAD ANNAPOLIS, MD 21401	Bei MORAN COURT ANNAPOLIS, MD 21401 PHONE: 443-398-5888	DRAWN BY: MICHAEL STEVENSON
SHEET 5002		

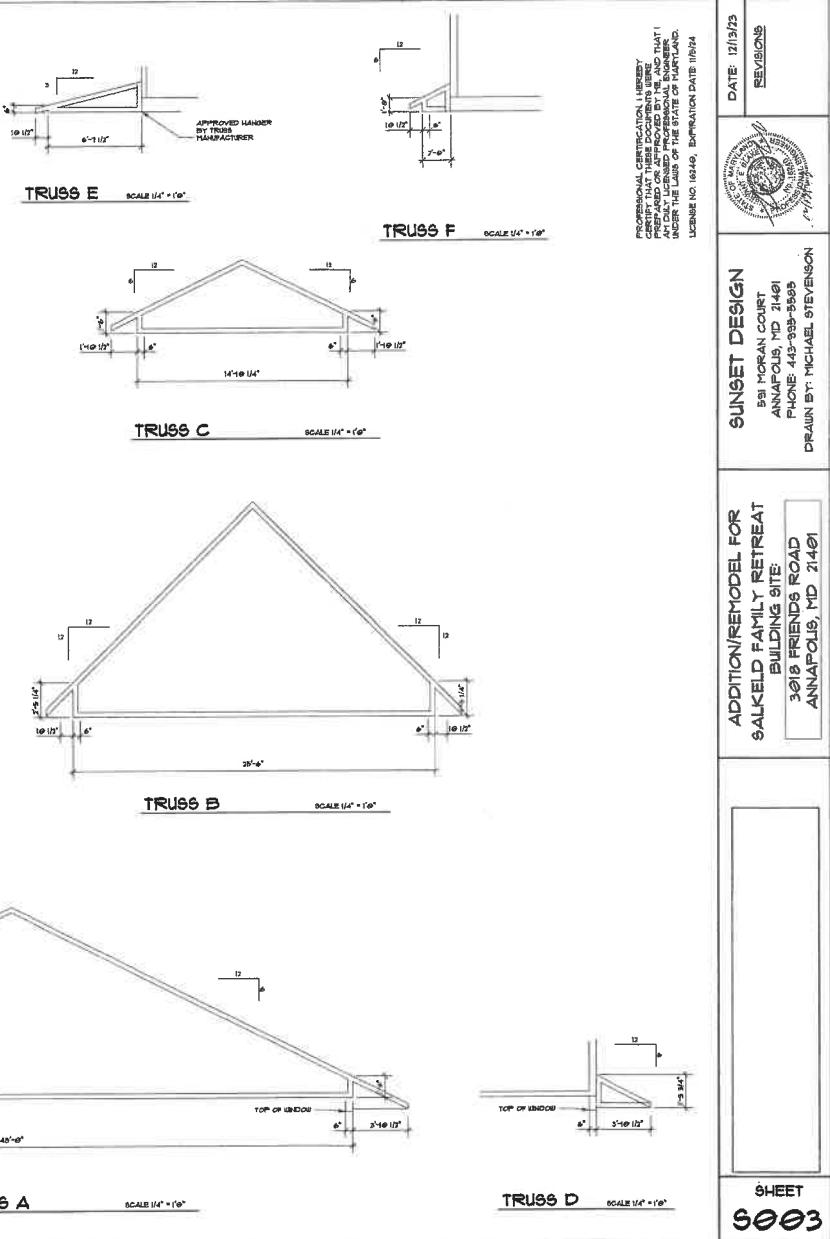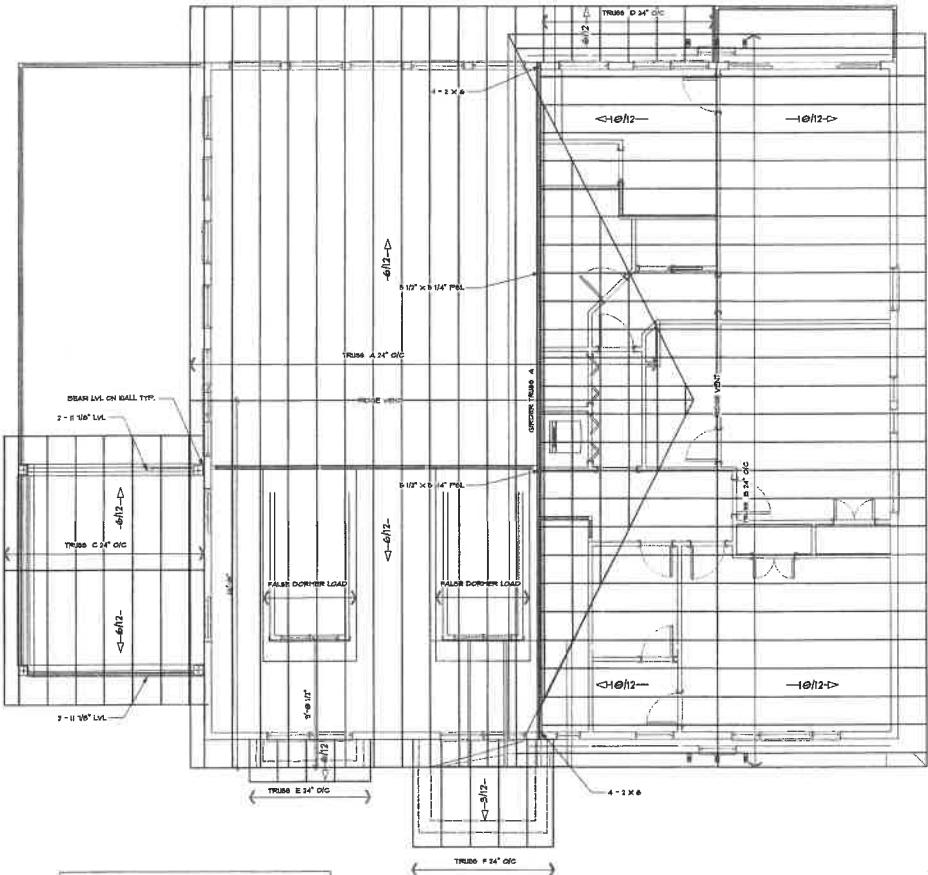


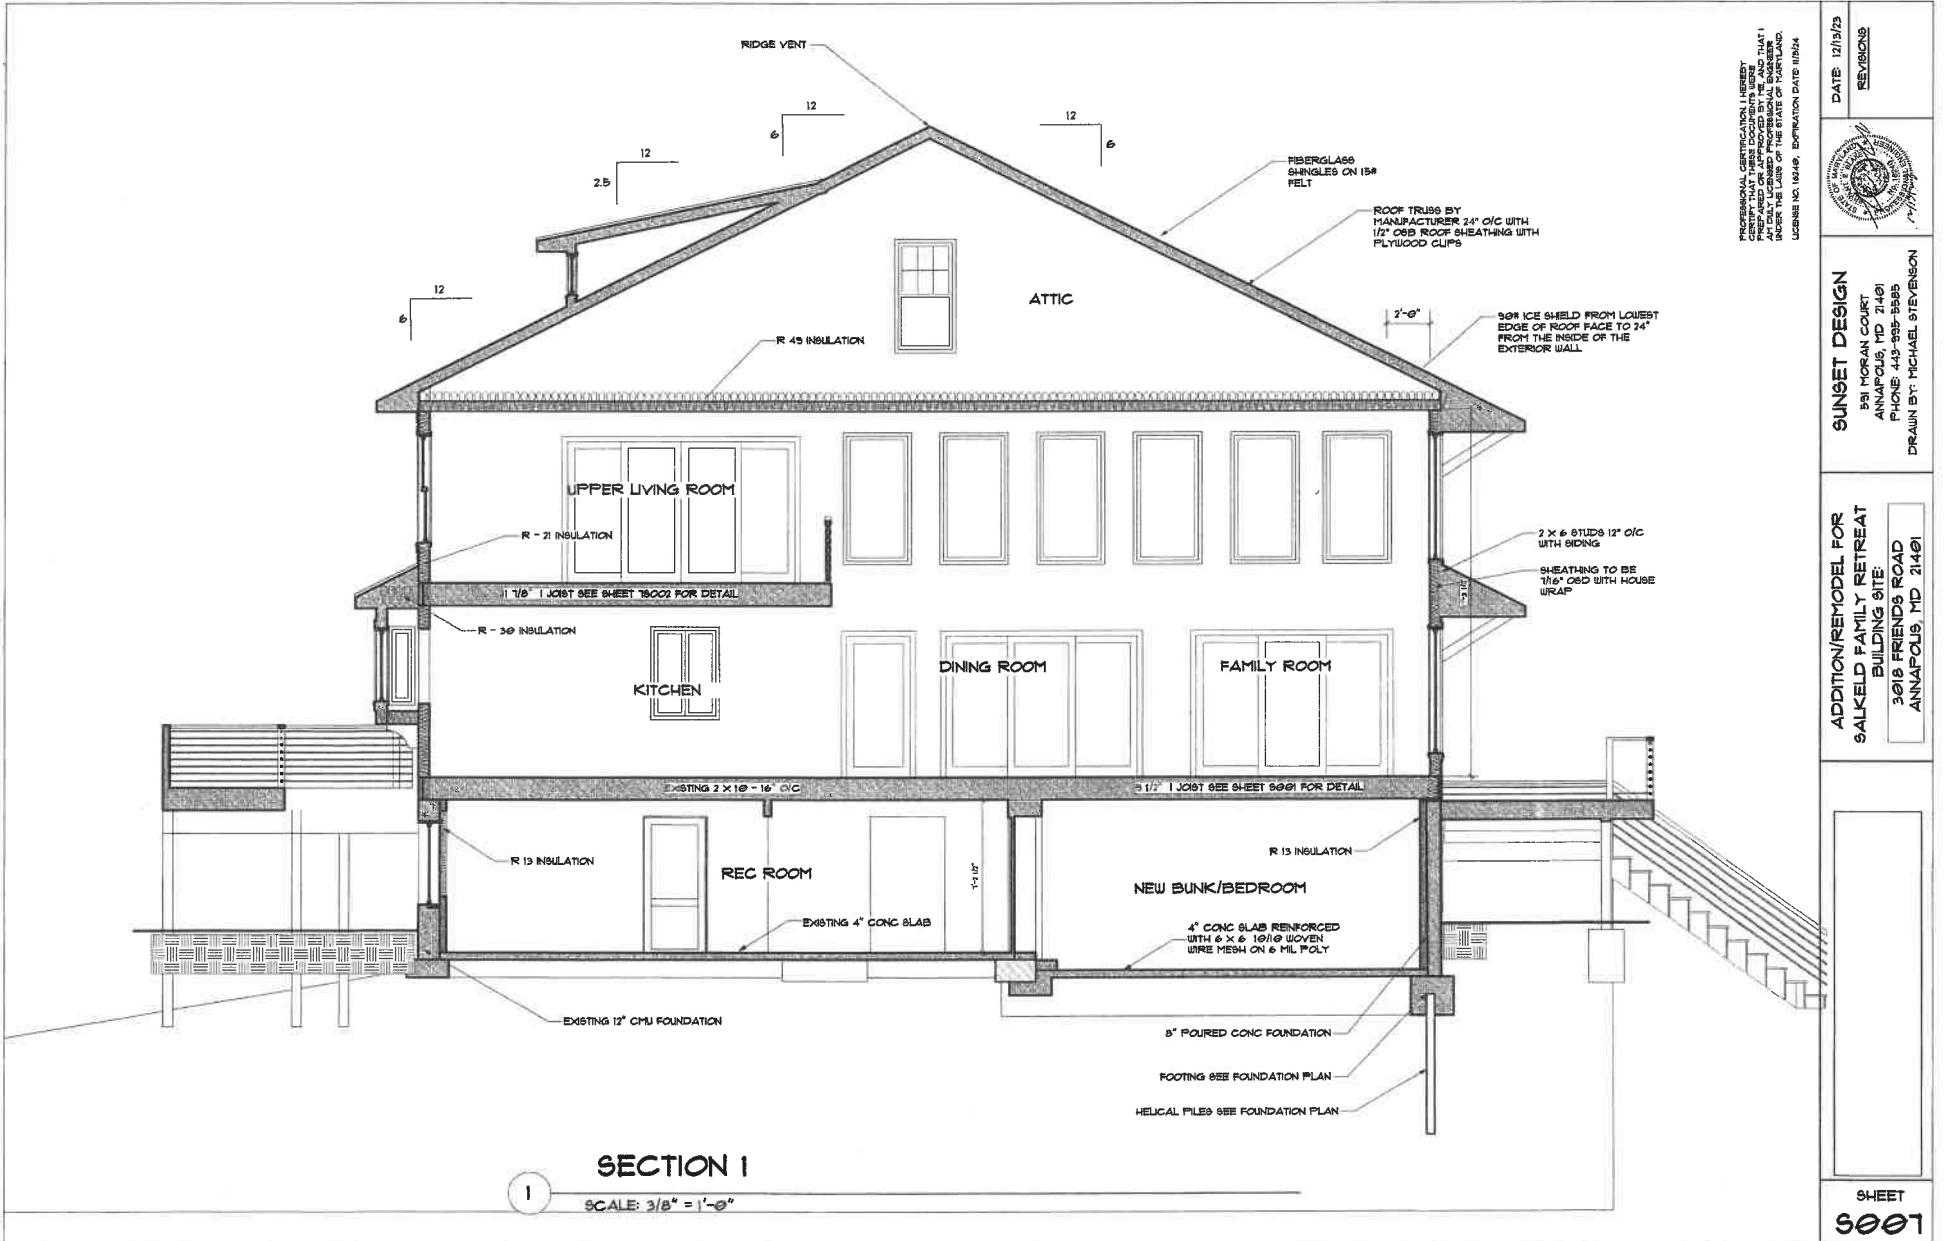

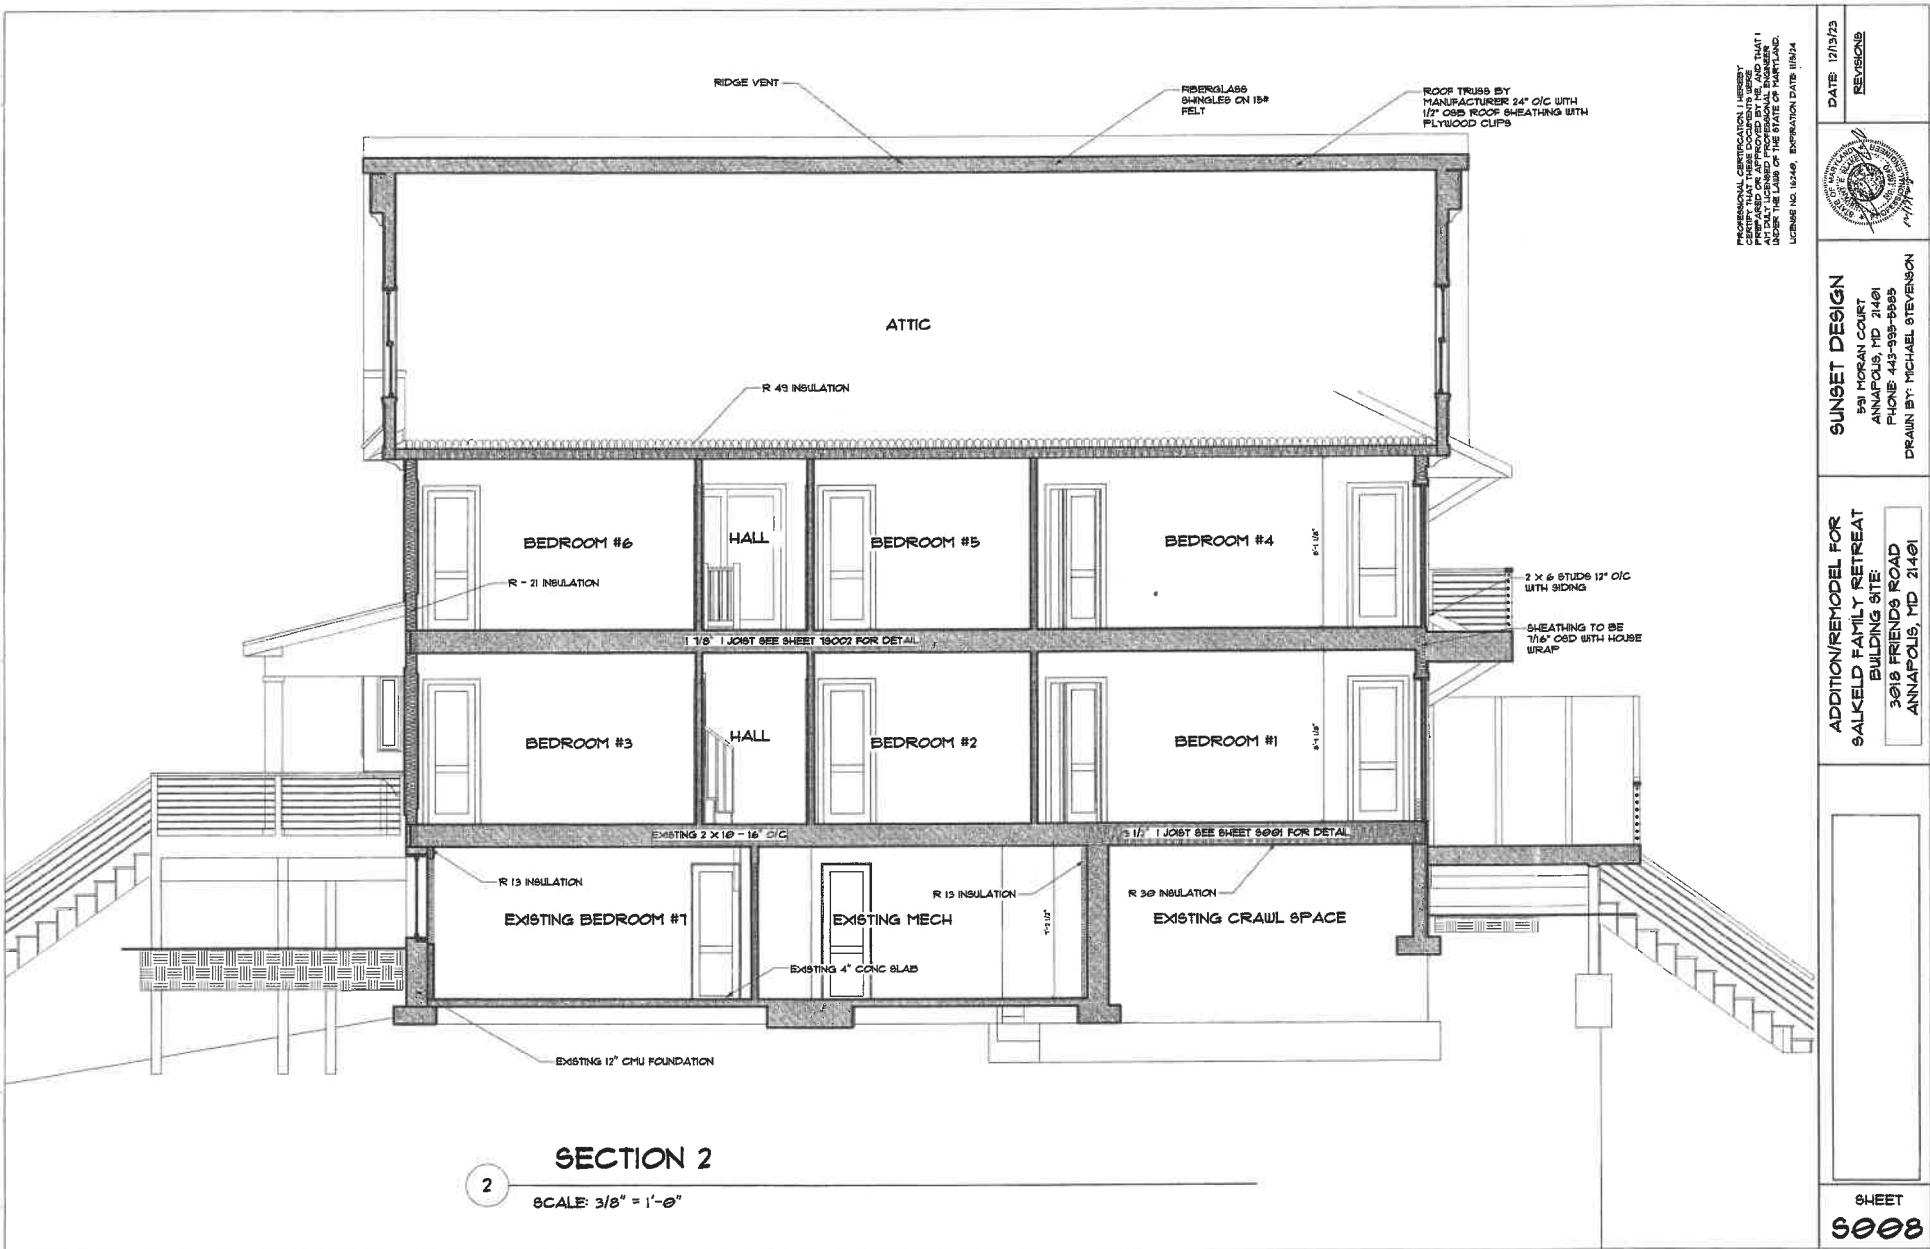


PROFESSIONAL CERTIFICATION STATEMENT  
CERTIFY THAT THESE DOCUMENTS WERE PREPARED BY ME OR UNDER MY SUPERVISION AND THAT I AM RESPONSIBLE FOR THE CONTENTS OF THESE DOCUMENTS.  
AND FOR THE CONSTRUCTION THEREOF, IN ACCORDANCE WITH THE STANDARDS OF PRACTICE RECOMMENDED BY THE SOCIETY OF PROFESSIONAL CIVIL ENGINEERS AND ARCHITECTS AND FOR CONSTRUCTION IN ACCORDANCE WITH THE CODES AND STANDARDS OF THE STATE OF MARYLAND.  
LICENSURE NO. 16240, EXPIRATION DATE: 11/19/24

ADDITION/REMODEL FOR SALKED FAMILY RETREAT BUILDING SITE 3018 FRIENDS ROAD ANNAPOLIS, MD 21401	SUNSET DESIGN	DATE: 12/15/23
	REVISIONS	REVISIONS

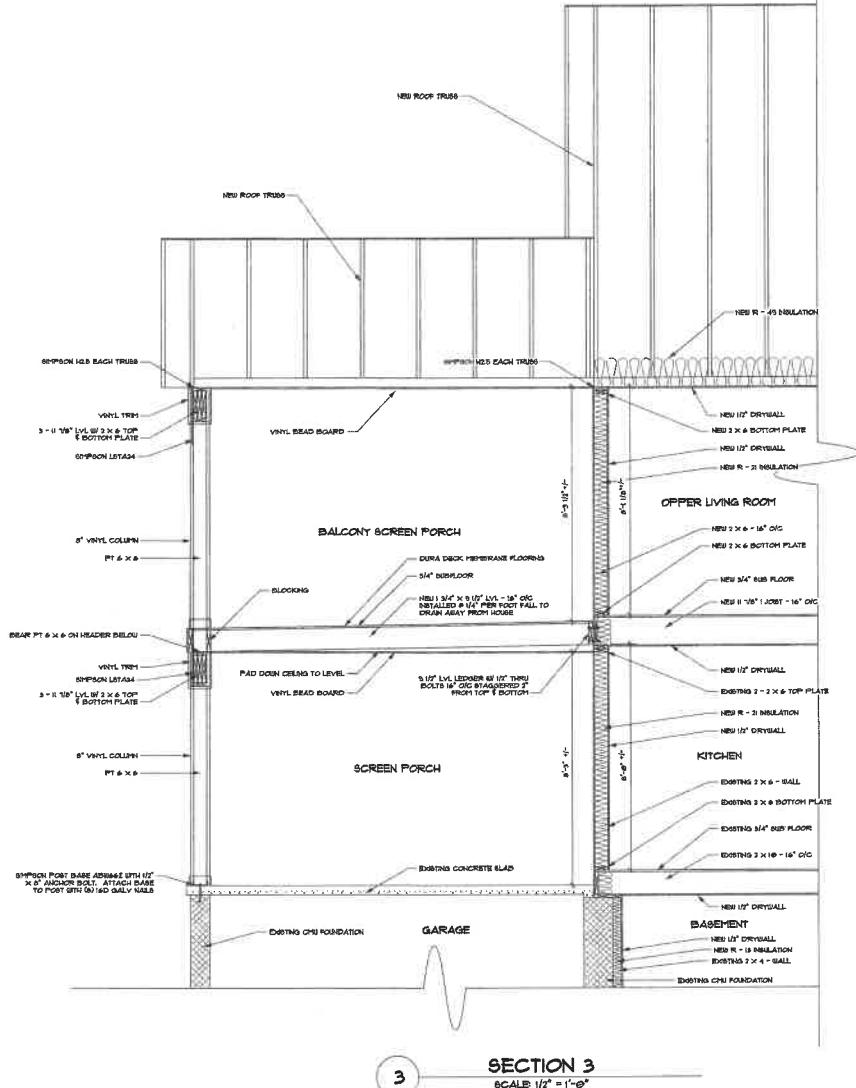

PROFESSIONAL CERTIFICATION STATEMENT  
CERTIFYING THAT THESE DRAWINGS WERE PREPARED AND DRAWN BY ME, AND THAT I AM FULLY LICENSED PROFESSIONAL ENGINEER  
UNDER THE LAWS OF THE STATE OF MARYLAND.  
LICENSE NO. 10449, EXPIRATION DATE 11/01/24

ADDITION/REMODEL FOR SALKELD FAMILY RETREAT BUILDING SITE: 3018 FRIENDS ROAD ANNAPOLIS, MD 21401	SUNSET DESIGN	DATE 12/19/23
		REVISIONS 

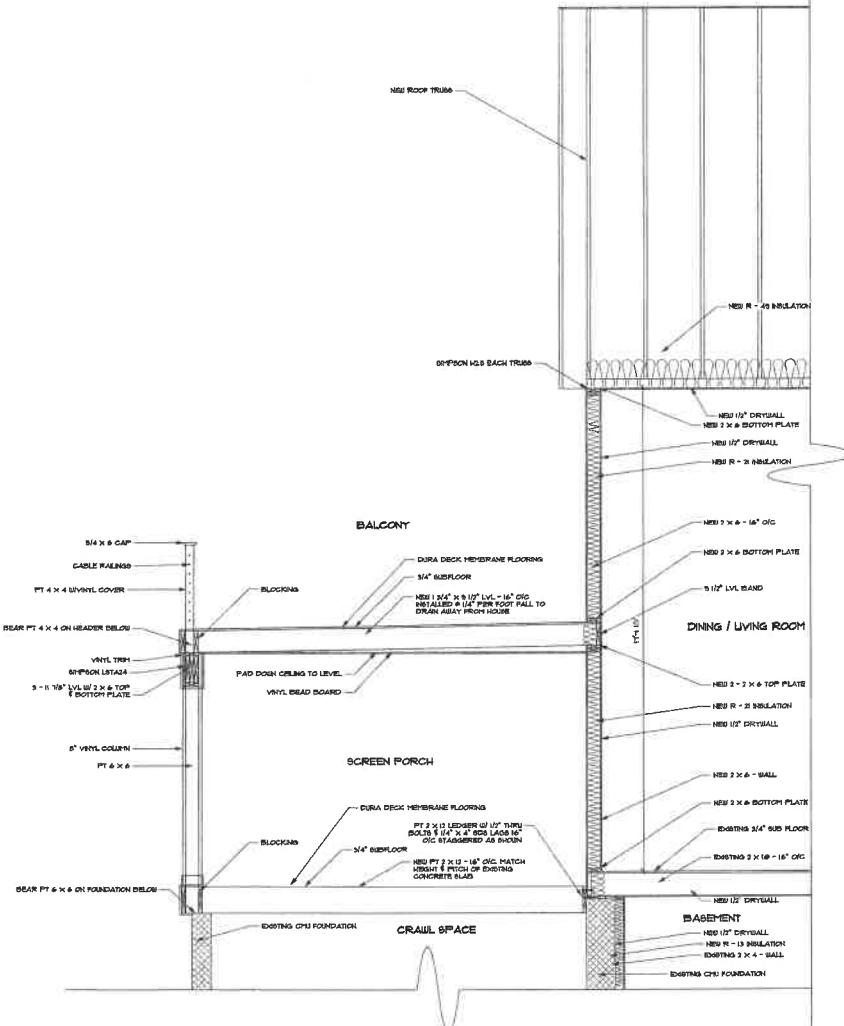

4

SECTION 4  
SCALE: 1/2" = 1'-0"

SHEET  
5010

PROFESSIONAL CERTIFICATION STATEMENT  
CERTIFY THAT THESE DOCUMENTS IN SERIES  
WERE DRAWN OR APPROVED BY ME AND  
UNDER THE LAW OF THE STATE OF MARYLAND,  
LICENCE NO. 16146, EXPIRATION DATE: 11/03/24



DATE: 12/13/23  
REVISIONS:



BRI MORAN COURT  
ANNAPOLIS MD 21401  
PHONE: 443-358-0555  
DRAWN BY: MICHAEL STEVENSON

ADDITION/REMODEL FOR SALKELD FAMILY RETREAT BUILDING #TE: 3618 FRIENDS ROAD ANNAPOLIS, MD 21401		SUNSET DESIGN
		<p>ATTIC</p> <p>NEW R - 45 INSULATION</p> <p>NEW 1/2" DRYWALL</p> <p>NEW 2 - 2 x 6 TOP PLATE 3 - 1 1/2" LVL</p> <p>NEW 1/2" DRYWALL</p> <p>30 x 6/8 FWD SINGLES</p> <p>NEW 2 x 6 - 16" O/C</p> <p>NEW R - 31 INSULATION</p> <p>NEW 2 x 6 BOTTOM PLATE 3 - 1 1/2" LVL</p> <p>50 x 6/8 FWD WINDOW</p> <p>EXISTING 2 x 6</p> <p>3/4" SUBFLOOR</p> <p>NEW 5 1/2" JOIST</p> <p>EXISTING CMU FOUNDATION</p> <p>NEW 1/2" DRYWALL</p> <p>NEW R - 13 INSULATION</p> <p>NEW 2 x 4 - 16" O/C</p> <p>NEW 1/2" DRYWALL</p> <p>EXISTING SLAB</p> <p>1'-0" (0 12")</p> <p>EXISTING FOOTING</p> <p>NEW UNDER PIN FOOTING 12" x 24" @ 2' - 6" REBAR</p> <p>NEW 4" SLAB W/ 6 x 6 UHM ON 6" H. POLY</p> <p>NEW PT 2 x 4 BOTTOM PLATE</p> <p>PEDROLAS SHINGLES ON 16" HLT</p> <p>NEW ROOF TRUSS</p> <p>CHIPTON HLT BACH TRUSS</p> <p>ALUM FASCIA 2 x 6 SUB FASCIA</p> <p>VENTED VINYL SOFFIT</p> <p>NEW FRAMING DETAIL ON SECTION 6</p> <p>NEW ROOF TRUSS</p> <p>1/2" PLYWOOD W/ 8 D HOLE 3" CSC INTO EACH TRUSS BOTTOM CORD</p> <p>1/2" THRU BOLT 16" O/C</p> <p>PT 2 x 8 BUL. PLATE 1/2" x 1/2" ANCHOR BOLT 1/2" FRONT CORNER 2 x 6 O/C</p> <p>NEW 8" CONCRETE FOUNDATION HORIZ 24 REBAR 12" FROM 12" 8" HGT</p> <p>VERT 24 REBAR 16" O/C</p> <p>NEW CONCRETE REANCHORING. SEE FOUNDATION PLAN</p> <p>HELICAL PILES SEE FOUNDATION PLAN</p> <p>SECTION 5 SCALE: 1/2" = 1'-0"</p> <p>5</p>

SHEET  
S011

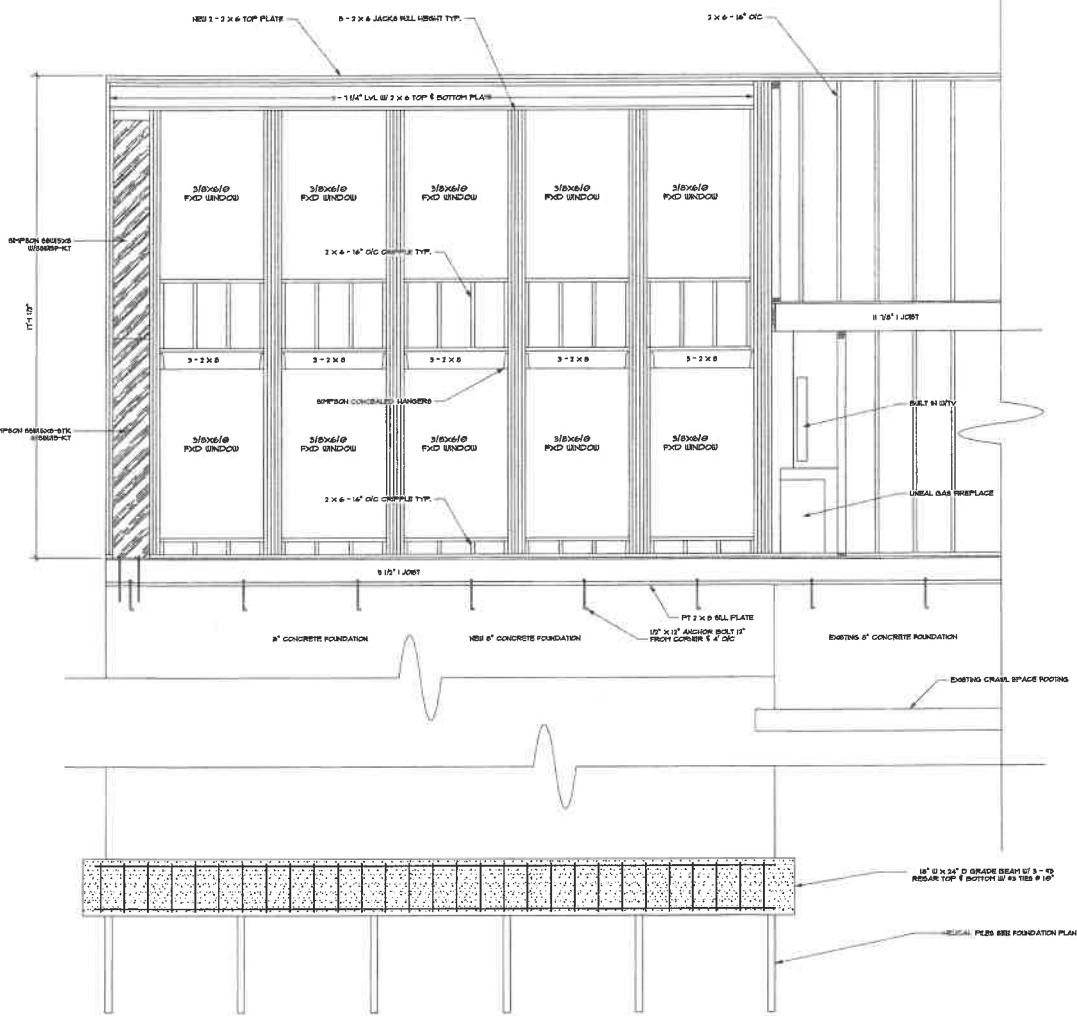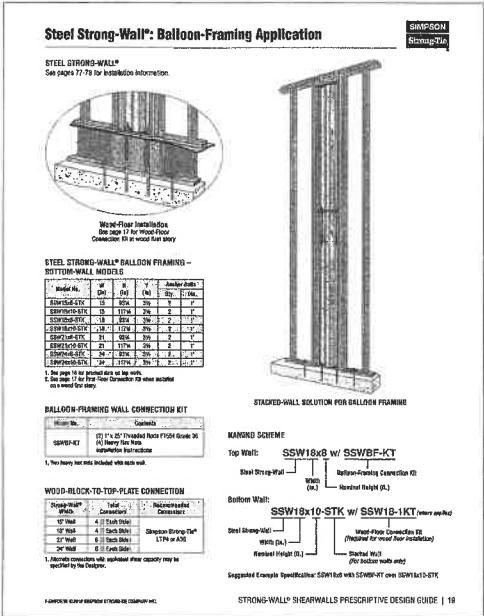

		PROFESSIONAL CERTIFICATION I HEREBY CERTIFY THAT THESE DOCUMENTS ARE THE PROPERTY OF THE STATE OF MARYLAND AND ARE BEING USED OR MAILED BY THE OWNER OR BY THE OWNER'S AUTHORIZED AGENTS FOR THE OWNER'S USE AND INFORMATION ONLY. THIS IS NOT A PUBLIC RECORD. UNDER THE LAW OF THE STATE OF MARYLAND, LICENSE NO. 1646. EXPIRATION DATE 11/24	
		DATE: 12/3/25	
		REVISIONS	
			RECEIVED STATE OF MARYLAND DEPARTMENT OF AGRICULTURE DIVISION OF MIGRATION REGISTRATION
ADDITION/REMODEL FOR SALKELD FAMILY RETREAT BUILDING SITE: 3015 FRIENDS ROAD ANNAPOLIS, MD 21401		SUNSET DESIGN By MORAN COURT ANNAPOLIS, MD 21401 PHONE: 343-525-5555 DRAWN BY: MICHAEL STEVENSON	
		SHEET S012	


PROFESSIONAL CERTIFICATE OF LICENSE  
CERTIFY THAT THESE DOCUMENTS ARE  
PREPARED OR APPROVED BY ME, AND  
IN CONFORMITY WITH THE LAWS OF THE STATE OF MARYLAND,  
LICEN. NO. #9249, EXPIRATION DATE 10/24

DATE: 12/3/23

REVISIONS




BAI MORAN COURT  
ANNAPOLIS, MD 21401  
PHONE: 410-962-5555  
DRAWN BY: MICHAEL STEVENSON

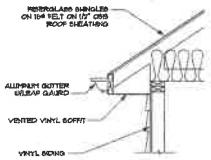


EAVE CORNICE DETAIL

SCALE: 3/4" = 1'-0"

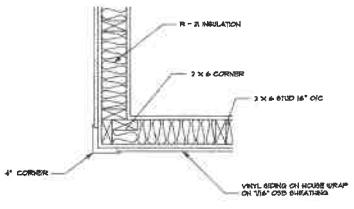


CORNER VINYL DETAIL

SCALE: 1-1/2" = 1'-0"

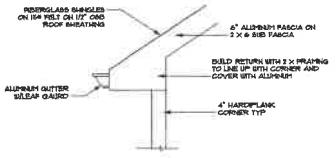


EAVE RETURN DETAIL

SCALE: 3/4" = 1'-0"

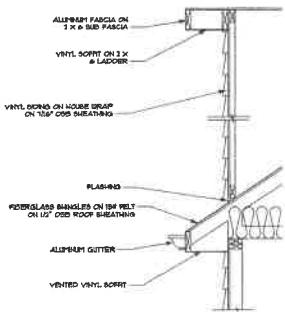

GABLE WITH SIDING

SCALE: 3/4" = 1'-0"

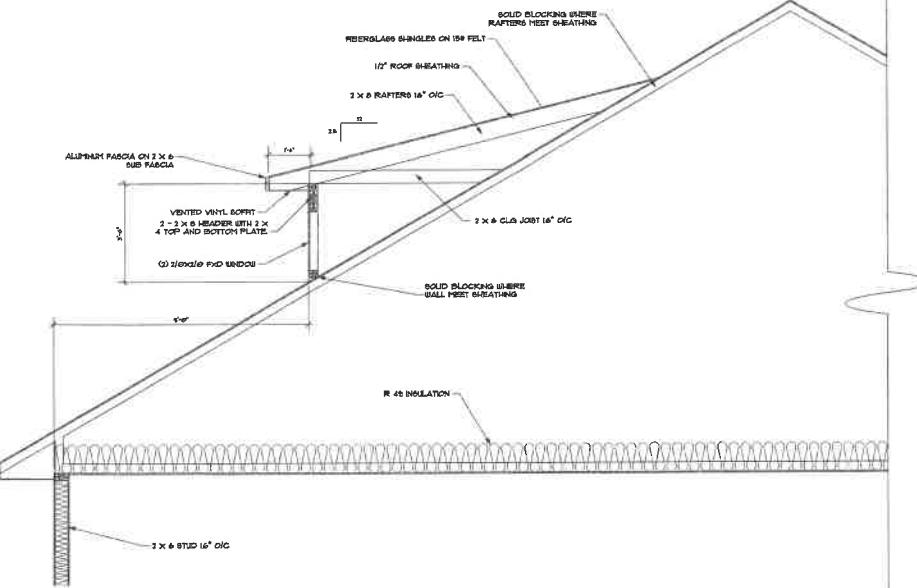


DORMER DETAIL

SCALE: 1/2" = 1'-0"

ADDITION/REMODEL FOR SALKELD FAMILY RETREAT	SUNSET DESIGN	BAI MORAN COURT ANNAPOLIS, MD 21401
BUILDING SITE: 3618 FRIENDS ROAD ANNAPOLIS, MD 21401		


SHEET  
S013

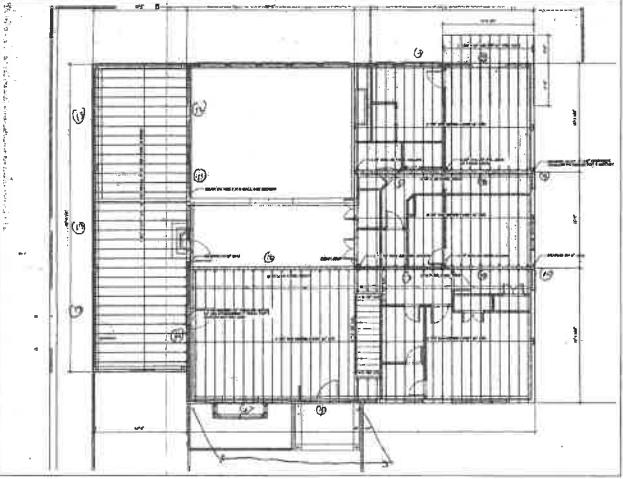	<p>December 5, 2023 Salkeld Addition</p> <p><b>Roof Framing</b></p> <p><b>GTA</b> Rfront = <math>27.5/2 \times 50 \times 18/8 = 6531</math> lbs <math>R2 = 27.5/2 \times 50 \text{ pef} \times (19x5/8 + 14.5/2) = 13,148</math> lbs <math>R3 = 27.5/2 \times 50 \times 14.5/8/8 = 11215</math> lbs <math>R \text{ rear} = 27.5/2 \times 50 \times 14.5/2 = 4984</math> lbs</p> <p><b>Front double windows</b> Span = 6.5' W = <math>46/2 \times 50 + 20 = 1170</math> pif M = 5.10 k-ft R = 3802 lbs</p> <p><b>Rear windows</b> Span = 4' W = 1170 pif M = <math>2.34 \text{ k-ft} = 28.08</math> ln-k R = 2509 lbs</p> <p><b>Left side porch roof</b> Span = 13' W = <math>18/2 \times 50 + 20 = 470</math> pif M = 9.93 k-ft R = 3055 lbs</p> <p><b>2nd Floor Framing</b></p> <p><b>Beam 1</b> Span = 11.5' W = <math>49/2 \times 42.5 + 19/2 \times 40 + 100 = 1458</math> pif M = <math>24.09 \text{ k-ft} - \text{use 3 - } 11.875^\circ \text{ LVL}</math> R ends = <math>8384 \text{ lbs} + 6531 = 14,915</math> R center = 20958 lbs</p>	<p>Page 2</p> <p><b>Beam 2</b> Span = <math>23.5' = 282"</math> W = <math>19/2 \times 50 + 40 = 515</math> pif M = <math>35.59 \text{ k-ft}</math> <math>\text{defl100 LL} = 0.899"</math> I min = <math>115 \text{ in}^4</math> - use W10x30 I = 170, Mcap = 91.3 k-ft R = 6051 lbs</p> <p><b>Beam 3 and 4</b> Span = 12.5' W = <math>33/2 \times 50 + 30 = 865</math> pif M = <math>16.7 \text{ k-ft}</math> R = 5344 lbs Use I10x22 Mod = 64.8 k-ft R center = 13,359 lbs</p> <p><b>Beam 5 end 6</b> Span = 12.5' W = <math>29/2 \times 50 + 30 = 755</math> pif M = <math>14.74 \text{ k-ft}</math> R = 4719 lbs Rcenter = 11,797 lbs</p> <p><b>Beam 7</b> Span = 7' W = <math>19/2 \times 50 + 200 = 575</math> pif M = <math>2.55 \text{ k-ft}</math> R = 1725 lbs</p> <p><b>Beam 8</b> Span = <math>10.5'</math> W = <math>19x5/8 \times 0.5/15' + 50 = 652</math> pif M = <math>8.88 \text{ k-ft}</math> R = 3423 lbs</p>
<b>SUNSET DESIGN</b> <small>51 MORAN COURT ANNAPOLIS, MD 21401 PHONE: 443-939-5885 DRAWN BY: MICHAEL STEVENSON</small>		
<b>ADDITION/REMODEL FOR SALKELD FAMILY RETREAT BUILDING SITE 2018 FRIENDS ROAD ANNAPOLIS, MD 21401</b>		
<b>SHEET S013</b>		

PROFESSIONAL CERTIFICATION IS HEREBY  
MADE THAT THE DRAWINGS AND SPECIFICATIONS  
HEREIN ARE PREPARED OR SUPERVISED BY ME, AND THAT I  
AM FULLY LICENSED PROFESSIONAL ENGINEER  
UNDER THE LAWS OF THE STATE OF MARYLAND.  
LICENSE NO. 6146, EXPIRATION DATE 11/24



DATE: 12/13/23  
REVISIONS

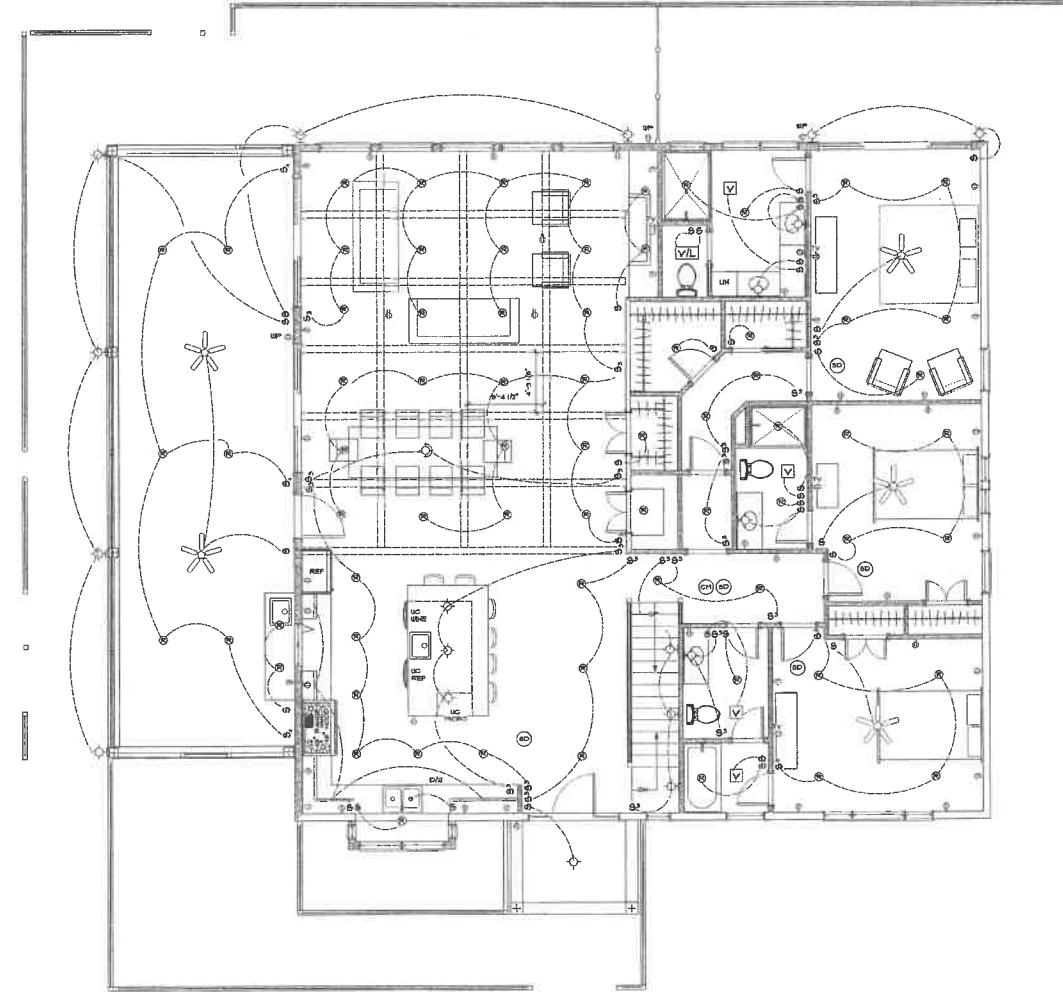

**FIRST FLOOR ELECTRIC PLAN**

SCALE: 1/4" = 1'-0"


LEGEND	
⊕	RECEPTACLE
⊖	1/2 SWITCHED RECP
⊖	WATER PROOF RECP
◎	RECESS LIGHT
◇	CEILING MOUNTED LIGHT
◇	CHANDELIER
◇	WALL MOUNTED LIGHT
□	FLUORESCENT LIGHT
☒	BATH VENT
☒	BATH VENT / LIGHT
⊖	SINGLE POLE SWITCH
⊖	THREE WAY SWITCH
⊖	FOUR WAY SWITCH
⊖	FUNCTION OF SWITCH
◎	SMOKE DETECTOR
◆	CEILING FAN

ADDITION/REMODEL FOR SALKELD FAMILY RETREAT BUILDING SITE: 3618 FRIENDS ROAD ANNAPOLIS, MD 21401	SUNSET DESIGN 951 MORAN COURT ANNAPOLIS, MD 21401 PHONE: 410-969-8555 DRAWN BY: MICHAEL STEVENSON	DATE: 12/3/13 REVISIONS 
SHEET E001		

PROFESSIONAL ENGINEERING LICENSING  
CERTIFY THAT THESE DOCUMENTS ARE  
ACCURATE AND CORRECT AS OF THE DATE LAST  
PUBLISHED AND THAT THE LICENSEE IS A REGISTERED  
PROFESSIONAL ENGINEER IN THE STATE OF MARYLAND  
UNDER THE LAW OF THE STATE OF MARYLAND.  
LICENSE NO. 16246, EXPIRATION DATE 11/1/14

PROFESSIONAL CERTIFICATION I HEREBY  
CERTIFY THAT THESE DOCUMENTS WERE  
DRAWN AND PREPARED BY ME OR UNDER MY  
SUPERVISION AND THAT THEY ACCURATELY  
REPRESENT THE EXTERIOR AND INTERIOR  
FEATURES OF THE PROPERTY LOCATED AT  
3918 FRIENDS ROAD, ANNAPOLIS,  
MARYLAND, 21401.  
LIC# 10410. EXPIRATION DATE 11/1/24


DATE: 12/1/23  
REVISIONS:

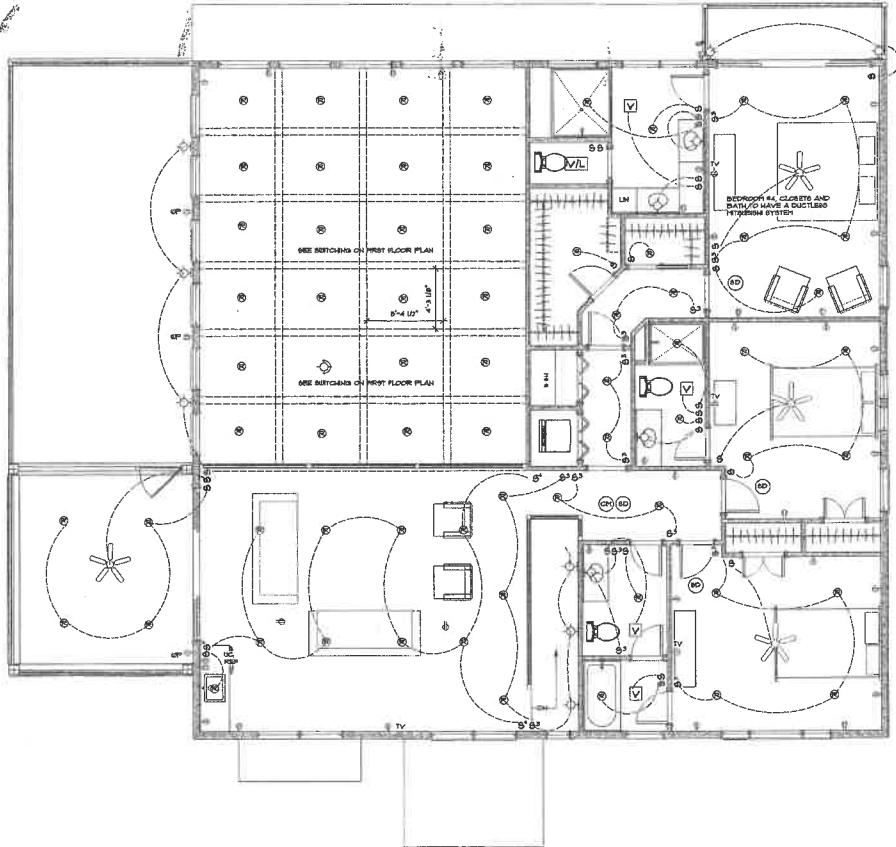

LEGEND	
○	RECEPTACLE
○	1/2 SWITCHED RECP
○	WATER PROOF RECP
○	RECESS LIGHT
○	CEILING MOUNTED LIGHT
○	CHANDELIER
○	WALL MOUNTED LIGHT
□	FLUORESCENT LIGHT
☒	BATH VENT
☒	BATH VENT / LIGHT
○	SINGLE POLE SWITCH
○	THREE WAY SWITCH
○	FOUR WAY SWITCH
○	FUNCTION OF SWITCH
○	SMOKE DETECTOR
○	CEILING FAN

ADDITION/REMODEL FOR SALKELD FAMILY RETREAT BUILDING SITE: 3918 FRIENDS ROAD ANNAPOLIS, MD 21401	SUNSET DESIGN 81 MORAN COURT ANNAPOLIS, MD 21401 PHONE: 410-988-BBBB DRAWN BY: MICHAEL STEVENSON
--	--

SHEET  
**E002**

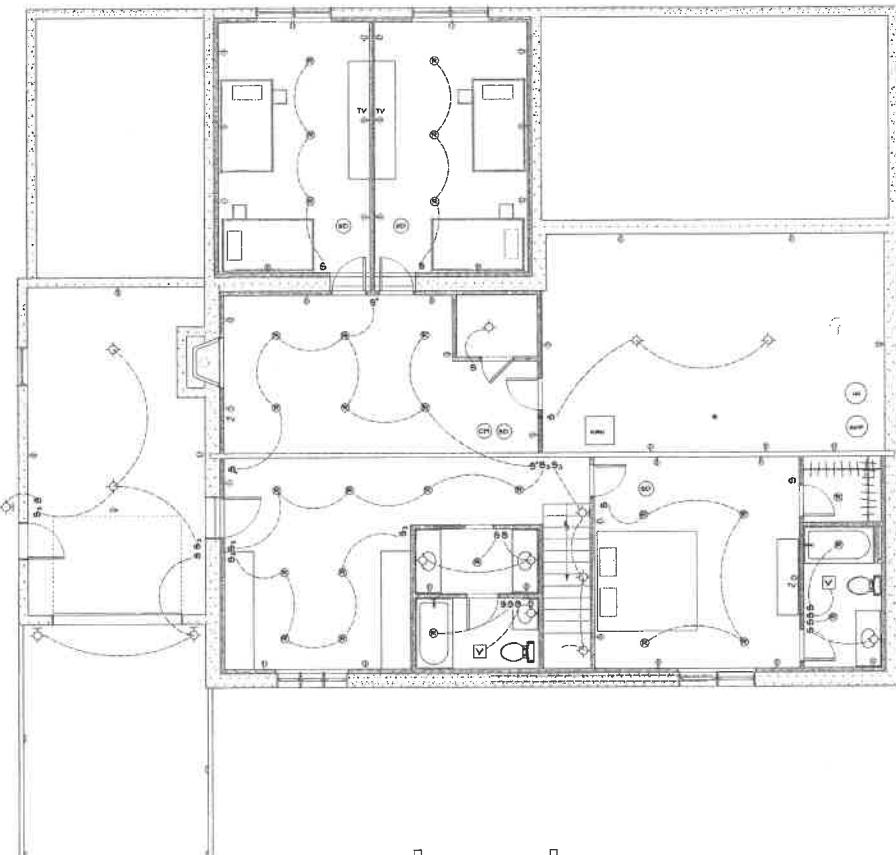

### BASEMENT ELECTRIC PLAN

SCALE: 1/4" = 1'-0"

LEGEND	
□	RECEPTACLE
□	1/2 SWITCHED RECP
□	WATER PROOF RECP
◎	RECESS LIGHT
◇	CEILING MOUNTED LIGHT
◎	CHANDELIER
△	WALL MOUNTED LIGHT
□	FLUORESCENT LIGHT
☒	BATH VENT
☒	BATH VENT / LIGHT
□	SINGLE POLE SWITCH
□	THREE WAY SWITCH
□	FOUR WAY SWITCH
□	FUNCTION OF SWITCH
◎	SMOKE DETECTOR
◇	CEILING FAN

PROFESSIONAL ENGINEERING LICENSE  
CERTIFY THAT THESE DOCUMENTS WERE  
PREPARED BY ME AND APPROVED BY ME,  
AND THAT THEY ARE IN ACCORDANCE WITH  
THE LAWS OF THE STATE OF MARYLAND.  
LICENSURE NO. 60249, EXPIRATION DATE 11/1/24

ADDITION/REMODEL FOR SALZELD FAMILY RETREAT BUILDING SITE: 3618 FRIENDS ROAD ANNAPOLIS, MD 21401	SUNSET DESIGN SAI MORAN COURT ANNAPOLIS, MD 21401 PHONE: 410-995-0505 DRAWN BY: MICHAEL STEVENSON	DATE: 12/13/23 REVISIONS 
SHEET E003		



## OFFICE OF PLANNING AND ZONING

### CONFIRMATION OF PRE-FILE

PRE-FILE #: 2024-0103-P  
DATE: 11/01/2024  
OPZ STAFF: Jennifer Lechner  
I&P STAFF: Kelly Krietz  
Habtamu Zeleke

APPLICANT/REPRESENTATIVE: 3025 LLC / Anarex, Inc.

EMAIL: [mike@anarex.com](mailto:mike@anarex.com)

SITE LOCATION: 3018 Friends Road, Annapolis

ZONING: R2 CA DESIGNATION: IDA BMA: YES BUFFER: n/a APPLICATION TYPE: Variance

The applicants are proposing to demo the existing first floor of the dwelling, and to construct a new two and a half story dwelling over the existing foundation. There will be no increase in the footprint or impervious coverage of the lot, and little disturbance to the steep slopes and 100' critical area buffer.

Variances required:

§ 17-8-201(b) Development in the IDA. Development in the intensely developed area (IDA) may not occur within slopes of 15% or greater unless development will facilitate stabilization of the slope or the disturbance is necessary to allow connection to a public utility. The Planning and Zoning Officer may grant modification to the prohibition of this subsection for slopes outside of the buffer and buffer modification area.

§ 18-4-601. Bulk regulations. A principal structure shall be a minimum of 7 feet from the side lot line.

#### COMMENTS

##### Zoning Administration Section:

Applicants are required to specify the setbacks, dimensions, height, and number of stories of any structure shown on the administrative site plan and are encouraged to provide floor plans and/or architectural elevations (front, side and rear) to assist in the evaluation of any requested variance.

The Administrative Site Plan should indicate the existing versus proposed improvements, along with the setbacks to all lot lines, dimensions, height, and number of stories.

The applicants are reminded that, in order for the Administrative Hearing Officer to grant approval of the variances, the proposal must address and meet all of the applicable variance standards provided under Section 18-16-305. The Letter of Explanation should address each of those standards and provide adequate justification for each of the variances required.

##### OPZ Critical Area Team:

No objection to the reconstruction of the existing home within the existing foundation perimeter.

##### I&P Engineering:

1. Ensure the proposed improvement including runoff, seepage, and slope saturation does not adversely impact the integration of the slope and cause slope failure.
2. This reviewer is unclear what type of SWM practice (s) are proposed. Per 6.1.4 (G) of the County Stormwater

- Practices and Procedures manual, SWM facilities shall not be located in areas that are off-limits to development, e.g., natural resources including steep slopes and buffers.
3. Please review existing vegetation (or lack thereof) within the steep slopes; opportunities to supplement vegetation or replanting buffers with native vegetation should be reviewed and provided to enhance water quality.
  4. A soil boring is required per practice. The suitability, and siting of proposed SWM practices should be reviewed. Soil boring information including verification of the suitability of in-situ soils for infiltration shall be submitted. Describe the site's hydrologic, and topographic characteristics and provide a recommendation on the feasibility of various BMPs.
  5. Based on the plan provided, it appears that the property will be served by a public water and sewer system. The county mapping inventory does not show the existing water, please clarify. The site plan did not show the WHC and SHC, please show and label clearly the existing connections.
  6. The stormwater management, utility/Engineering design review approval for the site shall occur at the grading permit stage.
  7. The above is provided as a courtesy review as information for review and consideration comments at the pre-file.

**INFORMATION FOR THE APPLICANT**

Section 18-16-301 (c) Burden of Proof. The applicant has the burden of proof, including the burden of going forward with the production of evidence and the burden of persuasion, on all questions of fact. The burden of persuasion is by a preponderance of the evidence.

A variance to the requirements of the County's Critical Area Program may only be granted if the Administrative Hearing Officer makes affirmative findings that the applicant has addressed all the requirements outlined in Article 18-16-305. Comments made on this form are intended to provide guidance and are not intended to represent support or approval of the variance request.

A preliminary plan checklist is required for development impacting environmentally sensitive areas and for all new single-family dwellings. A stormwater management plan that satisfies the requirements of the County Procedures Manual is required for development impacting environmentally sensitive areas OR disturbing 5,000 square feet or more. State mandates require a developer of land provide SWM to control new development runoff from the start of the development process.