EDGEWATER RECREATION CENTER


SCHEMATIC DESIGN SUBMITTAL - 09/16/2024

ANNE ARUNDEL COUNTY DEPT OF PUBLIC WORKS RRMM ARCHITECTS, PC

ARCHITECTURE / PLANNING / INTERIORS

1317 Executive Boulevard, Suite 200 Chesapeake, VA 23320 (757) 622-2828 115 South 15th Street, Suite 502 Richmond, VA 23219 (804) 277-8987 2900 South Quincy Street, Suite 710 Arlington, VA 22206 (703) 998-0101

28 Church Avenue SW Roanoke, VA 24011 (540) 344-1212 3700 Koppers Street, Suite 300 Baltimore, MD 21227 (410) 234-8444

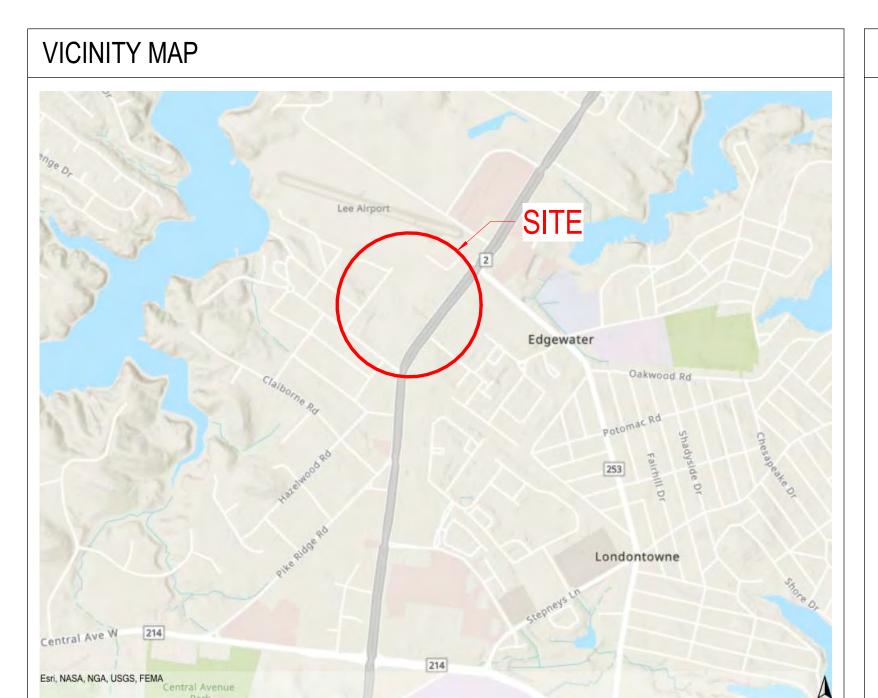

CONSULTANTS

CIVIL ENGINEERING, SURVEY, GEOTECHNICAL & LANDSCAPE ARCHITECTURE

8818 CENTRE PARK DRIVE, SUITE 200

COLUMBIA, MD 21045
P: 410.997.8900

COLUMBIA ENGINEERING, INC.

STRUCTURAL ENGINEERING

6210 OLD DOBBIN LANE, SUITE 150

COLUMBIA, MD 21045

P: 410.992.9970

KLEINFELDER
MEP ENGINEERING
10710 GILROY RD
HUNT VALLEY, MD 21031
P: 443.589.2400

ADUNDEL COUNTY

ANNE ARUNDEL COUNTY
DEPARTMENT OF PUBLIC WORKS
2662 RIVA ROAD
ANNAPOLIS, MD 21401
P: (410) 222-7500

USER

OWNER

ANNE ARUNDEL COUNTY
DEPARTMENT OF RECREATION & PARKS
1 HARRY S. TRUMAN PARKWAY - MS 3225
ANNAPOLIS, MD 21401
P: (410) 222-2827



SHEET INDEX


CONSULTANTS



G-001	TITLE SHEET	PROJECT TITLE SHEET
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C-3	EXISTING CONDITIONS	CIVIL
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C-6	SITE DETAILS	CIVIL
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S-102	LOW ROOF FRAMING PLAN - NEW WORK	STRUCTURAL
S-103	HIGH ROOF FRAMING PLAN - NEW WORK	STRUCTURAL
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MECHANIC	CAL & PLUMBING	





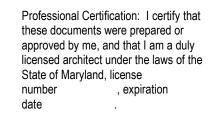

					ANNE AR	UNDEL CO	UNTY	
DESCF	RIPTION	BY DATE			DEPARTMENT	OF PUBLI	C WORKS	
			APPROVED	DATE	APPROVED DATE	SC ALE:	EDGEWATER RECREATION	N CENTER
						DRAWN BY: RM	3130 SOLOMONS ISLAND RD, EDGEV	WATER MD 21037
			CHIEF ENGINEER		PROJECT MANAGER	CHECKED BY: KDL	5150 BOLOMOND ISLAND IND, EDGL	TATER, MD, 21001
			APPROVED	DATE	APPROVED DATE	SHEET NO. OF		
						PROJECT NO. 24104-00	TITLE SHEET	G - 001
			ASSISTANT CHIEF ENCINEED		CHIEF DICHT OF WAY	DRODOSAL NO		

SHEET INDEX DESCRIPTION COVER SHEET GENERAL NOTES, LEGEND, AND ABBREVIATIONS **EXISTING CONDITIONS** SCHEMATIC SITE PLAN

ANNE ARUNDEL COUNTY

DEPARTMENT OF PUBLIC WORKS EDGEWATER RECREATION CENTER PROJECT NO. P452500, CONTRACT NO. P452571

OWNER/DEVELOPER:


ANNE ARUNDEL COUNTY DEPARTMENT OF PUBLIC WORKS 44 CALVERT STREET ANNAPOLIS, MD 21401 (410) 222-7000

ENGINEER/LANDSCAPE ARCHITECT

PENNONI ASSOCIATES, INC. 8890 McGAW ROAD, SUITE 100 COLUMBIA MD, 21045 ATTN: JAMES RUFF, PE

PROJECT LOCATION:

3130 SOLOMONS ISLAND RD

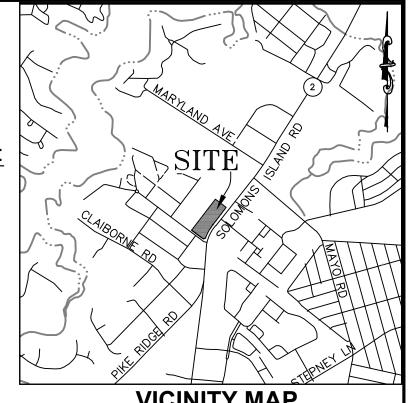

VICINITY MAP SCALE: 1"=2000'

SITE TABULATION

APPROXIMATE EXISTING SITE AREA APPROXIMATE R/W DEDICATION

C3 (COMMERCIAL - GENERAL) 5.39 ACRES (234,989 SF)

EXISTING BUILDING FLOOR AREA:

45,016 SF TOTAL (ONE-STORY)

PROPOSED: __' MAX

LIMIT OF DISTURBANCE AREA:

4.27 ACRES (185,844 SF) 4.27 ACRES (186,125 SF) RECREATION CENTER

0.10 ACRES (4,300 SF)

80% OF GROSS AREA

MAXIMUM COVERAGE ALLOWED

PROPOSED BUILDING USE:

IMPERVIOUS AREA

BY STRUCTURE AND PARKING

EXISTING LOT COVERAGE (4.27 AC. / 5.39 AC. X 100%)

PROPOSED LOT COVERAGE:

MINIMUM SETBACKS FOR PRINCIPAL STRUCTURES:

NONE, EXCEPT WHEN ABUTTING A RESIDENTIAL DISTRICT 15 FEET NONE, EXCEPT WHEN ABUTTING A RESIDENTIAL DISTRICT 25 FEET ALL LOT LINES: 60 FEET FROM RIGHT-OF-WAY OF DIVIDED PRINCIPAL ARTERIAL ROAD

PROVIDED SETBACKS FOR PRINCIPAL STRUCTURES: FROM MD ROUTE 2:

119.45 FEET 63.96 FEET

PARKING TABULATION


EXISTING BUILDING SF: 45,016 SF±

PARKING REQUIREMENTS FOR RECREATION CENTER USE: 4 SP/1.000 SF OF FLOOR AREA (PARKING REQUIREMENTS BASED ON THE SQUARE FOOTAGE OF A STRUCTURE TO BE SERVED SHALL BE CALCULATED BASED ON 75% OF THE FLOOR AREA)=

45,016 SF X 0.75 = 33,762 SF/1,000 = 33.8 X 4 = 136 PARKING SPACES REQUIRED

TOTAL PARKING PROVIDED: PROPOSED HANDICAP SPACES:

12 SPACES (INCLUDED IN TOTAL ABOVE, 4 OF THE 12 SPACES ARE VAN ACCESSIBLE HANDICAP SPACES)

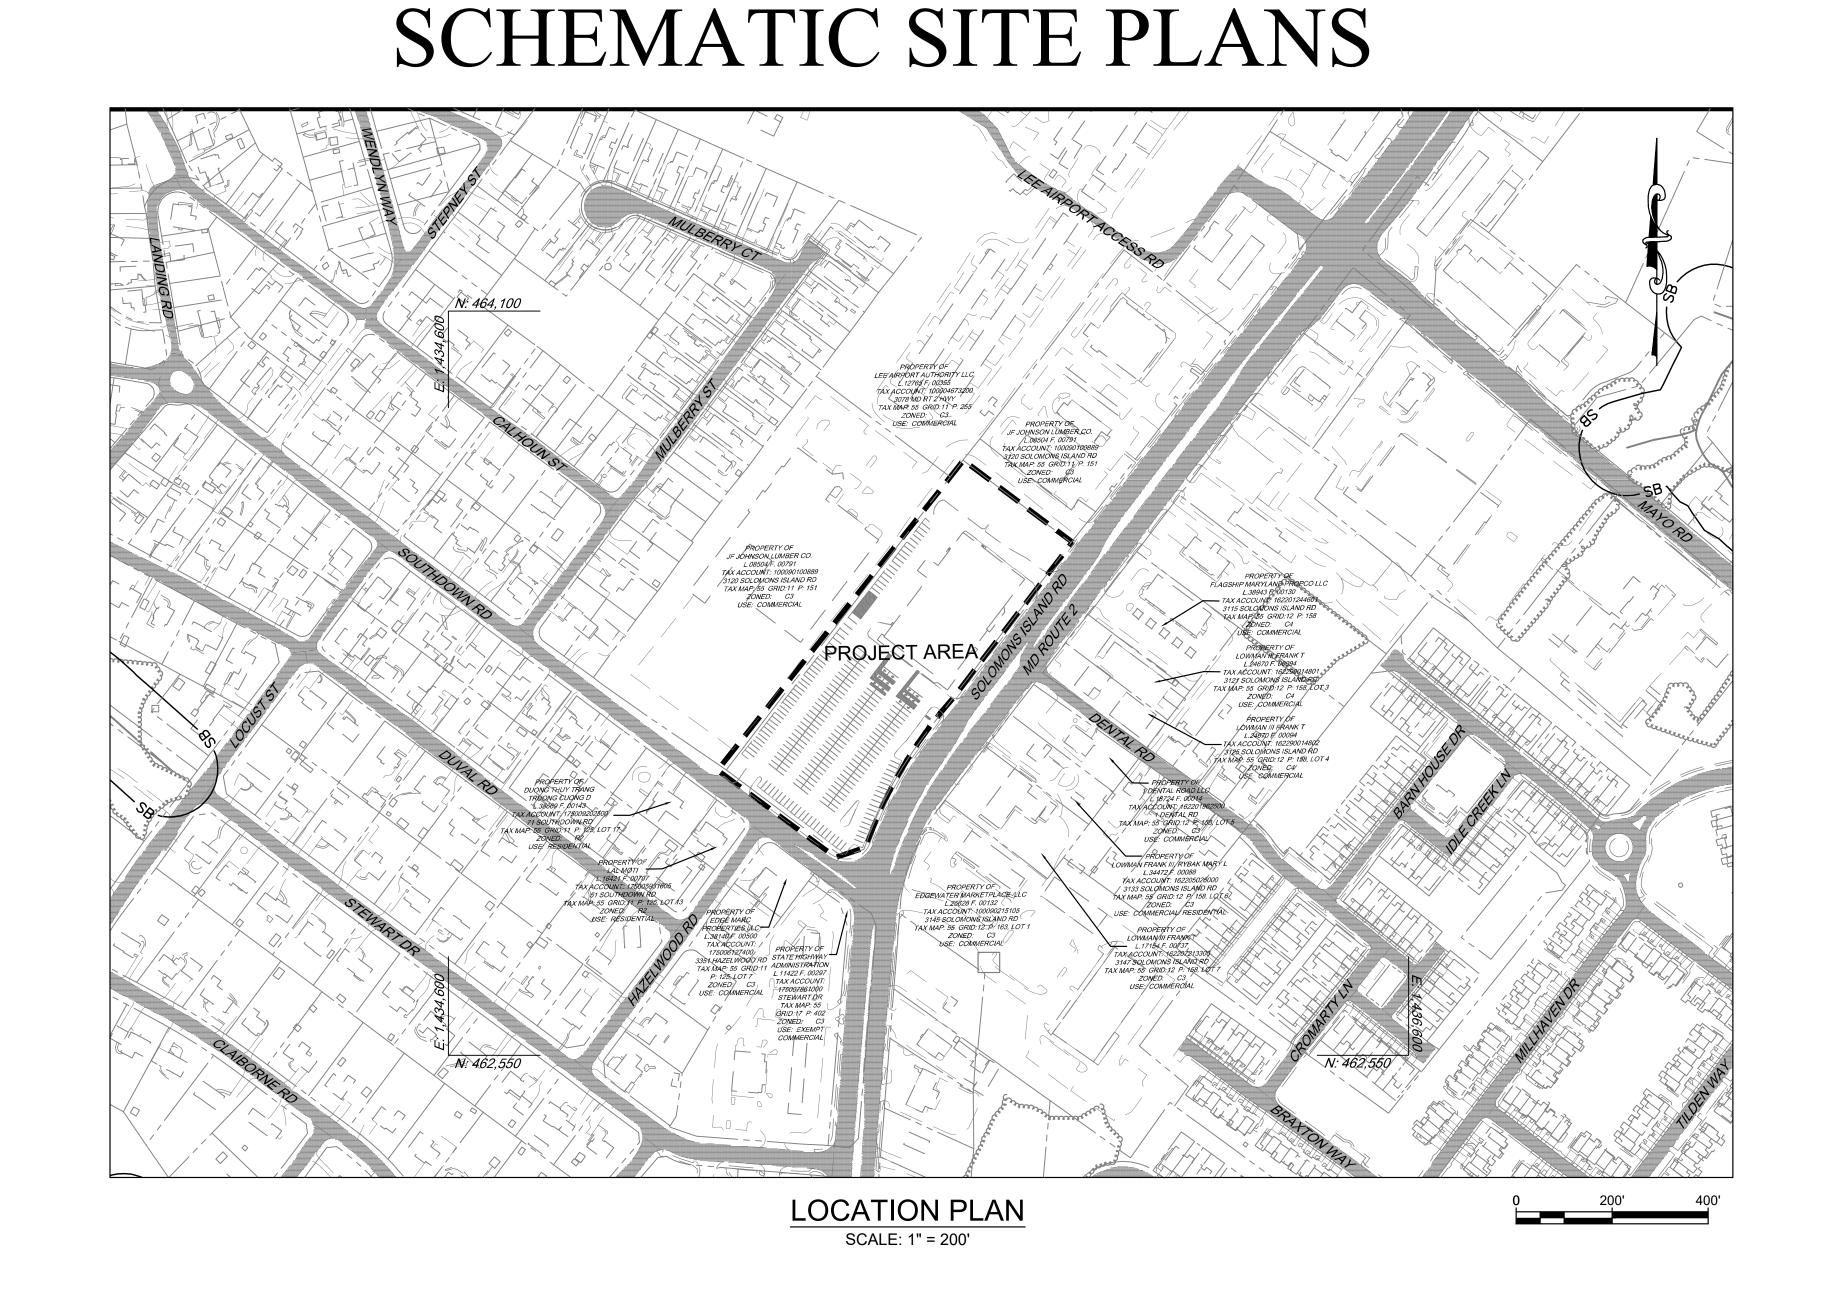

EXISTING UTILITIES SHOWN ON THIS PLAN SET WERE DRAWN USING GIS DATA FROM ANNE ARUNDEL COUNTY. UTILITIES SHOWN ARE FOR INFORMATIONAL PURPOSES ONLY. THE UTILITY INFORMATION SHOWN MAY BE INNACURATE OF INCOMPLETE. CONTRACTOR IS RESPONSIBLE FOR VERIFYING ALL EXISTING UTILITIES WITHIN THE PROJECT LIMITS OF WORK TO HIS OWN SATISFACTION PRIOR TO THE START OF CONSTRUCTION. CONTRACTOR SHALL TAKE ALL NECESSARY PRECAUTIONS TO PROTECT EXISTING UTILITIES, SHALL AVOID IMPACTS TO UTILITIES, AND SHALL MAINTAIN UNINTERRUPTED UTILITY SERVICE. ANY DAMAGE INCURRED DUE TO CONTRACTOR'S OPERATIONS SHALL BE REPAIRED IMMEDIATELY AT NO COST TO ANNE ARUNDEL COUNTY IN COORDINATION WITH THE AFFECTED UTILITY COMPANIES.

	PROFESSIONAL (CERTIFICATION: I,	, CERTIFY THAT THESE DOCUME	NTS WERE PREPARED BY OR APPROVED BY ME AND THAT I AM A DULY
	LICENSED	UNDEF	THE LAWS OF THE STATE OF MARYLAND LICENS	E # EXPIRATION DATE
		REVISIONS	APPROVED	
	#	DESCRIPTION	BY DATE	
				/Pennoni/
				(P GIIIOIII
	4			
CALL "MISS UTILITY" AT LEAST 96				PENNONI ASSOCIATES INC.
HOURS IN ADVANCE OF CONSTRUCTION AT				8890 McGaw Road, Suite 100
				Columbia, MD 21045
1-800-257-7777 OR 811	1 1			T 410.997.8900 F 410.997.9282

F 410.997.9282

					GP#		DWG NO: SD01
LY				ANNE ARU	JNDEL COUNTY		
			DEP	ARTMENT	OF PUBLIC WORKS		AUGUST 30, 2024
	APPROVED	DATE	APPROVED	DATE	SCALE: 1" = 200'	000	WED CHEET
					DRAWN BY: CR		OVER SHEET
	CHIEF ENGINEER		PROJECT MANAGER		CHECKED BY: PJS/ALC		
	APPROVAL	DATE	APPROVED	DATE	SHEET 1 of 6	TEDGEWATER I	RECREATION CENTER
					PROJECT #: P452500		5 GRID 12 PARCEL 242 GEWATER, MD ZIP CODE 21037 1ST DISTRICT
	ASSISTANT CHIEF EN	GINEER	CHIEF, RIGHT OF WAY	/ SERVICES	CONTRACT #: P452571	.	RUNDEL COUNTY, MD

GENERAL NOTES

- 1. THE BOUNDARY SHOWN ON THESE PLANS IS FROM A DEED PLOT PREPARED BY PENNONI ASSOCIATES, INC. DATED 5/15/2024.
- 2. TOPOGRAPHIC INFORMATION IS FROM BY ANNE ARUNDEL COUNTY GIS INFORMATION.
- 3. THERE ARE NO VEGETATED OR TIDAL WETLANDS, WATERS OF THE U.S. AND/OR HAZARDOUS WASTES AREAS.
- 4. THERE ARE NO SPECIMEN TREES OR FOREST ON THIS SITE.
- 5. UNLESS OTHERWISE INDICATED, THE LOCATION OF ALL UNDERGROUND UTILITIES ARE APPROXIMATE AND ARE BASED ON GIS RECORDS.
- 6. THE EXISTING UTILITIES AND OBSTRUCTIONS SHOWN ARE FROM THE BEST AVAILABLE RECORDS, AND SHALL BE VERIFIED BY THE CONTRACTOR TO HIS OWN SATISFACTION. NECESSARY PRECAUTIONS SHALL BE TAKEN BY THE CONTRACTOR TO PROTECT EXISTING SERVICE MAINS. ANY DAMAGE TO THEM SHALL BE REPAIRED IMMEDIATELY AT NO ADDITIONAL COST TO ANNE ARUNDEL COUNTY OR THE
- 7. UTILITY RELOCATION WILL BE PERFORMED BY OTHERS UNLESS NOTED OTHERWISE IN THE PLANS. THE CONTRACTOR SHALL BE RESPONSIBLE FOR COORDINATION OF HIS CONSTRUCTION WITH THE CONSTRUCTION OF OTHER CONTRACTORS (INCLUDING BUT NOT LIMITED TO BG&E, VERIZON, AND CABLE TV UTILITY). REFER TO PROJECT MANUAL GENERAL SPECIAL PROVISIONS.
- 8. THE CONTRACTOR SHALL CALL "MISS UTILITY" 1-800-257-7777 OR 811 A MINIMUM OF 72 HOURS PRIOR TO BEGINNING ANY EXCAVATION.
- 9. IT SHALL BE DISTINCTLY UNDERSTOOD THAT FAILURE TO MENTION SPECIFICALLY ANY WORK WHICH WOULD NATURALLY BE REQUIRED TO COMPLETE THE PROJECT SHALL NOT RELIEVE THE CONTRACTOR OF HIS RESPONSIBILITY TO COMPLETE SUCH WORK.
- 10. THE CONTRACTOR SHALL NOTIFY THE ANNE ARUNDEL COUNTY DEPARTMENT OF PUBLIC WORKS (410) 222-4126, AT LEAST FOURTEEN (14) DAYS PRIOR TO BEGINNING CONSTRUCTION.
- 11. GRID COORDINATES ARE BASED ON THE MARYLAND STATE PLANE COORDINATE SYSTEM NAD 83/91. VERTICAL ELEVATIONS ARE BASED UPON NAVD 88.
- 12. THE CONTRACTOR SHALL ADJUST MANHOLES, WATER, METER VALVES, HAND BOXES, AND OTHER APPURTENANCES TO FINAL GRADE. THE COST OF PERFORMING THESE ACTIVITIES SHALL BE INCIDENTAL TO THE CONTRACT PRICE PAID FOR VARIOUS PAVEMENT ITEMS.
- 13. UNLESS OTHERWISE NOTED, PIPE ELEVATIONS REFER TO THE PIPE INVERT.
- 14. THE CONTRACTOR SHALL BE RESPONSIBLE FOR REPLACING ANY EXISTING LIGHT POLES, TRAFFIC BARRIER, SIGNS, ETC., DAMAGED OR REMOVED BY HIM DURING CONSTRUCTION.
- 15. IT SHALL BE THE RESPONSIBILITY OF THE CONTRACTOR TO NOTIFY THE ENGINEER OF ANY DEVIATION TO THIS PLAN PRIOR TO ANY FIELD CHANGES BEING MADE. THE CONTRACTOR ASSUMES ALL RESPONSIBILITY FOR ANY FIELD CHANGES OR ADJUSTMENTS WITHOUT NOTIFYING THE ENGINEER.
- 16. ALL WORK SHALL COMPLY WITH THE APPLICABLE PROVISIONS OF THE "2011 MARYLAND STANDARDS AND SPECIFICATIONS FOR SOIL EROSION AND SEDIMENT CONTROL" ISSUED BY THE MARYLAND DEPARTMENT OF THE ENVIRONMENT AND AMENDMENTS BY THE ANNE ARUNDEL SOIL CONSERVATION DISTRICT, CONTAINED HEREIN AND THE 2017 STANDARD SPECIFICATIONS FOR CONSTRUCTION AND MATERIALS ISSUED BY THE MARYLAND DEPARTMENT OF TRANSPORTATION STATE HIGHWAY ADMINISTRATION.
- 17. THE DESIGN FOR THIS PROJECT INCORPORATES FACILITIES FOR THE HANDICAPPED IN COMPLIANCE WITH STATE AND FEDERAL LEGISLATION.
- 18. WHERE CURB AND GUTTER ENDS ARE EXPOSED, PROVIDE A NOSE DOWN SECTION AT 3:1 SLOPE.
- 19. IN PAVEMENT AND GRAVEL REMOVAL AREAS, THE CONTRACTOR SHALL REMOVE ALL PAVING AND BASE MATERIALS, BACKFILL WITH COMMON BORROW MATERIAL AND 4" OF TOPSOIL, SEED AND MULCH. THE AREA SHALL BE GRADED TO DRAIN.
- 20. MATERIAL REMOVED DURING CONSTRUCTION SHALL BECOME THE CONTRACTOR'S PROPERTY UNLESS OTHERWISE NOTED ON THE PLANS OR IN THE SPECIAL PROVISIONS.
- 21. ALL SITE WORK SHALL BE COMPLETED BY THE CONTRACTOR IN ACCORDANCE WITH THE ANNE ARUNDEL COUNTY, DEPARTMENT OF PUBLIC WORKS, BUREAU OF ENGINEERING, STANDARD SPECIFICATIONS FOR CONSTRUCTION (SPECIFICATIONS).
- 22. CONTRACTOR MUST HAND DIG NEAR EXISTING UNDERGROUND UTILITIES WITH LESS THAN OR EQUAL TO 3.0 FEET CLEAR DISTANCE.

SYMBOL LEGEND

PROPERTY LINE AND RIGHT-OF-WAY EXISTING 2' CONTOUR EXISTING 10' CONTOUR EXISTING TREE LINE EXISTING SOILS		50	
EXISTING ASPHALT ROADWAY		······································	
EXISTING BUILDINGS	 	 	
EXISTING WATER	w	- w	- W ——
EXISTING SEWER	s	- s ———	- s ——
EXISTING OVERHEAD ELECTRIC	OE	- OE	- OE
EXISTING UNDERGROUND ELECTRIC	UE	- UE	- UE
EXISTING STORM DRAIN	D	- D	- D
EXISTING GAS	—— G ———	- G ———	- G ——

SOILS TABLE STRUCTURAL LIMITATIONS EROSION HYDRIC SLOPE SOIL K DWELLINGS WITH BASEMENTS HAZARD HYDRIC (%) GROUP FACTOR SYMBOL Moderate No 0-5% C .24 AuB Annapolis-Urban Land complex Not Limited Very Limited DuB Donlonton-Urban Land complex Moderate Yes 0-5% D .24

SOURCE: NATURAL RESOURCES CONSERVATION SERVICE WEB SOIL SURVEY.

DDA	FESSIONAL CERTIFICATION: I			RTIFY THAT THESE DOCUMENTS WERE PREPARED BY OR APPROVED BY ME AND THAT I AM
	·			TATE OF MARYLAND LICENSE # EXPIRATION DATE
	REVISIONS	APP	ROVED	
#	DESCRIPTION	BY	DATE	
				Donnani
				/Pennoni/
				PENNONI ASSOCIATES IN
				8890 McGaw Road, Suite 100
				Columbia, MD 21045
				T 410.997.8900 F 410.997.926
	L			l


	LIST OF AE	BREVI	<u>4</u> T	<u>IONS</u>
AATUR -	ABANDONED ACCORDING TO UTILITY RECORDS	P.V.C.	-	POINT OF VERTICAL CURVE (OR POLYVINYL CHLORIDE
A.D.T	AVERAGE DAILY TRAFFIC	P.V.I.	-	POINT OF VERTICAL INTERSECTION
AHD -	AHEAD	PVMT.	-	PAVEMENT
BGE -	BALTIMORE GAS AND ELECTRIC COMPANY	P.V.T.	-	POINT OF VERTICAL TANGENCY
BIT	BITUMINOUS	R	-	RADIUS
BK	BACK	R.C.C.P.	_	REINFORCED CEMENT CONCRETE PIPE
B.M	BENCH MARK	REF.	_	REFERENCE
BW -	BOTTOM OF WALL	R.S.E.	_	REVERTIBLE SLOPE EASEMENT
B/L -	BASELINE	RT.	_	RIGHT
C -	RATE OF TRANSITION	RTE.	_	ROUTE
CC -	CENTER POINT OF CURVE	R/W	-	RIGHT OF WAY
CATV -	CABLE TELEVISION	SAN.	-	SANITARY
C&G -	CURB AND GUTTER	S.D.	-	STORM DRAIN
C.I.P	CAST IN PLACE (OR CURB INLET PROTECTION)	S/E	-	SUPER ELEVATION
C.I.P	CORRUGATED METAL PIPE	S.H.A.	-	STATE HIGHWAY ADMINISTRATION
C.S.P	CORRUGATED STEEL PIPE	SMH.	-	SEWER MANHOLE
C.O	CLEAN OUT	S.S.D.	-	STOPPING SIGHT DISTANCE
COMB	COMBINATION	STA.	-	STATION
COMM	COMMUNICATION	STD.	-	STANDARD
CONSTR	CONSTRUCTION	STRUCT.	-	STRUCTURE
CORR	CORRECTION	Т	-	TELEPHONE
DATUR -	DEPICTED ACCORDING TO UTILITY RECORDS	TC	_	TRAFFIC CONTROL
DWG	DRAWING		_	TEMPORARY CONSTRUCTION EASEMENT
Dc -	DEGREE OF CURVE		_	TRAFFIC CONTROL PLANS
Δ -	DELTA (CENTRAL ANGLE), DEGREES	T.H.	-	TEST HOLE
D.H.V	DESIGN HOUR VOLUME	TW	-	TOP OF WALL
D.I	DROP INLET	TYP.	-	TYPICAL
DIA	DIAMETER	U.D.	-	UNDERDRAIN PIPE
D.S	DESIGN SPEED	WB	-	WESTBOUND
E -	ELECTRIC	W.M.	-	WATER METER
EB -	EASTBOUND	W.S.	-	WRAPPED STEEL
EOI -	END OF INFORMATION	W.U.S.	-	WATERS OF THE UNITED STATES
EORI -	END OF RECORD INFORMATION	W.V.	_	WATER VALVE
ERCCP -	ELLIPITICAL REINFORCED CEMENT CONCRETE PIPE	V.C.	_	LENGTH OF VERTICAL CURVE
ES -	END STRUCTURE			
EW -	ENDWALL OR EACH WAY			
	EXISTING			
EX., EXIST-				
F.O	FIBER OPTIC			
F.S	FULL SUPER			
GA	GAUGE OR GAGE			
G.H.C	GAS HOUSE CONNECTION			
G.V	GAS VALVE			
HDWL -	HEADWALL			
HERCCP -	HORIZONTAL ELLIPITICAL REINFORCED CEMENT CON	CRETE PIPE		
H.H	HANDHOLE			
H.S.A	HEADLIGHT SIGHT DISTANCE			
H.P	HIGH POINT			
I -	INLET			
•				
INV	INVERT			
L -	LENGTH			
L.P	LOW POINT (OR LIGHT POLE)			
L.S	LEVEL SECTION			
LT	LEFT			
M.B	MAIL BOX			
MD -	MARYLAND			
MDE -	MARYLAND DEPARTMENT OF THE ENVIRONMENT			
M.H	MANHOLE			
N/A -	NOT APPLICABLE			
	NUMBER			
N.S	NORMAL SECTION			
O.C	ON CENTER			
O/S -	OFFSET			
P.C	POINT OF CURVE			
P/C -	POINT OF CROWN			
	POINT OF COMPOUND CURVE OR PORTLAND CEMENT	CONCRETE		
P.C.C	PROFILE GRADE ELEVATION			
P.C.C P/G.E				
P/G.E	PROFILE GRADE LINE			
P/G.E P.G.L	PROFILE GRADE LINE			
P/G.E P.G.L P./G.L	PROFILE GROUND LINE			
P/G.E P.G.L P./G.L P.H	PROFILE GROUND LINE PUNCH HOLE			
P/G.E P.G.L P./G.L P.H	PROFILE GROUND LINE PUNCH HOLE POINT OF INTERSECTION			
P/G.E P.G.L P./G.L P.H	PROFILE GROUND LINE PUNCH HOLE			


P.O.T. - POINT ON TANGENT POINT OF ROTATION


P.R.C. - POINT OF REVERSE CURVATURE POINT OF TANGENT


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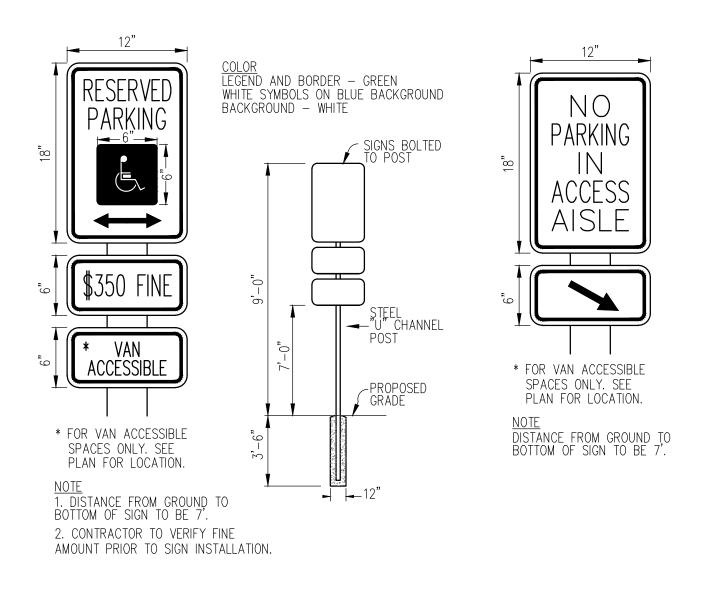
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M A DULY			A	ANNE ARUI	NDEL COUNTY	
<u></u>			DEPA	RTMENT C	F PUBLIC WORKS	AUGUST 30, 2024
')	APPROVED	DATE	APPROVED	DATE	SCALE: AS SHOWN	GENERAL NOTES, LEGEND, AND ABBREVIATIONS
					DRAWN BY: CR	GENERAL NOTES, ELGEND, AND ADDREVIATIONS
	CHIEF ENGINEER		PROJECT MANAGER		CHECKED BY: PJS/ALC	
NC.	APPROVAL	DATE	APPROVED	DATE	SHEET 2 of 6	EDGEWATER RECREATION CENTER
0					PROJECT #: P452500	TAX MAP 55 GRID 12 PARCEL 242 - 3130 SOLOMONS ISLAND RD EDGEWATER, MD ZIP CODE 21037 1ST DISTRICT
)282	ASSISTANT CHIEF ENG	INEER	CHIEF, RIGHT OF WAY S	SERVICES	CONTRACT #: P452571	ANNE ARUNDEL COUNTY, MD
	•	-			II:\Accounts\AACOX\AACOX24005 = 6	Ednewater Recreation Center\NESIGN\ SHEETS\SCHEMATIC DESIGN SITE PLAN\AACOX24005_SD02 dwa




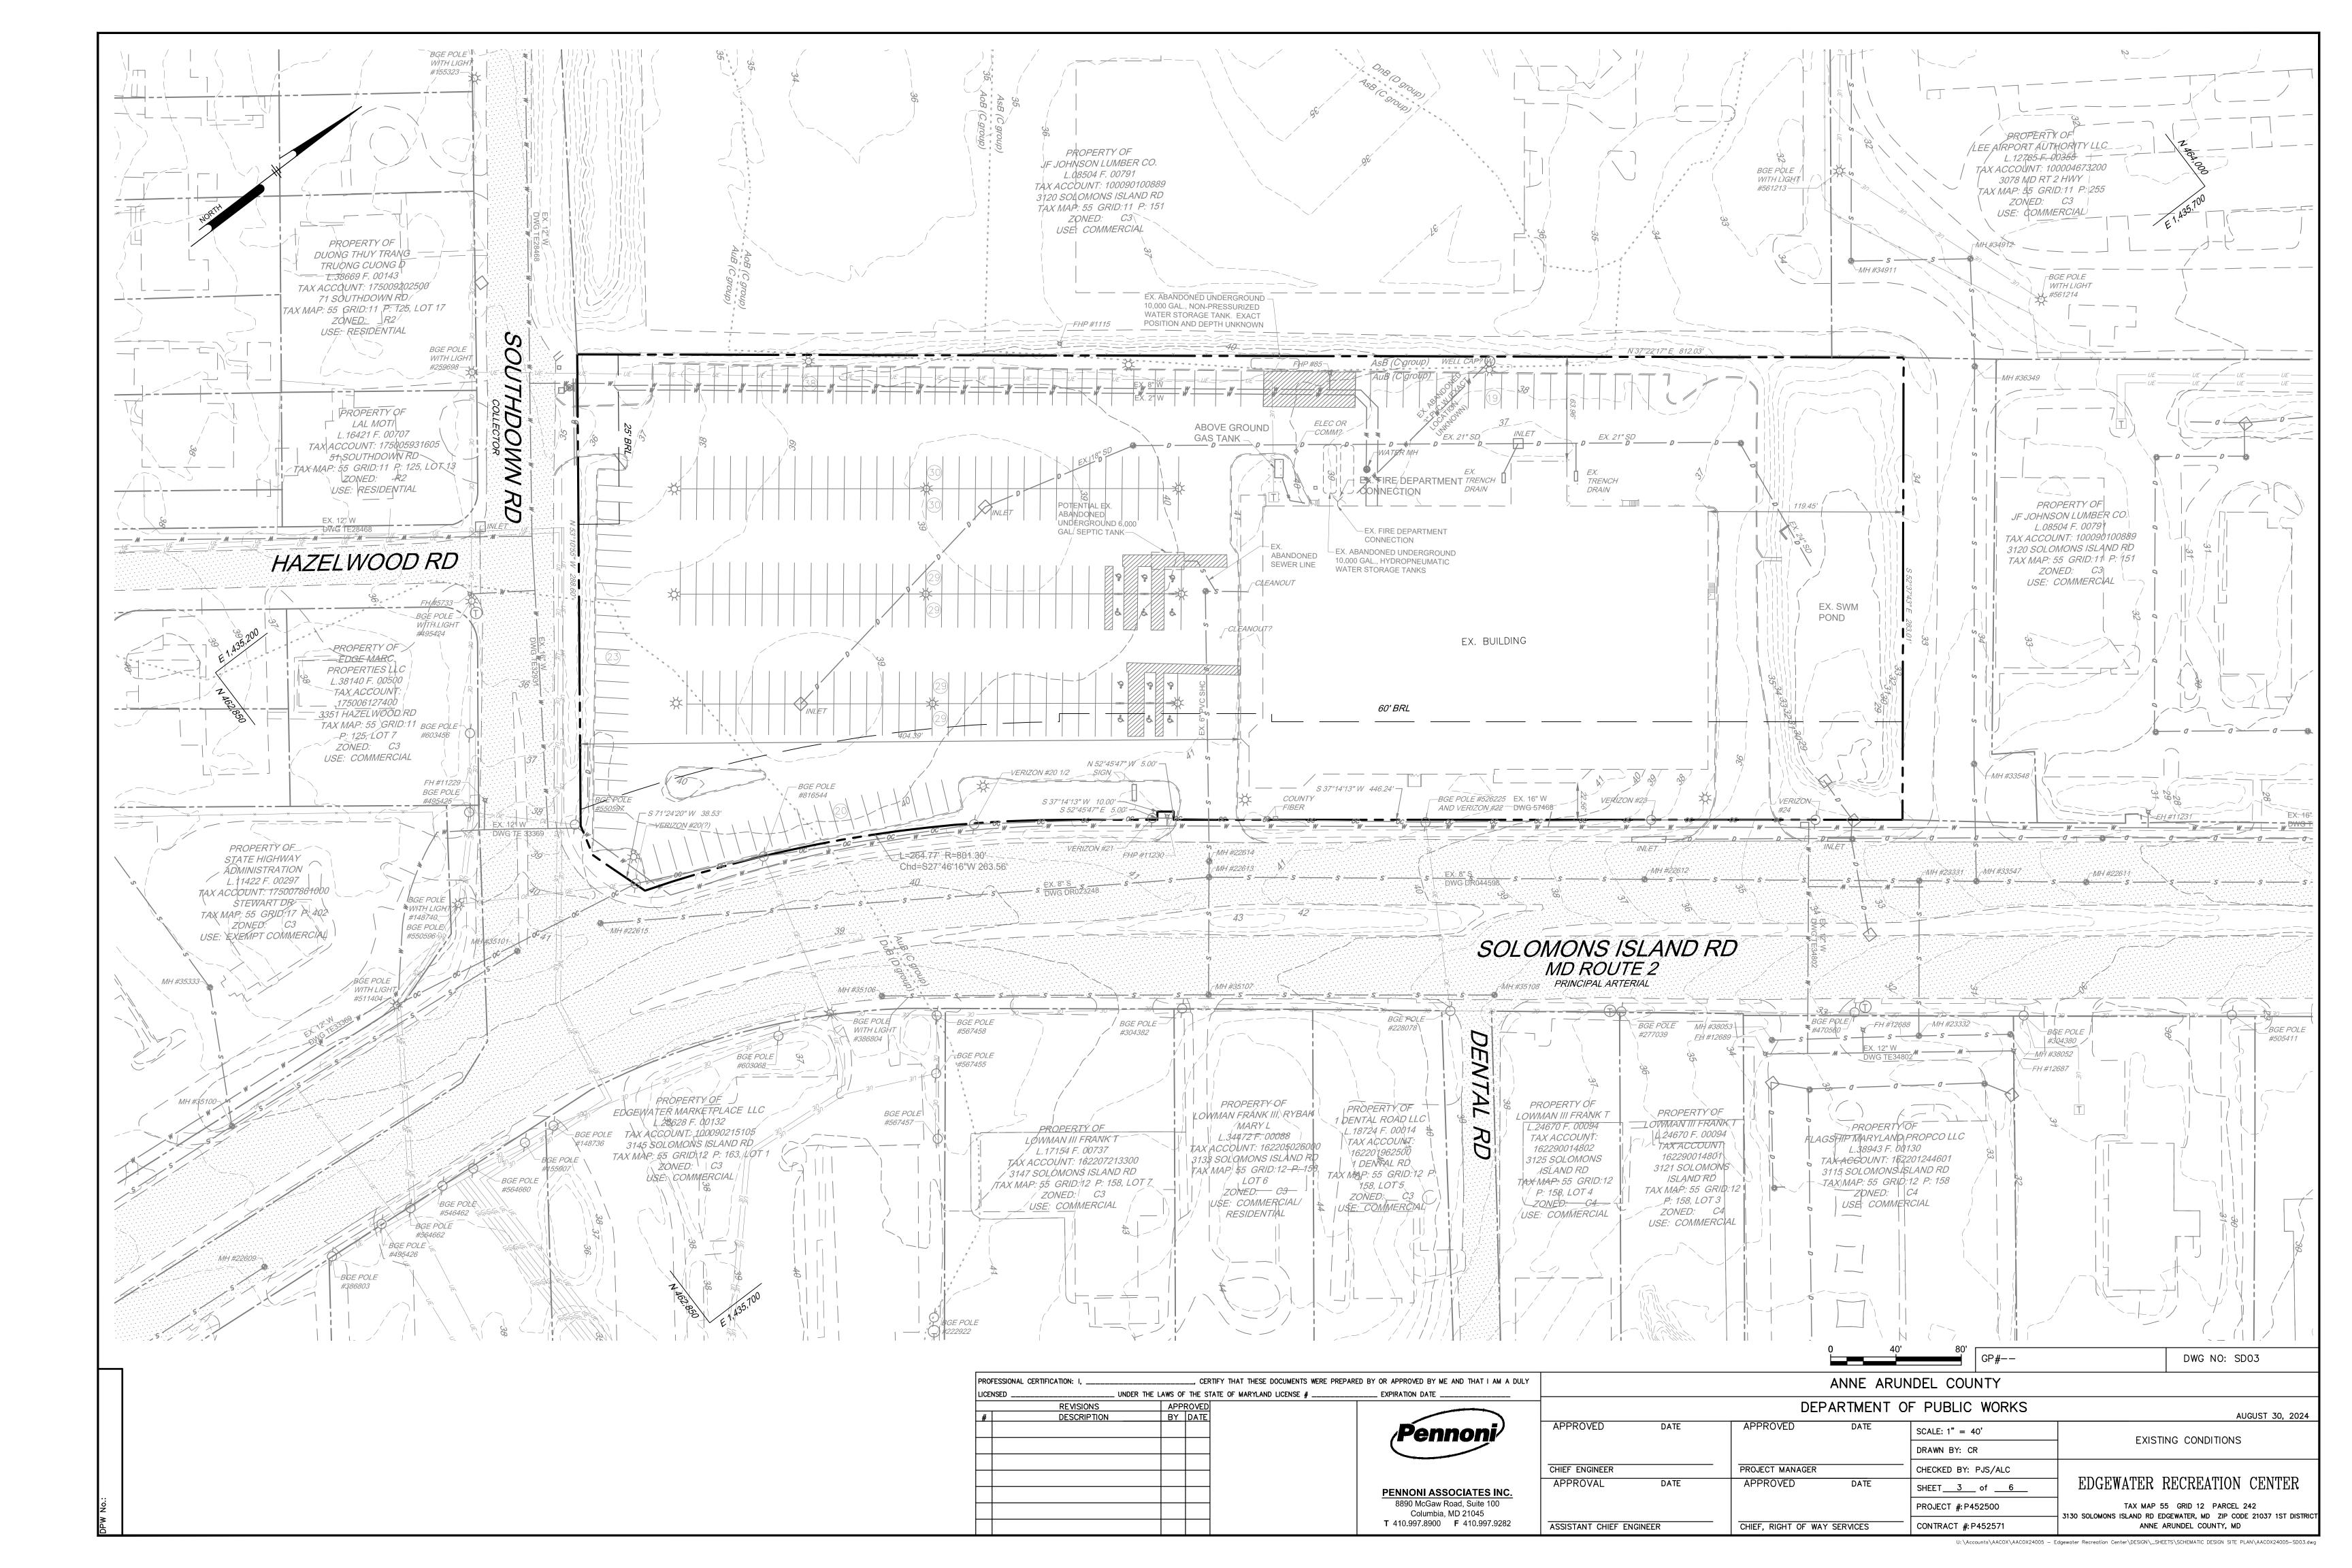


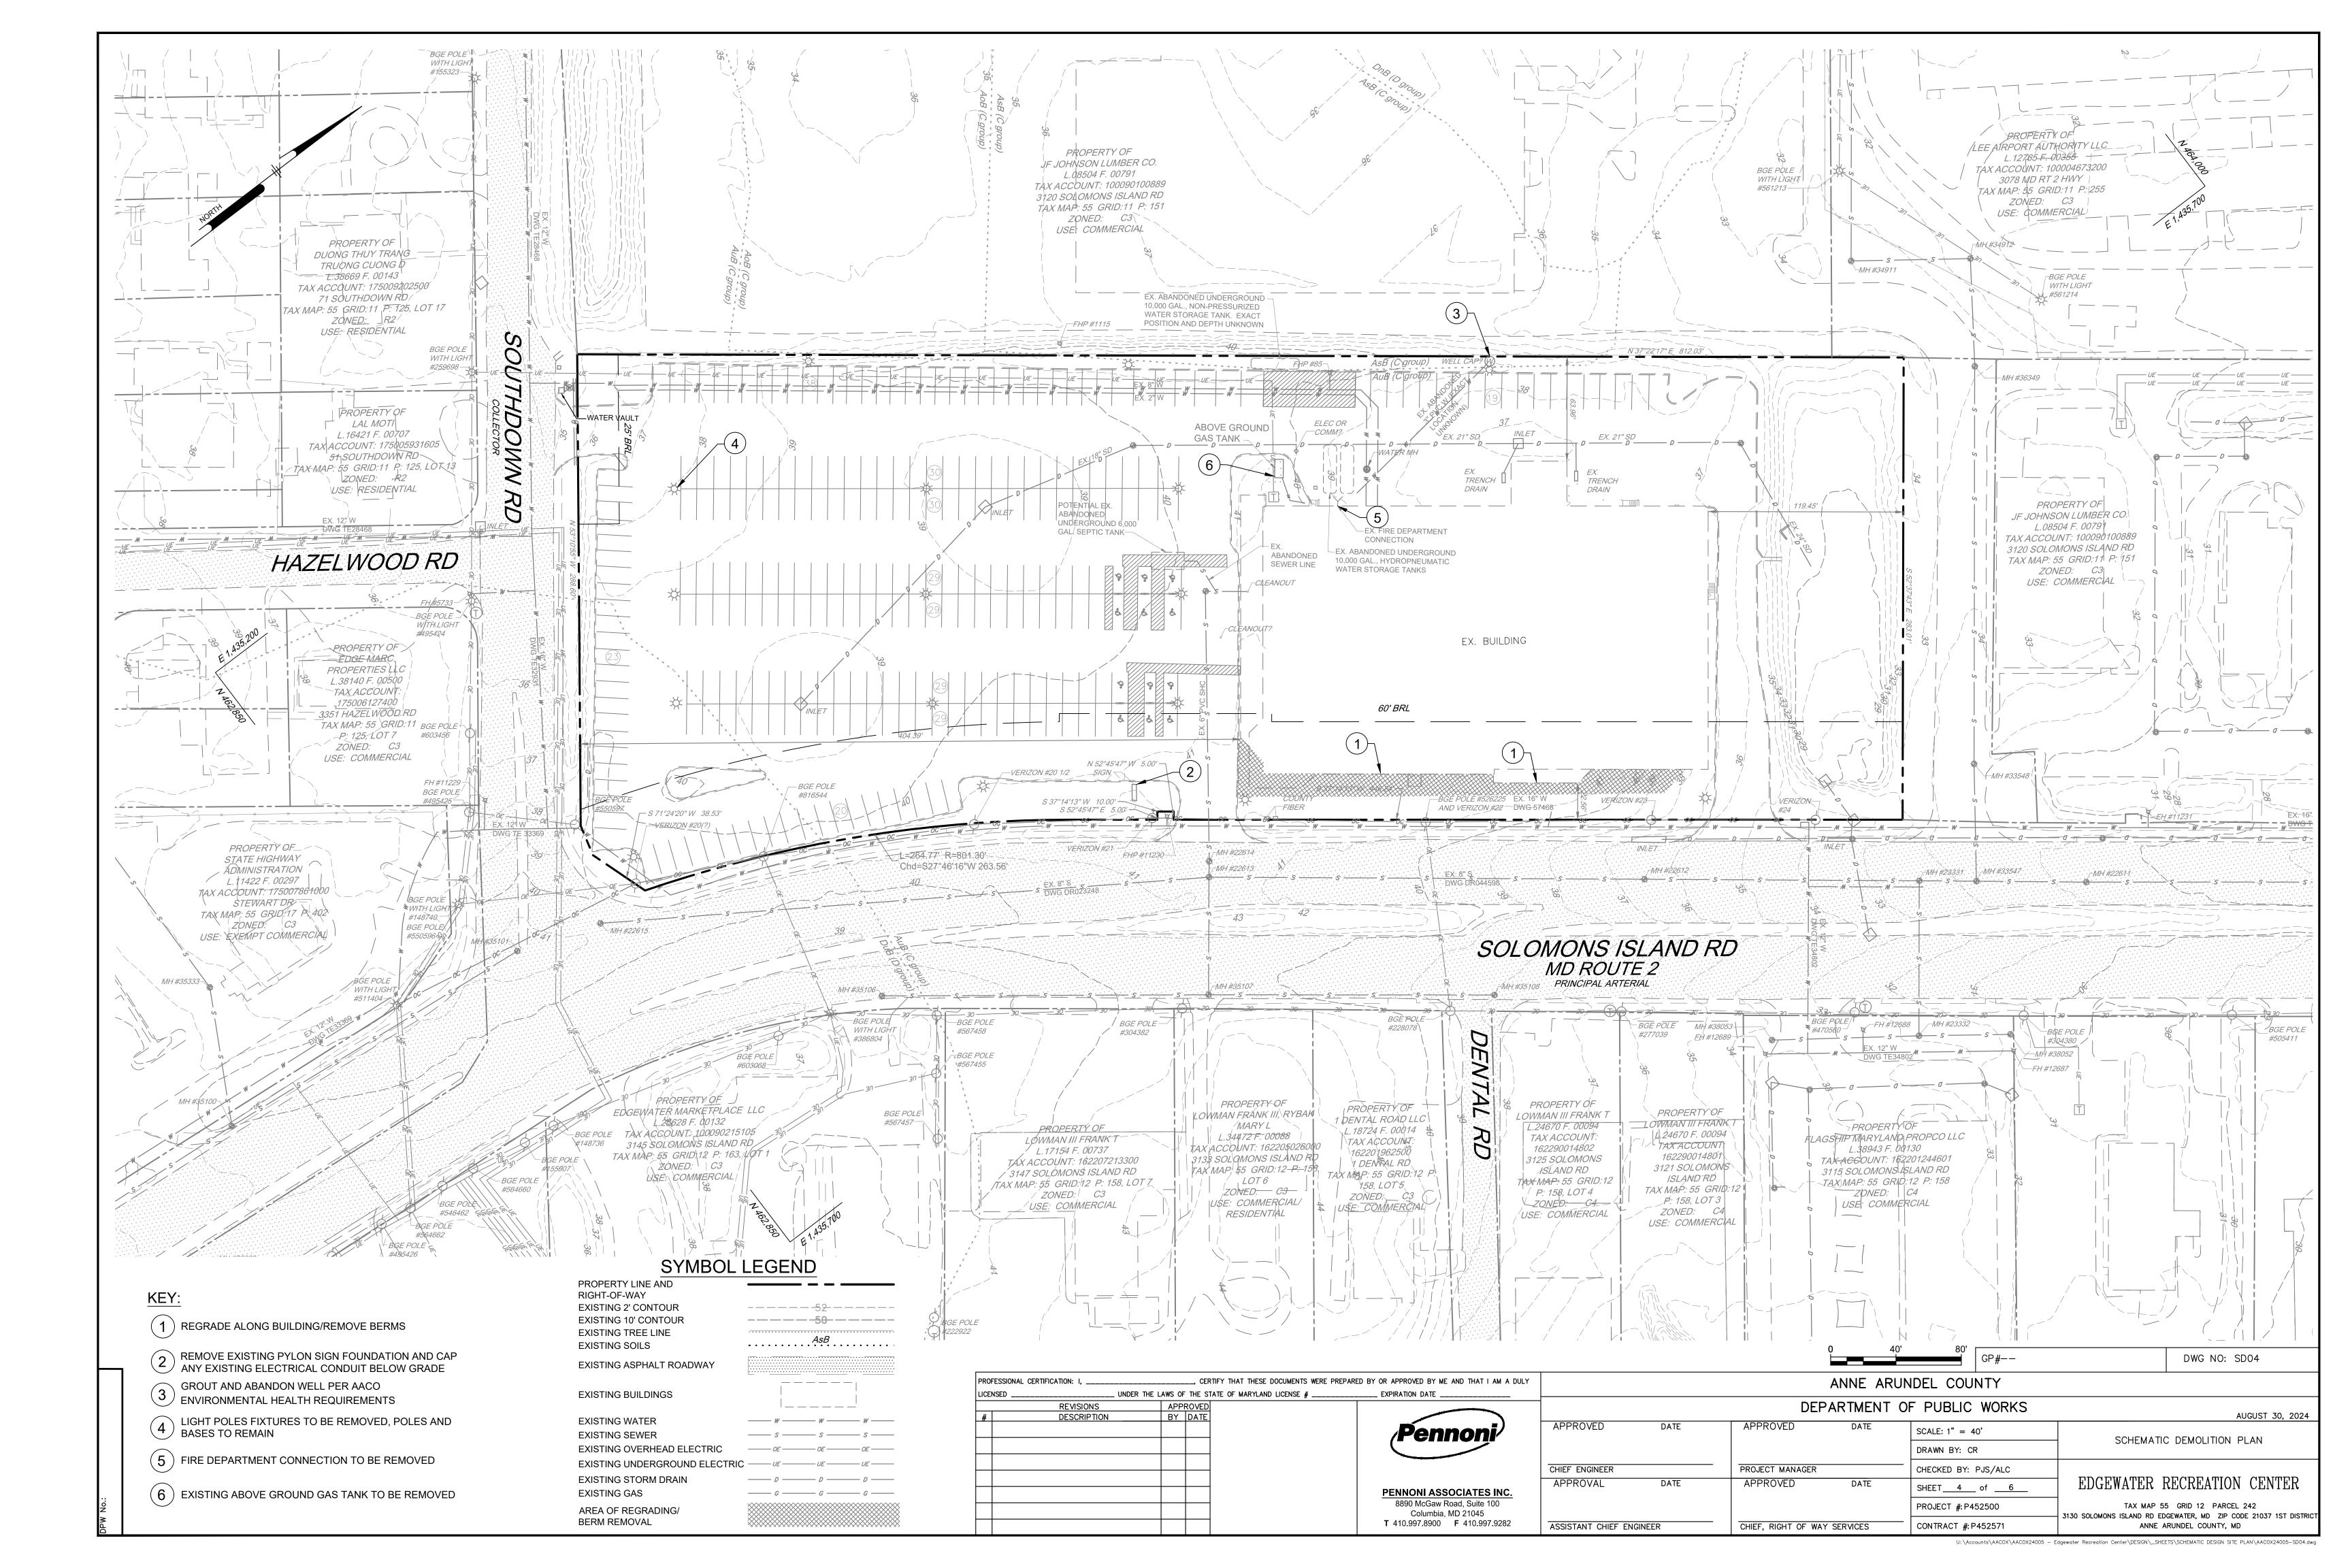

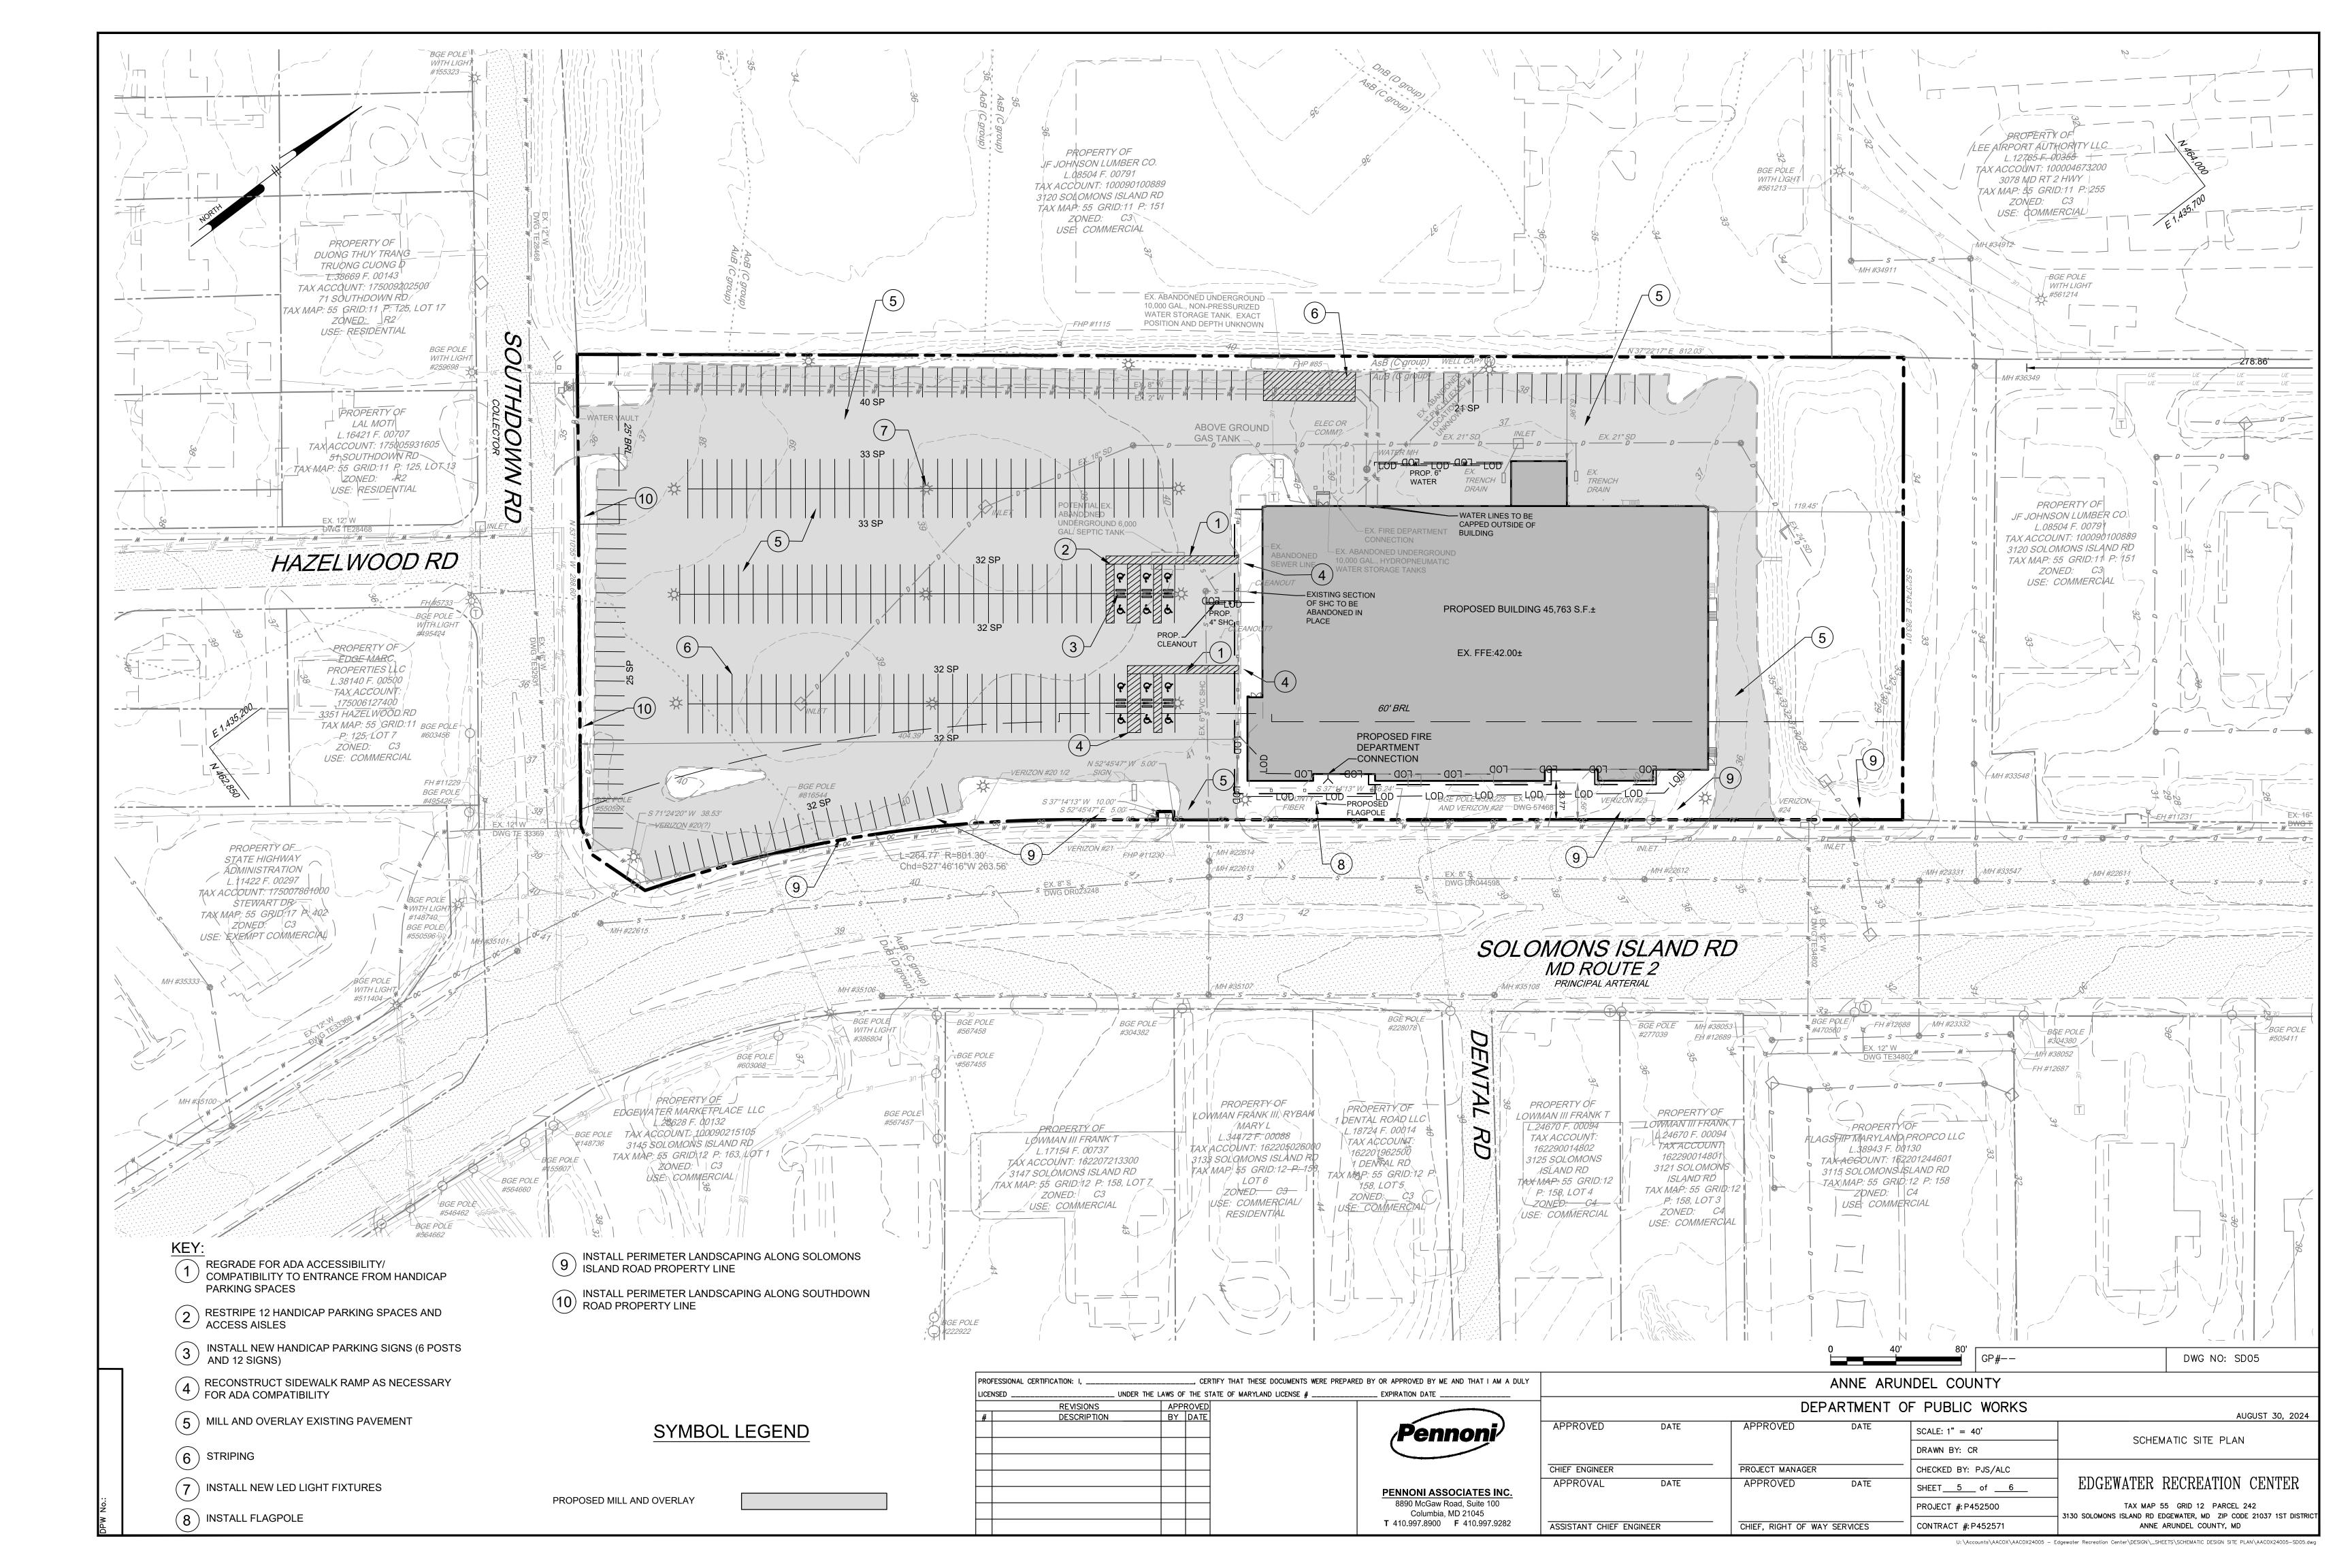

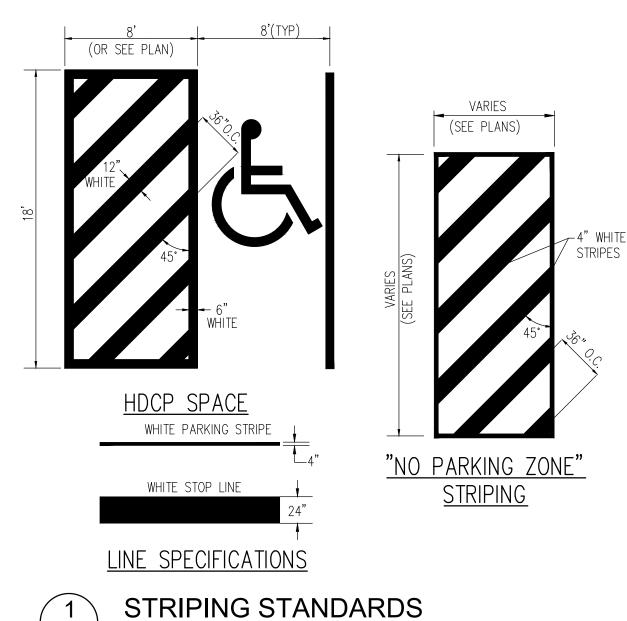

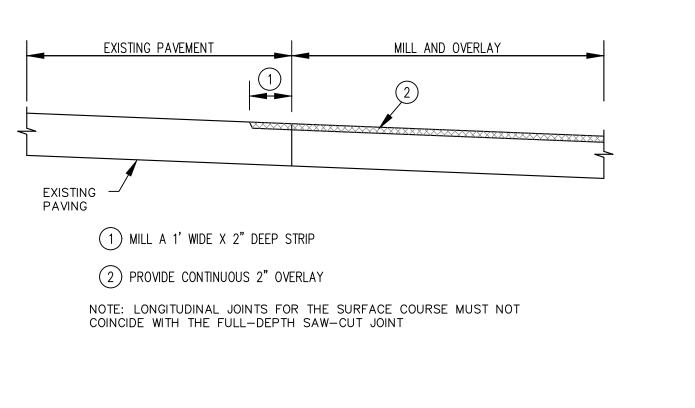

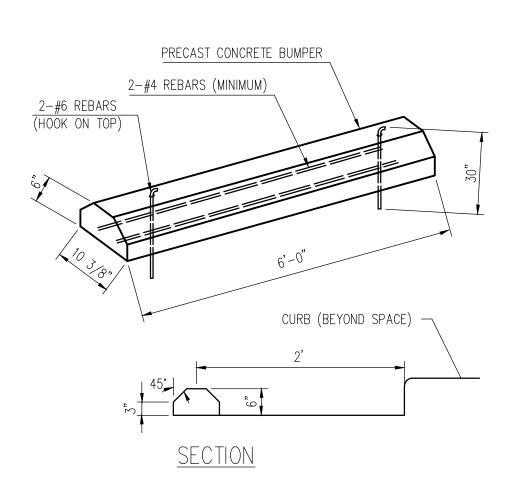











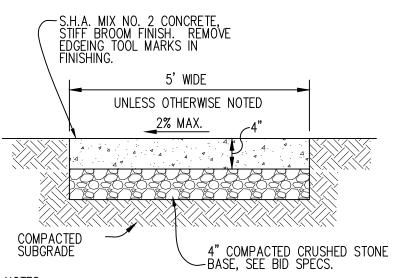

1. PROVIDE LATITUDINAL EXPANSION JOINTS AT 15' O.C. (MAX.) 2. PROVIDE CONTRACTION (DUMMY) JOINT AT 5' O.C. INTERVALS BETWEEN EXPANSION JOINTS. SIDEWALK TO BE SCRIBED IN 5' MAX. SQUARES. CONTRACTOR TO AVOID THE CREATION OF SMALL SCORED AREAS THAT WILL CRACK AND BREAK OFF FROM SIDWALK. 3. SIDEWALK CROSS SLOPE SHALL NOT EXCEED 2%. 4. CONCRETE SHALL BE 3,000 PSI.



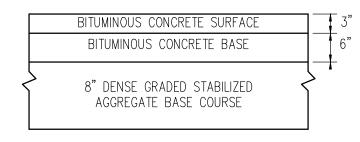


NOTE:
THE PAVING SECTION SHOWN HAS NOT BEEN DESIGNED FOR IN PLACE COMPACTION RESULTS. IT IS RECOMMENDED THAT THE USER CONSULT WITH A LICENSED PROFESSIONAL GEOTECHNICAL ENGINEER FOR A SPECIFIC PAVING DESIGN BASED ON THE APPROPRIATE PARAMETERS DURING CONSTRUCTION AND PRIOR TO INSTALLATION OF THIS PAVING SECTION.


NOTE: HEAVY DUTY PAVING TO BE USED WHERE UTILITY EXTENSIONS ARE PROPOSED.



					GP#	DWG NO: SD06
PROFESSIONAL CERTIFICATION: I,, CERTIFY THAT THESE DOCUMENTS WERE PREPARED BY OR APPROVED BY ME AND THAT I	I AM A DULY			ANNE AR	UNDEL COUNTY	<u>'</u>
REVISIONS APPROVED # DESCRIPTION BY DATE			DEF	PARTMENT	OF PUBLIC WORKS	AUGUST 30, 2024
Pennon	APPROVED	DATE	APPROVED	DATE	SCALE: AS SHOWN	
	;-				DRAWN BY: CR	SITE DETAILS
	CHIEF ENGINEER		PROJECT MANAGER		CHECKED BY: PJS/ALC	
PENNONI ASSOCIATES	APPROVAL SINC.	DATE	APPROVED	DATE	SHEET6 of6	EDGEWATER RECREATION CENTER
8890 McGaw Road, Suite 1 Columbia, MD 21045	100				PROJECT #: P452500	TAX MAP 55 GRID 12 PARCEL 242
T 410 997 8900 F 410 997		LOINEED	- OUIEE BIOLIT OF WAY	V 050 4050	CONTRACT # DAFOE71	3130 SOLOMONS ISLAND RD EDGEWATER, MD ZIP CODE 21037 1ST DISTRI

T 410.997.8900 F 410.997.9282 ASSISTANT CHIEF ENGINEER __ | CONTRACT #: P452571 CHIEF, RIGHT OF WAY SERVICES ANNE ARUNDEL COUNTY, MD U:\Accounts\AACOX\AACOX24005 — Edgewater Recreation Center\DESIGN_SHEETS\SCHEMATIC DESIGN SITE PLAN\AACOX24005—SD06.dwg

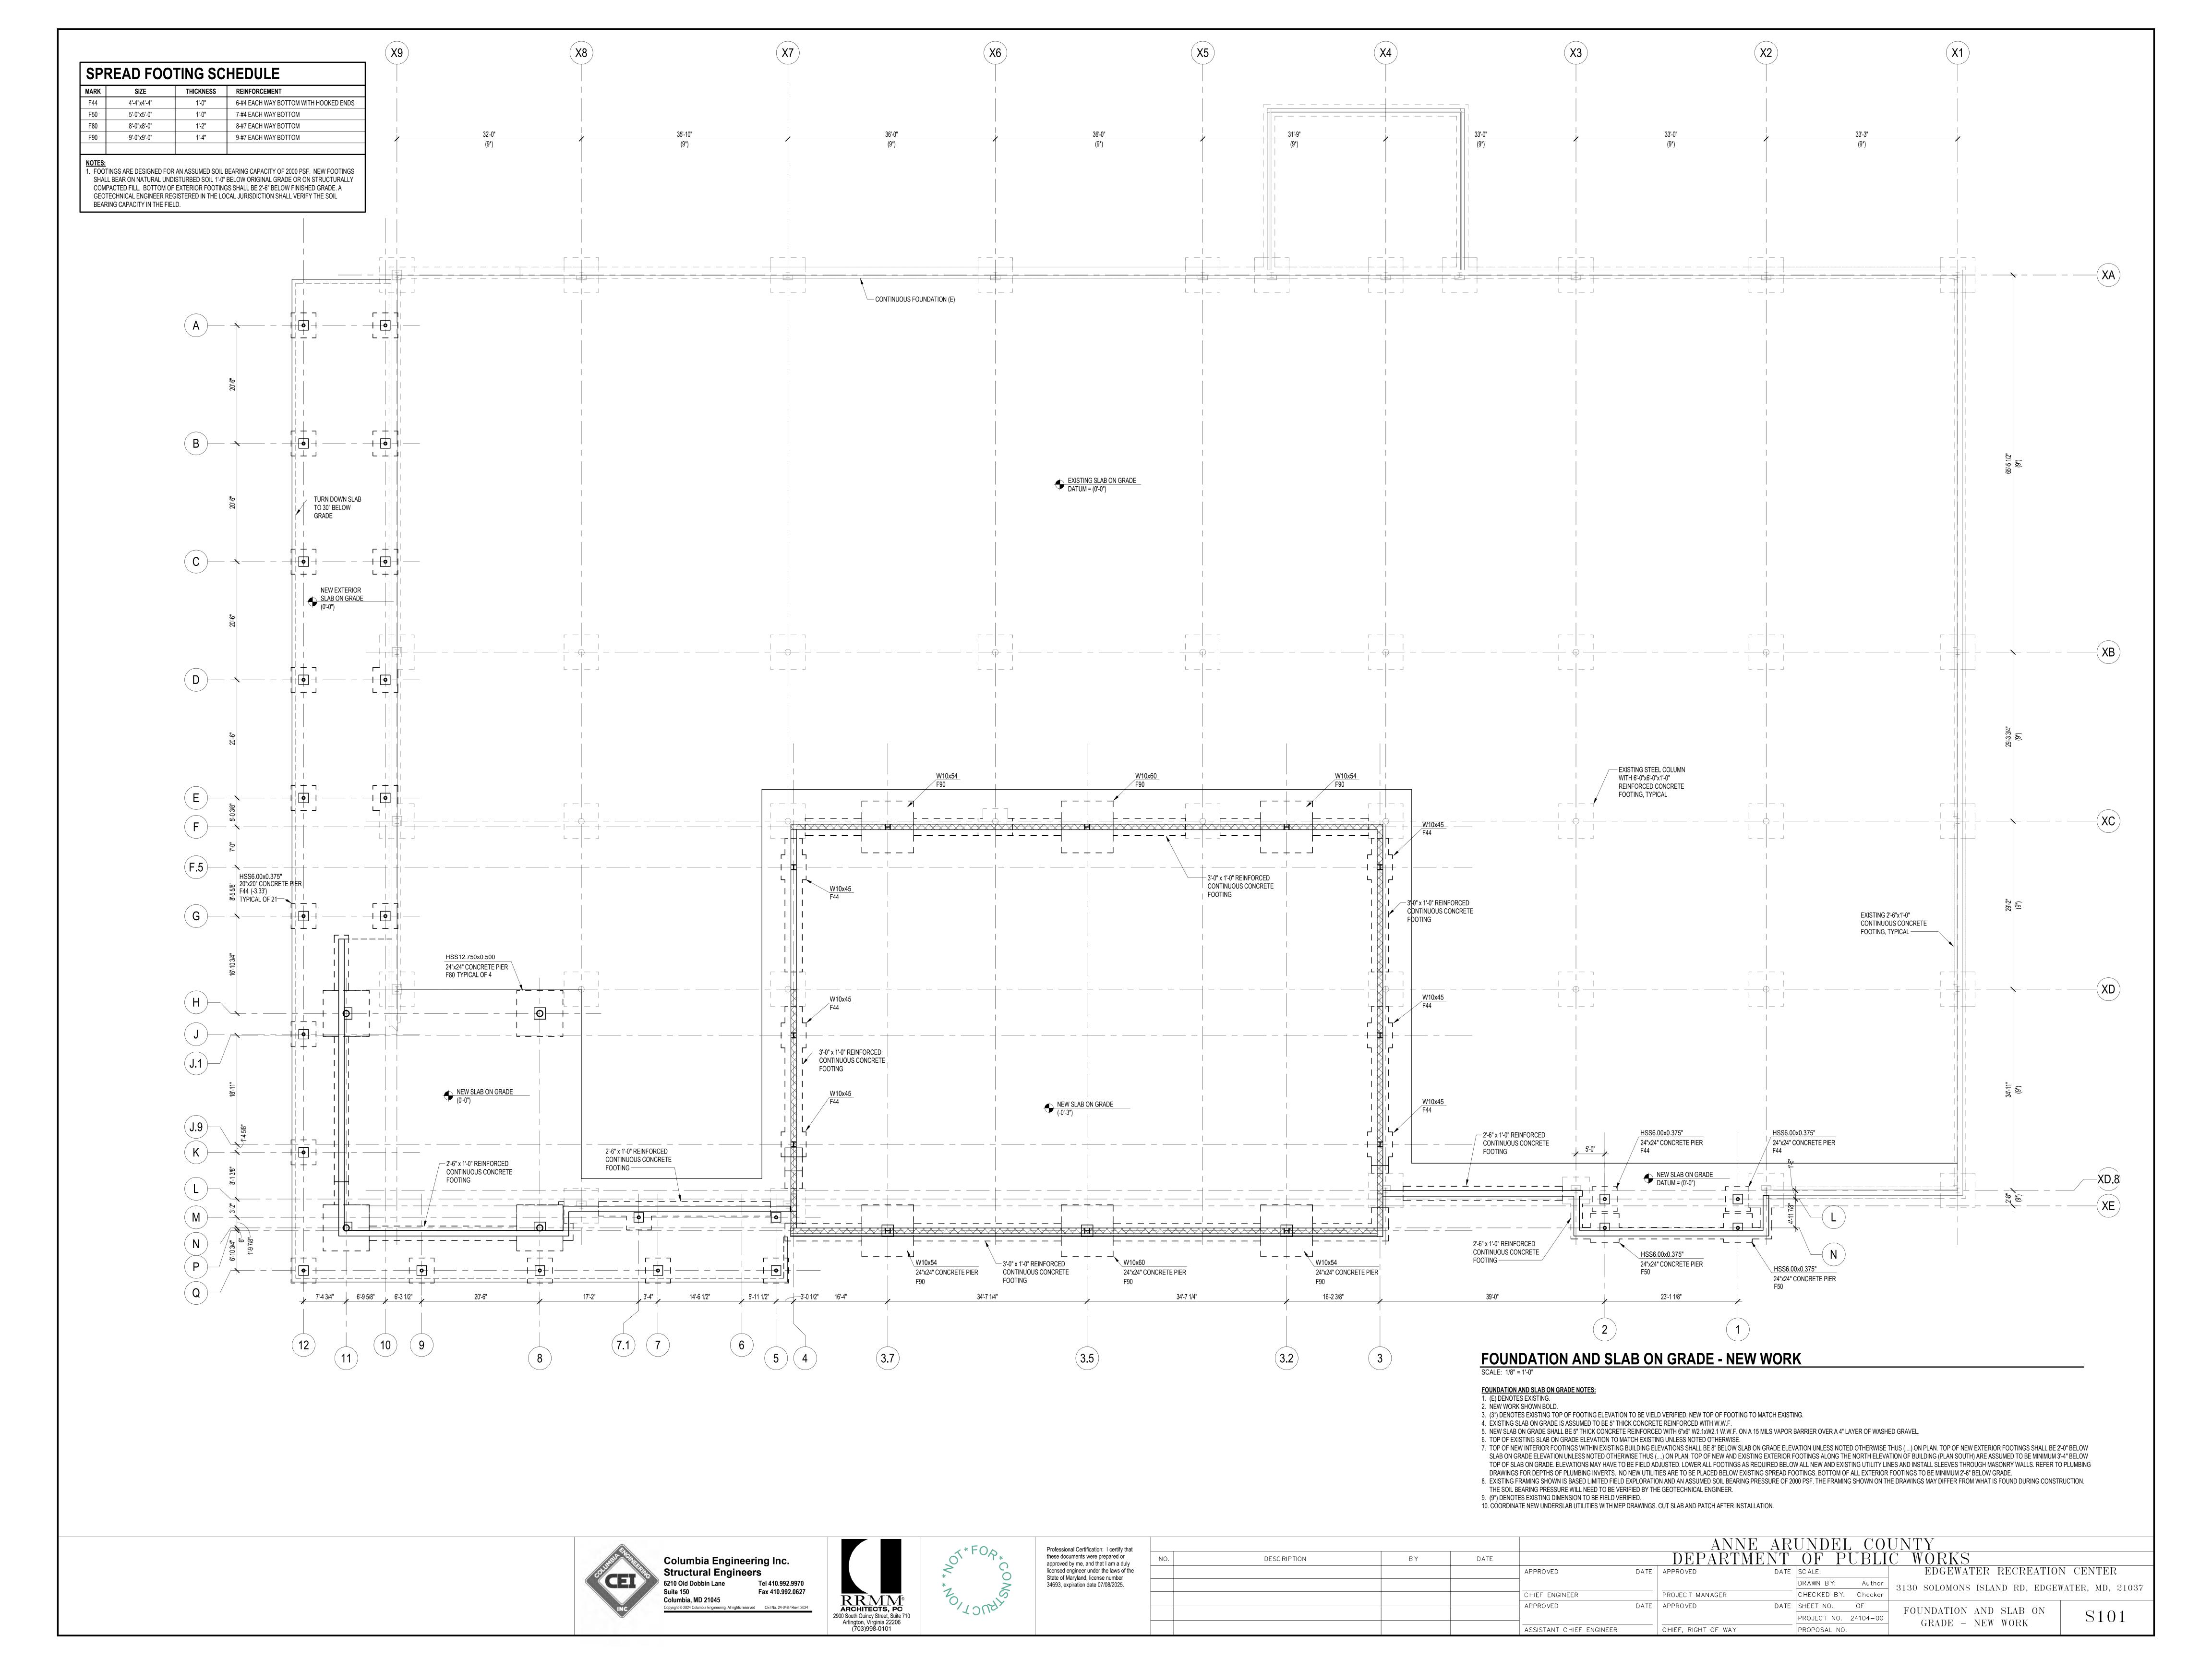

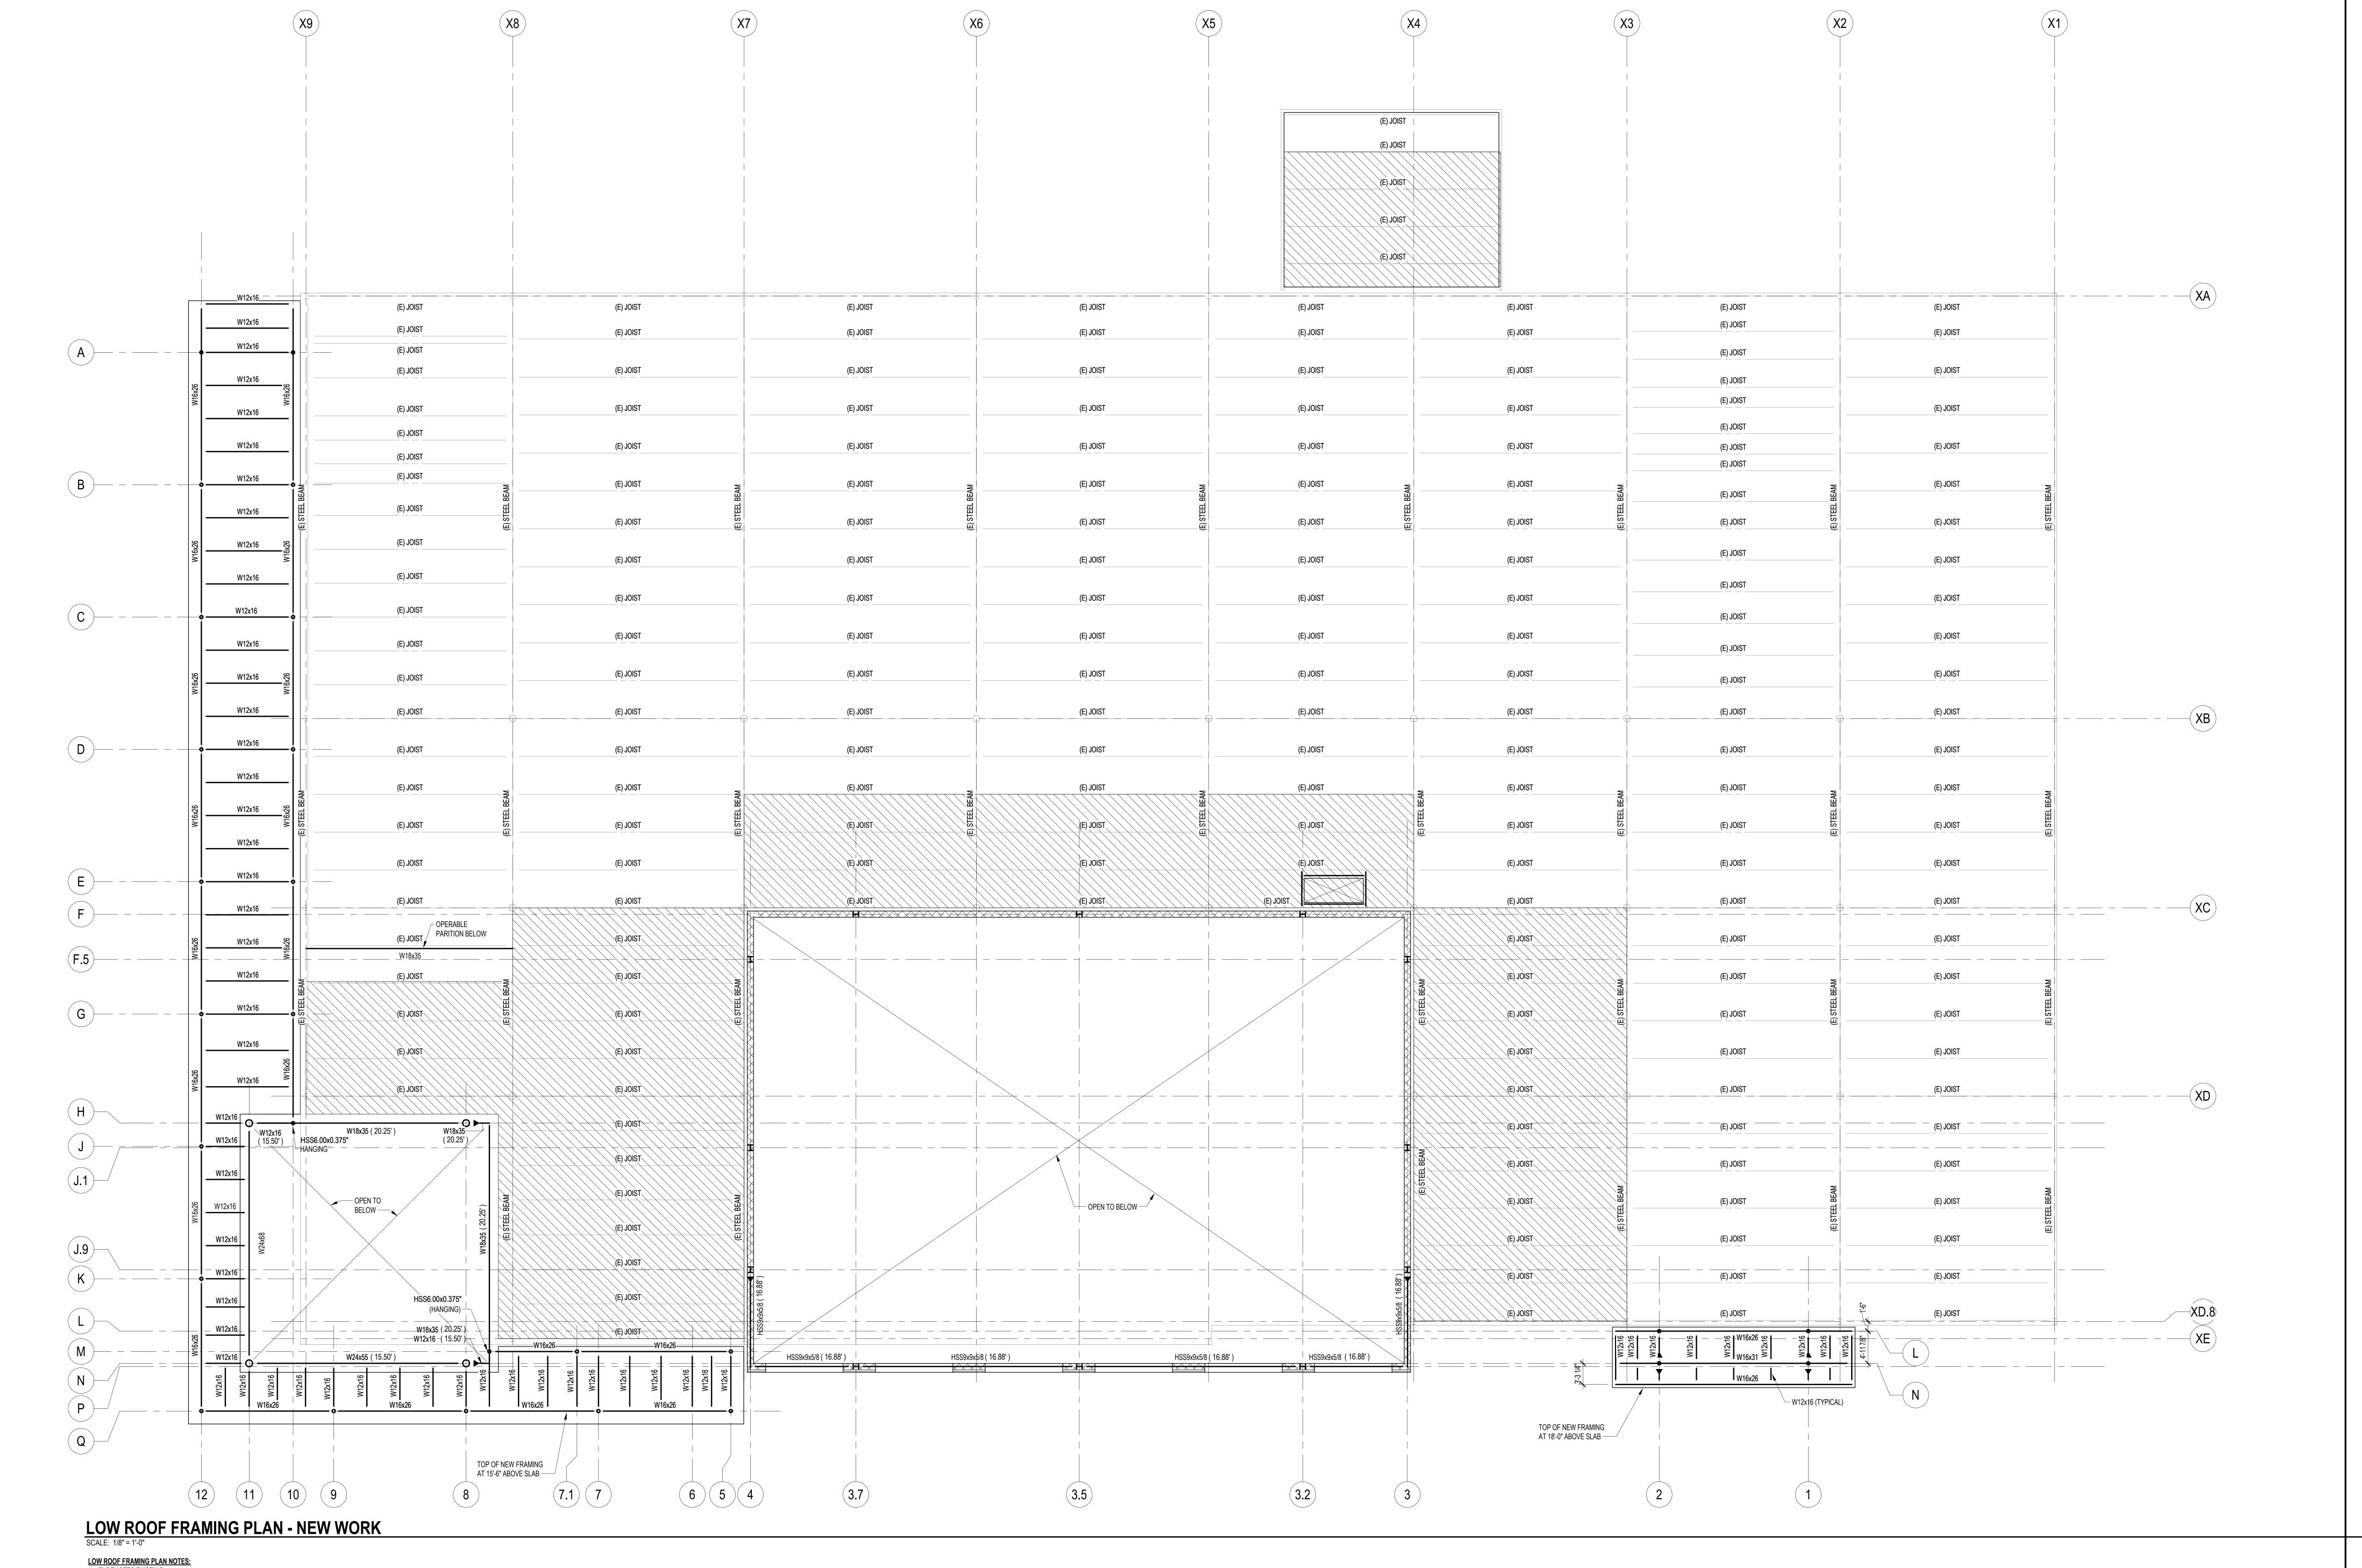

LOW ROOF FRAMING PLAN NO 1. (E) DENOTES EXISTING.

- 2. NEW WORK SHOWN BOLD.
 3. NEW ROOF DECK SHALL BE 1 1/2", 18 GAGE TYPE "B", GALVANIZED METAL ROOF DECK. NEW ROOF DECK AT GYMNASIUM SHALL BE 3", 18 GAGE TYPE "NA",
- 3. NEW ROOF DECK SHALL BE 1 1/2", 18 GAGE TYPE "B", GALVANIZED METAL ROOF DECK. NEW ROOF DECK AT GYMNASIUM SHALL BE 3", 18 GAGE TYPE "NA",

 GALVANIZED ACOUSTICAL METAL ROOF DECK.


 4. REQUIRE ANGLE FRAME AROUND ROOF ORENINGS WITH ONE SIDE LARGER THAN 41 0" RED TYPICAL ROOF ORENING RETAIL DO NOT SHE EXISTING POINTS OR REAMS.
- 4. PROVIDE ANGLE FRAME AROUND ROOF OPENINGS WITH ONE SIDE LARGER THAN 1'-0" PER TYPICAL ROOF OPENING DETAIL. DO NOT CUT EXISTING JOISTS OR BEAMS
 TO CREATE NEW OPENINGS.
 5. PROVIDE 5"x3 1/2"x3/18" ANGLE (LLV) UNDER ALL ROOF TOP UNITS. PROVIDE BLOCKING AS REQUIRED BETWEEN UNIT AND SUPPORTING STEEL. SUPPORT AT JOISTS
- OR BEAMS WITH 4"x4"x1/2"x8" LONG ANGLE SEAT. ROOF FRAMING IS STRUCTURALLY ADEQUATE FOR ROOFTOP UNITS SHOWN ON PLANS ONLY. CONTACT CEI IF LOCATION OR WEIGHT OF EQUIPMENT VARIES FROM THE LOCATIONS AND WEIGHTS SHOWN.

 6. HATCHED AREAS DENOTE ROOF TO BE REINFORCED FOR SNOW DRIFT LOADS. STEEL BEAMS AT HATCHED AREAS MAY NEED REINFORCING.








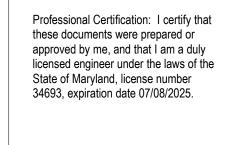

						ANNI	E AR	UNDEL CO	UNTY	
NO.	DESC RIPTION	BY	DATE			DEPARTM	ENT	OF PUBLI	C WORKS	
				APPROVED	DATE	APPROVED	DATE	SC ALE:	EDGEWATER RECREATION	CENTER
								DRAWN BY: Author	 3130 SOLOMONS ISLAND RD, EDGEW <i>A</i>	TER MD 21037
				CHIEF ENGINEER		PROJECT MANAGER		CHECKED BY: Checker	STOC SCHOOLS ISBNING IND, EDGENT	11EIV, 11D, 21001
				APPROVED	DATE	APPROVED	DATE	SHEET NO. OF	LOW ROOF FRAMING PLAN -	
								PROJECT NO. 24104-00	NEW WORK	S102
				ASSISTANT CHIEF ENGINEER		CHIEF, RIGHT OF WAY		PROPOSAL NO.	NEW WORK	

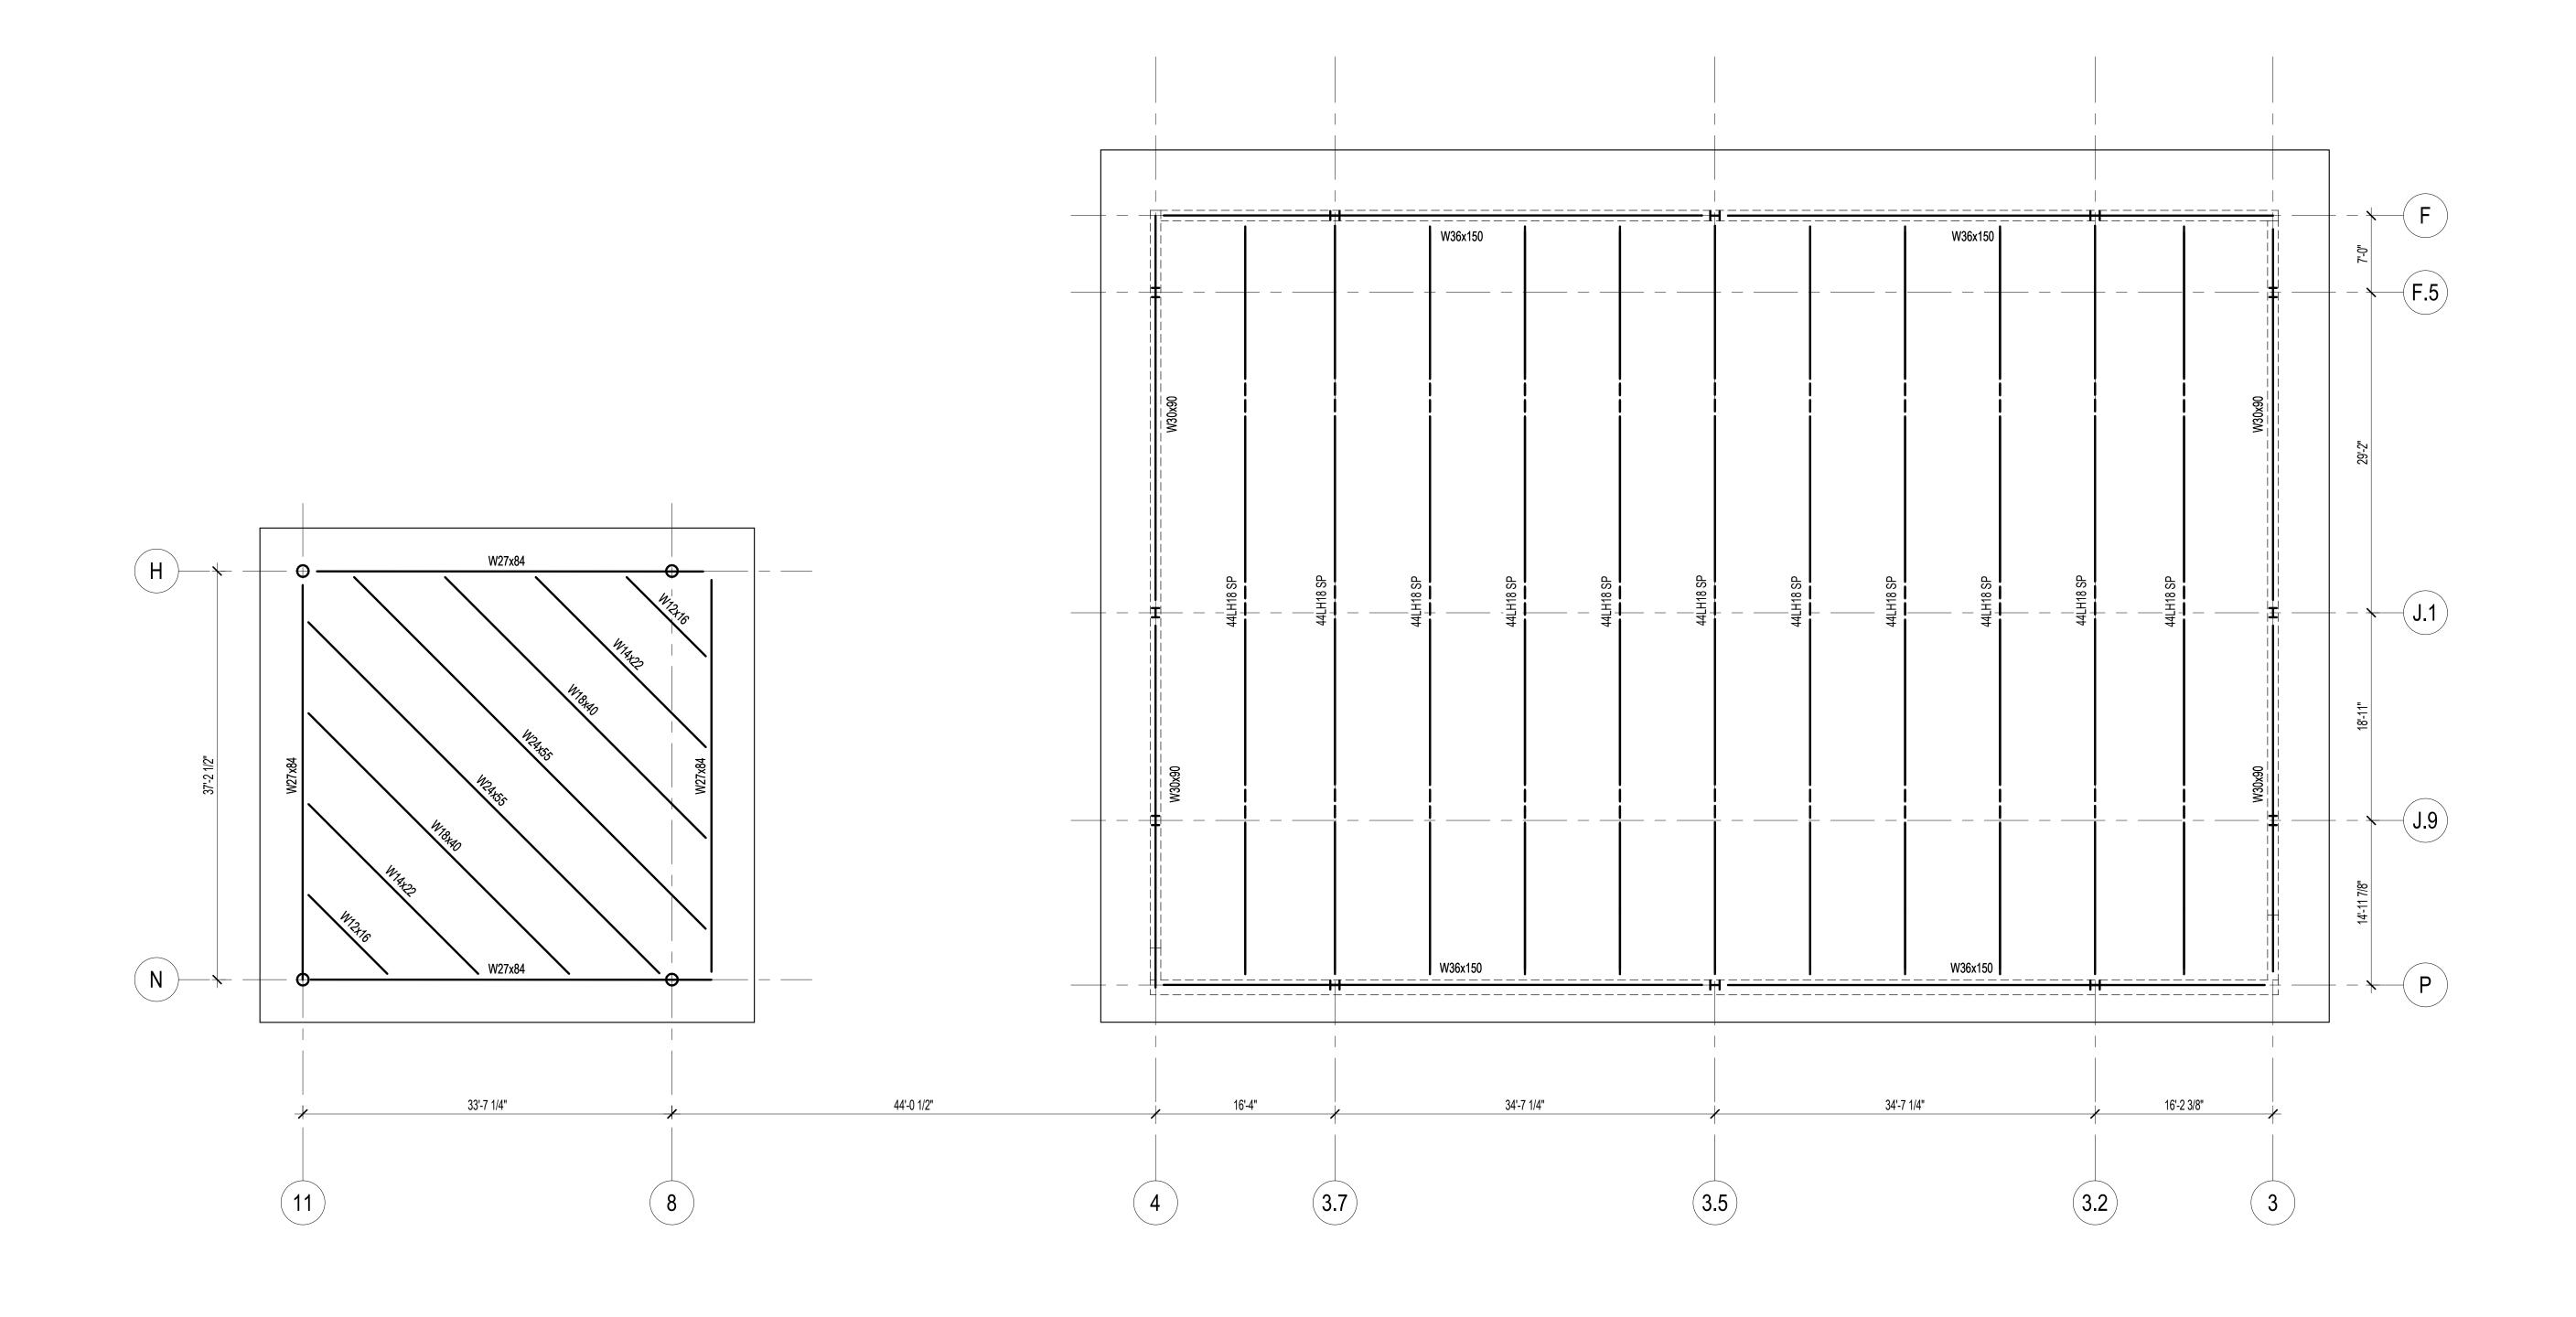


HIGE ROOF FRAMING PLAN - NEW WORK SCALE: 1/8" = 1'-0"

LOCATION OR WEIGHT OF EQUIPMENT VARIES FROM THE LOCATIONS AND WEIGHTS SHOWN.


HIGH ROOF FRAMING PLAN NOTES:
1. NEW ROOF FRAMING AT GYMNASIUM SHALL BE 3", 18 GAGE TYPE "NA", GALVANIZED ACOUSTICAL METAL ROOF DECK. NEW ROOF FRAMING AT LOBBY SHALL BE 1 1/2", 18 GAGE TYPE "B", GALVANIZED METAL ROOF DECK. 2. PROVIDE ANGLE FRAME AROUND ROOF OPENINGS WITH ONE SIDE LARGER THAN 1'-0" PER TYPICAL ROOF OPENING DETAIL. DO NOT CUT EXISTING JOISTS OR BEAMS

3. PROVIDE 5"x3 1/2"x3/18" ANGLE (LLV) UNDER ALL ROOF TOP UNITS. PROVIDE BLOCKING AS REQUIRED BETWEEN UNIT AND SUPPORTING STEEL. SUPPORT AT JOISTS OR BEAMS WITH 4"x4"x1/2"x8" LONG ANGLE SEAT. ROOF FRAMING IS STRUCTURALLY ADEQUATE FOR ROOFTOP UNITS SHOWN ON PLANS ONLY. CONTACT CEI IF

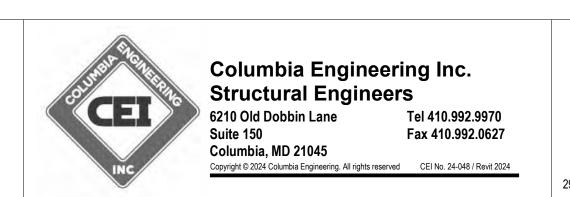






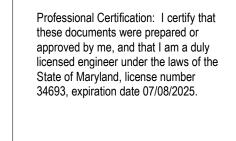


hat			ANNE ARI	UNDEL COUNTY
ılv	NO. DESCRIPTION BY DATE		DEPARTMENT	OF PUBLIC WORKS
fthe	AF	APPROVED DATE	APPROVED DATE	SC ALE: EDGEWATER RECREATION CENTER
				DRAWN BY: Author 3130 SOLOMONS ISLAND RD, EDGEWATER, MD, 21037
	CI	CHIEF ENGINEER	PROJECT MANAGER	CHECKED BY: Checker
	AF	APPROVED DATE	APPROVED DATE	SHEET NO. OF HIGH ROOF FRAMING PLAN -
				PROJECT NO. 24104-00 HIGH ROOF FRAMING PLAN - NEW WORK S103
		ASSISTANT CHIEF ENGINEER	CHIEF, RIGHT OF WAY	PROPOSAL NO.

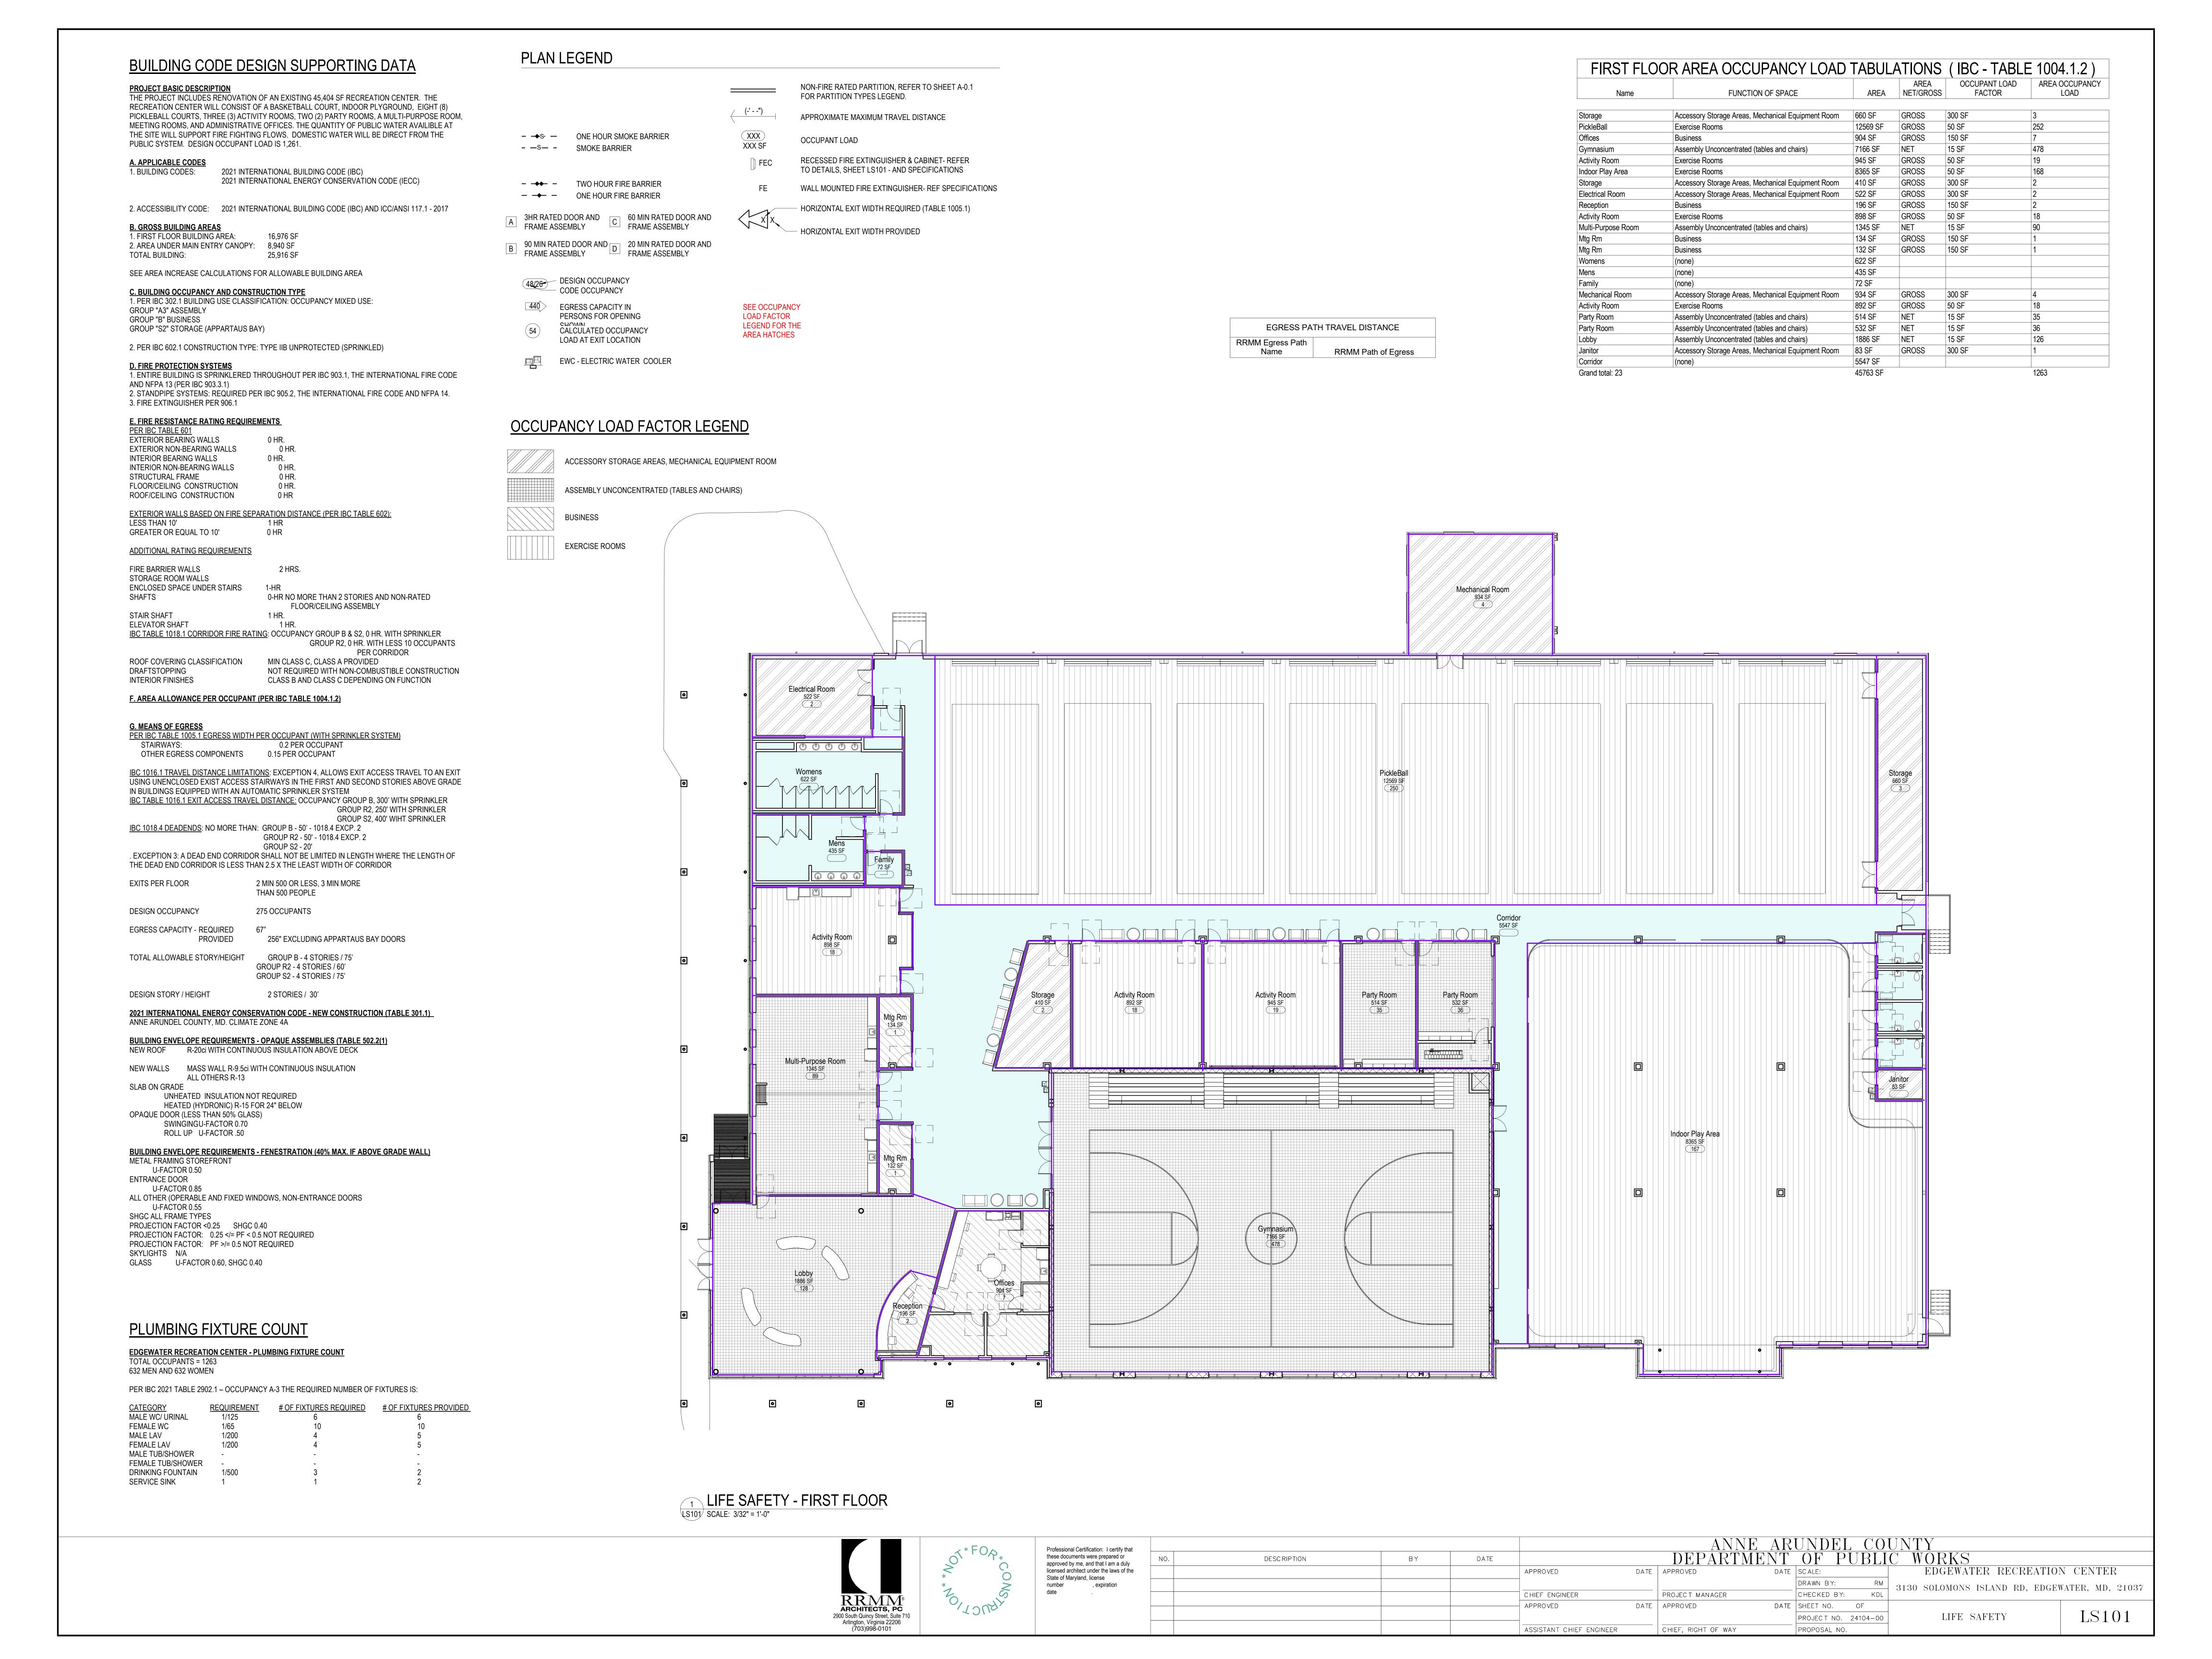


							ABBREVIA	ATIONS							
#	NUMBER	CCTV	CLOSED CIRCUIT TELEVISION	DWG	DRAWING	FRMG	FRAMING	JT	JOINT	NRC	NOISE REDUCTION COEFFICIENT	REQD	REQUIRED	THRES	THRESHOLD
&, +	AND	CEM	CEMENT	DWR	DRAWER	FRP	FIBERGLASS REINFORCED PLASTIC			NTS	NOT TO SCALE	REQMT	REQUIREMENT	THRU	THROUGH
+/-	PLUS OR MINUS	CEM TOP	CEMENT TOPPING			FRT	FIRE RETARDANT TREATED	KIT	KITCHEN			RESIL	RESILIENT	TO	TOP OF
ത	AT	CER	CERAMIC	F	EAST	FT	FOOT, FEET	KO	KNOCKOUT	OA	OVERALL	RET	RETURN	TOC	TOP OF CURB
<u>@</u>	DEGREES	CF	CUBIC FOOT	EΔ	EACH	FTG	FOOTING	KV	KILOVOLT	OBS	OBSCURE	REV	REVISION, REVISIONS, REVISED	TOM	TOP OF MASONRY
Ø	DIAMETER	CFLSHG	COUNTER FLASHING	EF.	EXHAUST FAN	FUM	FUME HOOD	KVA	KILOVOLT AMPERE	000	ON CENTER	REG	ROOFING	TOS	TOP OF STEEL
ν Ο	ARC LENGTH	CFM	CUBIC FEET PER MINUTE	EFS	EXTERIOR FINISH SYSTEM	FUR	FURRED, FURRING	KW	KILOWATT	OD	OUTSIDE DIAMETER	DEI	REFLECT, REFLECTED, REFLECTIVE	TOW	TOP OF WALL
22	ANG LENGTT	CG	CORNER GUARD		EXTERIOR INSULATION FINISH SYSTEM	FURN	FURNITURE	rvv	RILOWATT	OF/CI	OWNER FURNISHED / CONTRACTOR		RIGHT HAND	TD	TOILET PARTITION
A /C	AIR CONDITIONING		CHAMFER CHAMFER	EIFS	EXPANSION JOINT		FURRING		LENGTH, LONG, LOW	OF/CI	INSTALLED	KΠ		TPT	
AD.		CHAM		EJ		FURR	FURRING	L		OH	OVERHEAD	RL DM	RAIN LEADER ROOM	TRTD	TEXTURED PAINT TREATED
ADV	ANCHOR BOLT	CI	CAST IRON	ELAS	ELASTOMERIC	0	040	LAB	LABORATORY	OPNG	OPENING	RIVI			
ABV	ABOVE	CIP	CAST IN PLACE	ELEC	ELECTRICAL ELEVATOR	G	GAS	LAW	LAMINATE	OPP	OPPOSITE	RU	ROUGH OPENING	TSC	TEACHERS STORAGE CAI
ACM	ASBESTOS CONTAINING MATERIAL	CIR	CIRCLE	ELEV	ELEVATION, ELEVATOR	GA	GAUGE	LAV	LAVATORY	OFF	OFFOSITE	RSHI	RESILIENT SHEET	TTD	TOILET TISSUE DISPENSE
ACP	ACOUSTIC CEILING PANEL	CJ	CONTROL JOINT	EM	ENTRANCE MAT	GAL	GALLON	LB	POUND	D	DLATE	RI	RUBBER TILE / RUBBER TREAD	TV	TELEVISION
ACT	ACOUSTIC CEILING TILE	CK	CAULK, CAULKING	EMER	EMERGENCY	GALV	GALVANIZED	LF	LINEAR FEET	PAD	PLATE	RTU	ROOF TOP UNIT	TW	TEACHERS WARDROBE
ADDN	ADDITION	CLG	CEILING	ENCL	ENCLOSE, ENCLOSURE	GB	GRAB BAR	LG	LAMINATED GLASS	PAR	PARALLEL			TYP	TYPICAL
ADH	ADHESIVE	CLO	CLOSET	EP	ELECTRICAL PANELBOARD	GC	GENERAL CONTRACT, CONTRACTOR	LH	LEFT HAND	PARI	PARTIAL PIECE	S	SOUTH		
ADJ	ADJUSTABLE	CLR	CLEAR	EPDM	ETHYLENE PROPYLENE DIENE	GCMU	GLAZED FIBER REINFORCED CONCRETE	LIN	LINEAR	PC	PRE-CAST, PIECE	S/S	STAINLESS STEEL, SERVICE SINK	UC	UNDERCUT
AFF	ABOVE FINISH FLOOR	CM	CENTIMETER, CENTIMETERS		MONOMER	GEN	GENERAL	LK	LOCKER	PED	PEDESTAL	SAB	SOUND ATTENUATION BLANKET	UG	UNDER GROUND
AGG	AGGREGATE	CMP	CORRUGATED METAL PIPE	EPS	EXPANDED POLYSTYRENE	GFRC	GLASS FIBER REINFORCED CONCRETE	LLH	LONG LEG HORIZONTAL	PERF	PERFORATE (D)	SAN	SANITARY SEWER	UH	UNIT HEATER
AHU	AIR HANDLING UNIT	CMU	CONCRETE MASONRY UNIT	EPX	EPOXY	GL	GLASS, GLAZING	LLV	LONG LEG VERTICAL	PERM	PERIMETER	SAPC	SUSPENDED ACOUSTIC PANEL CEILING	UNF	UNFINISHED
AL	ALUMINUM	CNTR	COUNTER	EQ	EQUAL	GPM	GALLONS PER MINUTE	LP	LOW POINT	PIP	POURED IN PLACE	SC	SOLID CORE, SEALED CONCRETE	UON	UNLESS OTHERWISE NO
ALT	ALTERNATE	CO	CLEAN OUT	EQUIP	EQUIPMENT	GR	GRADE / GROUT	LTG	LIGHTING	PL	PROPERTY LINE / PLASTIC LAMINATE	SCHED	SCHEDULE		
AMP, A	AMPERE	COL	COLUMN	EST	ESTIMATE	GSU	GLAZED STRUCTURAL UNIT	LTL	LINTEL	PLAM	PLASTIC LAMINATE	SCW	SOLID CORE WOOD	V	VOLT, VALLEY
ANCH	ANCHOR, ANCHORAGE	COMM	COMMUNICATION	EWC	ELECTRIC WATER COOLER	GWB	GYPSUM WALLBOARD	LVR	LOUVER	PLAS	PLASTER	SD	SOAP DISPENSER, STORM DRAIN	VAC	VACUUM
ANOD	ANODIZED	COMP	COMPOSITE	EXCA	EXCAVATE	GWT	GLAZED WALL TILE	LW	LIGHTWEIGHT	PLUMB	PLUMBING	SEC	SECTION	VAR	VARNISH
ΔΡ	ACCESS POINT	CONC	CONCRETE	EXH	EXHAUST	GYP	GYPSUM	LVV	LIGHTWEIGHT	PLYWD	PLYWOOD	SE	SQUARE FEET	VR	VENTED BASE
APC	ARCHITECTURAL PRECAST CONCRETE	CONN	CONNECTION	EXIST	EXISTING	OII	OTT COM	M	METER	PNL	PANEL	SFGL	SAFETY GLASS	VCT	VINYL COMPOSITION TILE
APPROX	APPROXIMATE	CONST	CONSTRUCTION	EXP	EXPOSED / EXPANSION	ш	HIGH	M/S	MOP SINK	POLY	POLYURETHANE	SHLVG	SHELVING	VEN	VENEER
AFFROX		CONT		EXP C	EXPANSION CONSTRUCTION	H/C	HANDICAPPED	MACH	MACHINE	PORT	PORCELAIN TILE	SHM			VERTICAL
AROLL	ABUSE RESISTANT		CONTINUOUS	EXT	EXTERIOR	П/С		_		PORTB	PORCELAIN TILE BASE	_	SECURITY HOLLOW METAL	VERT	
ARCH	ARCHITECT, ARCHITECTURAL	CONTR	CONTRACT, CONTRACTOR	LXI	LATERIOR	HB	HOSE BIB	MAINT	MAINTENANCE	DDT	PRESERVATIVE PRESSURE TREATED	SHT	SHEET	VEST	VESTIBULE
ASB	ASBESTOS	CORR	CORRUGATED	ΓΛD	FARRICATE	HC	HOLLOW CORE	MANUF	MANUFACTURE, MANUFACTURER	ררו DD		SHTH	SHEATHING	VR	VAPOR RETARDER
ASPH	ASPHALT	CPT	CARPET	FAB	FABRICATE FACTEN FACTENER	HD	HAND	MAR	MARBLE	PR	PAIR	SIM	SIMILAR	VT	VINYL TILE
ATTEN	ATTENUATION	CRS	COURSE. COURSES	FAS	FASTEN, FASTENER	HDBD	HARDBOARD	MAS	MASONRY	PREFAB	PREFABRICATE, PREFABRICATED	SLR	SEALER	VTR	VENT THRU ROOF
AUTO	AUTOMATIC	CSMT	CASEMENT	FB FB	FACE BRICK	HDWD	HARDWOOD	MATL	MATERIAL	PREFIN	PRE-FINISHED	SN	STAGE NOSE	VWC	VINYL WALL COVERING
AVG	AVERAGE	CSWK	CASEWORK	FCVD	FLASH COVED	HDWR	HARDWARE	MAX	MAXIMUM	PRJ SC	PROJECTION SCREEN	SND	SANITARY NAPKIN DISPOSER		
AWP	ACOUSTIC WALL PANEL	CT	CERAMIC TILE	FD	FLOOR DRAIN, FIRE DAMPER	HGT	HEIGHT	MB	MARKERBOARD	PRT	PORCELAIN TILE	SOF	SPRAY-ON FIREPROOFING	W	WEST, WIDE, WIDTH
		CTB	CERAMIC TILE BASE	FDN	FOUNDATION	HM	HOLLOW METAL	MBR	MODIFIED BITUMEN ROOF	PS	PENCIL SHARPENER	SPEC	SPECIFICATION, SPECIFICATIONS	W/	WITH
BC	BOTTOM OF CURB	CU FT	CUBIC FEET	FE	FIRE EXTINGUISHER	HORIZ	HORIZONTAL	MECH	MECHANIC, MECHANICAL	PSF	POUNDS PER SQUARE FOOT	SPK	SPEAKER	W/O	WITHOUT
BD	BOARD	CU YD	CUBIC YARD	FEC	FIRE EXTINGUISHER CABINET	HP	HIGH POINT	MED	MEDIUM	PSI	POUNDS PER SQUARE INCH	SQ	SQUARE	WAIN	WAINSCOT
BEJ	BUILDING EXPANSION JOINT	CUH	CABINET UNIT HEATER	FEJ	FLOOR EXPANSION JOINT	HR	HOUR	MEMB	MEMBRANE	PT	PAINT	SS	SOLID SURFACE	WB	WOOD BASE
BETW	BETWEEN	CW	COLD WATER	FF	FINISH FLOOR	HTG	HEATING	MH	MANHOLE	PTD	PAINTED	ST	STAIN, STONE	WC	WATER CLOSET
BIT	BITUMINOUS	CWFP	CEMENTITIOUS WOOD FIBER PANELS	FFE	FINISH FLOOR ELEVATION	HVAC	HEATING, VENTILATION AND AIR	MIN	MINIMUM	PTN	PARTITION	STC	SOUND TRANSMISSION CLASS	WD	WOOD / WOOD FLOORING
BI	BLEACHER FINISH	J 1 1 1	SELLECTION TOOL TIDENT MILEO	FG	FIBER REINFORCED GYPSUM BOARD	117710	CONDITIONING	MIR	MIRROR	PVC	POLYVINYL CHLORIDE / PVC EDGE BAND	STD	STANDARD	WDB	WOOD FROOMING
BLDG	BUILDING	D	DEEP, DEPTH, DRAIN	FGL	FIBERGLASS	HW	HOT WATER	MISC	MISCELLANEOUS	PVMT	PAVEMENT	STFT	STOREFRONT	WDW	WINDOW
BI K	BLOCK	DBL	DOUBLE	FH	FIRE HYDRANT	HWH	HOT WATER HEATER	MLD	MOLDING	2		QTI	STEEL	WGL	WIRE GLASS
DI KU DEV	BLOCKING	DEMO	DEMOLITION	FHC	FIRE HOSE CABINET			MM	MILLIMETER	ΩT	QUARRY TILE	OTAD CTAD	STORAGE	νν G L \Λ <i>Ι</i> ⊔	WATER HEATER
BLKG	BEAM	DEMO DET / DTL	DETAIL	FIN	FINISH, FINISHED	ID	INSIDE DIAMETER		MASONRY OPENING	QTY	QUANTITY	STOR		V V I T \	
DV ואוח		DEI/DIL		FIX	FIXTURE	INI	INCH	MOD		S(II	Q0,	SIKUU	STRUCTURAL	VVI	WROUGHT IRON
ROT C	BOTTOM OF	DΕ	DRINKING FOUNTAIN	FLEX	FLEXIBLE	INCI	INCLUDE, INCLUDED, INCLUDING	MOD	MODIFIED	D	RISER, RIDGE	20R	SUBSTITUTE	WMS	WIRE MANAGEMENT SLO
BOT, B	BOTTOM	DH	DOUBLE HUNG	FLEX	FLOOR	INCL INFO	INFORMATION	MOV	MOVABLE	D/M/	RIGHT OF WAY	SUSP	SUSPENDED	WP	WATERPROOFING
BRG	BEARING	DIA	DIAMETER					MR	MAP RAIL	L/ / / /		SYM	SYMMETRICAL, SYMMETRY	WPT	WORKING POINT
BRK	BRICK	DIAG	DIAGONAL	FLSHG	FLASHING	INST	INSTALLATION	MT	MOUNT	KA	RETURN AIR	SYN	SYNTHETIC	WR	WASTE RECEPTACLE
BS	BOTH SIDES	DIM	DIMENSION	FLUOR	FLUORESCENT	INSUL	INSULATE, INSULATED, INSULATION	MTD	MOUNTED, MOUNTING	RAD	RADIUS	SYS	SYSTEM	WT	WEIGHT
BSMT	BASEMENT	DISP	DISPOSAL	FLUR	FLUORESCENT	INT	INTERIOR	MTL	METAL	RAS	RESILIENT ATHLETIC SURFACING			WWF	WELDED WIRE FABRIC
BTWN, B/W	BETWEEN	DIV	DIVISION	FND	FEMININE NAPKIN DISPENSER	INTRLK	INTERLOCK	MULL	MULLION	RB	RESILIENT BASE	T	TREAD	WWM	WELDED WIRE MESH
BUR	BUILT-UP ROOFING	DL	DEAD LOAD	FOC	FACE OF CONCRETE	INV	INVERT	MWP	MEMBRANE WATERPROOFING	RCP	REFLECTED CEILING PLAN	T&B	TOP & BOTTOM		
BVL	BEVELED	DMT	DEMOUNTABLE	FOM	FACE OF MASONRY					RD	ROOF DRAIN	TB	TACK BOARD		
		DN	DOWN	FOS	FACE OF STUDS	JAN	JANITOR	N	NORTH	RECP	RECEPTACLE	TEL	TELEPHONE		
С	CARPET	DPG	DAMPPROOFING	FP	FIREPROOF	JB	JUNCTION BOX	N/C	NO CHARGE	REF	REFERENCE	TEMP	TEMPORARY, TEMPERED		
CAB	CABINET	DPR	DISPENSER	FPL	FIREPLACE	JC	JANITOR CLOSET	NAT	NATURAL	REFRIG	REFRIGERATOR	TERR	TERRAZZO		
CAP	CAPACITY	DR	DOOR, DISPLAY RAIL	FR	FIRE RATED	JCT	JUNCTION	NIC	NOT IN CONTRACT	REINF	REINFORCE, REINFORCED,	TG	TONGUE & GROVE		
CR		DS	DOWNSPOUT	FRG	(GLASS) FIBER REINFORCED GYPSUM	JST	JOIST	NO	NUMBER	· -— · ·	REINFORCING	THK	THICK, THICKNESS		
CC	CHALKBOARD	טט	DOMINOLOGI	FRM	FRAME, FRAMED	55 1	55.51			REM	REMOVE	I □ [\	HIION, HIIONNESS		
	CUBICAL CURTAIN			I I XIVI	I IVANIE, I IVANIEU			NOM	NOMINAL		- · -				

ARCHITECTURAL MATERIAL LEGEND	
CONTINUOUS WOOD BLOCKING	ALUMINUM
CONCRETE MASONRY UNIT	FINISHED WOOD
CAST-IN-PLACE CONCRETE	WOOD BLOCKING
STEEL STEEL	BRICK
ELLE EARTH / COMPACT FILL	GLASS
BATT INSULATION	ACOUSTICAL TILE
POROUS FILL / GRAVEL	PLYWOOD
RIGID INSULATION	CERAMIC TILE - LARGE SCAL
GYPSUM BOARD	SAND/MORTAR/PLASTER
RESILIENT FLOORING / PLASTIC LAMINATE	සිසිස් GRAVEL

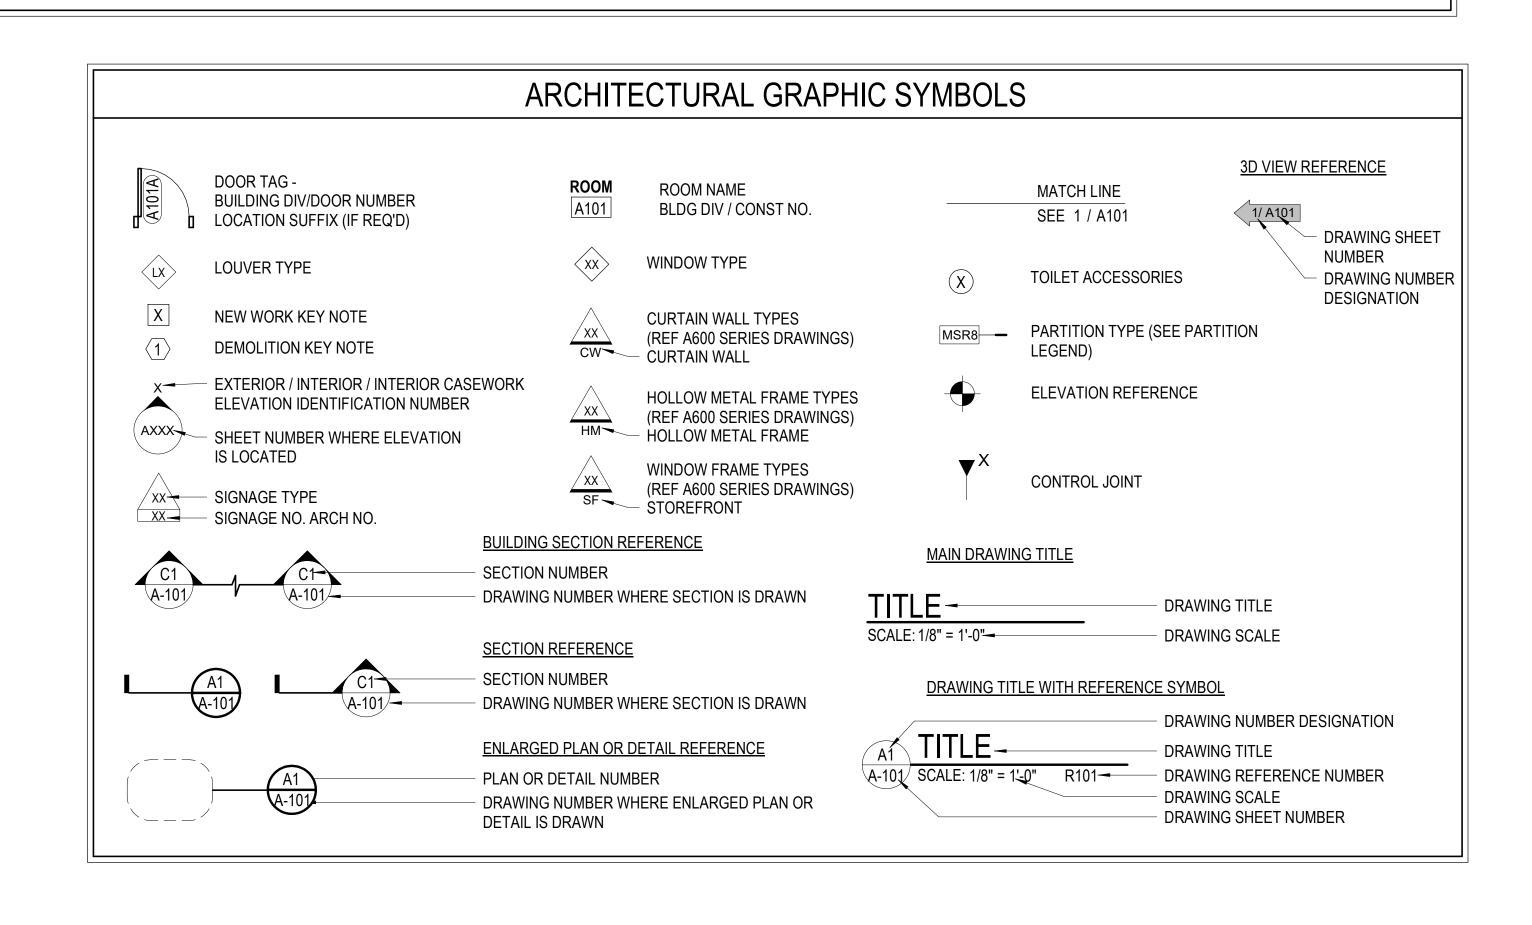





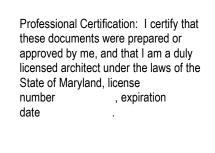


t						ANNE	AR	UNDEI	COU	UNTY	
•	NO.	DESC RIPTION BY	DATE			DEPARTME	NT	OF P	UBLI	C WORKS	
е				APPROVED	DATE	APPROVED	DATE	SC ALE:		EDGEWATER RECREATION	V CENTER
								DRAWN BY:	RM3	3130 SOLOMONS ISLAND RD, EDGEW	ATER MD 21037
				CHIEF ENGINEER		PROJECT MANAGER		CHECKED BY:	RM3	9190 BOHOMONG ISHMID ND, EDGEN	millio, mb, 21001
				APPROVED	DATE	APPROVED	DATE	SHEET NO.	OF	ARCHITECTURAL GENERAL	
						PRO	PROJECT NO.	24104-00		A - 001	
				ASSISTANT CHIEF ENGINEER		CHIEF, RIGHT OF WAY	_	PROPOSAL NO.		INFORMATION	



COVERED ENTRY WALKWAY



EXTERIOR

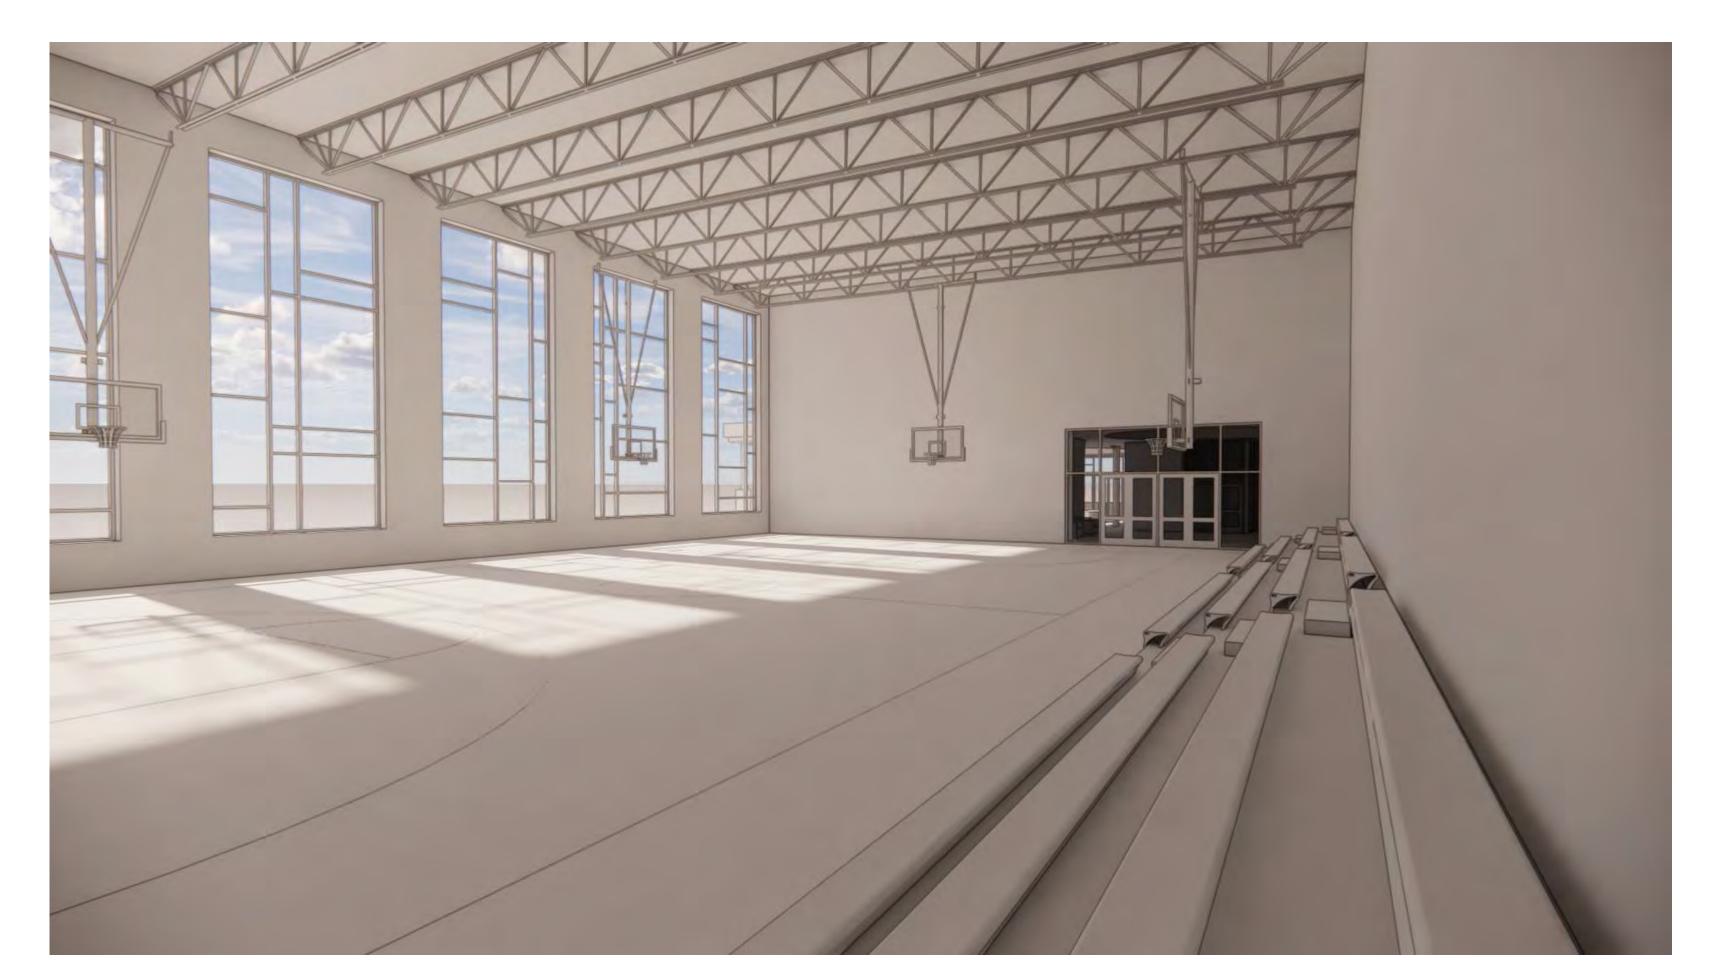

BASKETBALL COURT




ENTRY LOBBY




3D LONGITUDINAL SECTION







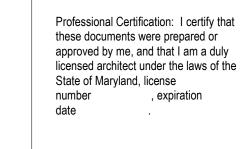

	ANNE ARUNDEL COUNTY											
NO.	DESC RIPTION	ВҮ	DATE			DEPARTMEN	$\overline{\mathrm{VT}}$	OF PUBLI	C WORKS			
				APPROVED	DATE	APPROVED	DATE	SC ALE:	EDGEWATER RECREATION	N CENTER		
								DRAWN BY: RM	 3130 SOLOMONS ISLAND RD, EDGEV	WATER MD 21037		
				CHIEF ENGINEER		PROJECT MANAGER		CHECKED BY: KDL	STOC BOLOMONS ISLAND ND, EDGL	millio, MD, 21007		
				APPROVED	DATE	APPROVED	DATE	SHEET NO. OF				
								PROJECT NO. 24104-00	ARCHITECTURAL RENDERINGS	A - 002		
				ASSISTANT CHIEF ENGINEER		CHIEF, RIGHT OF WAY	·	PROPOSAL NO.				

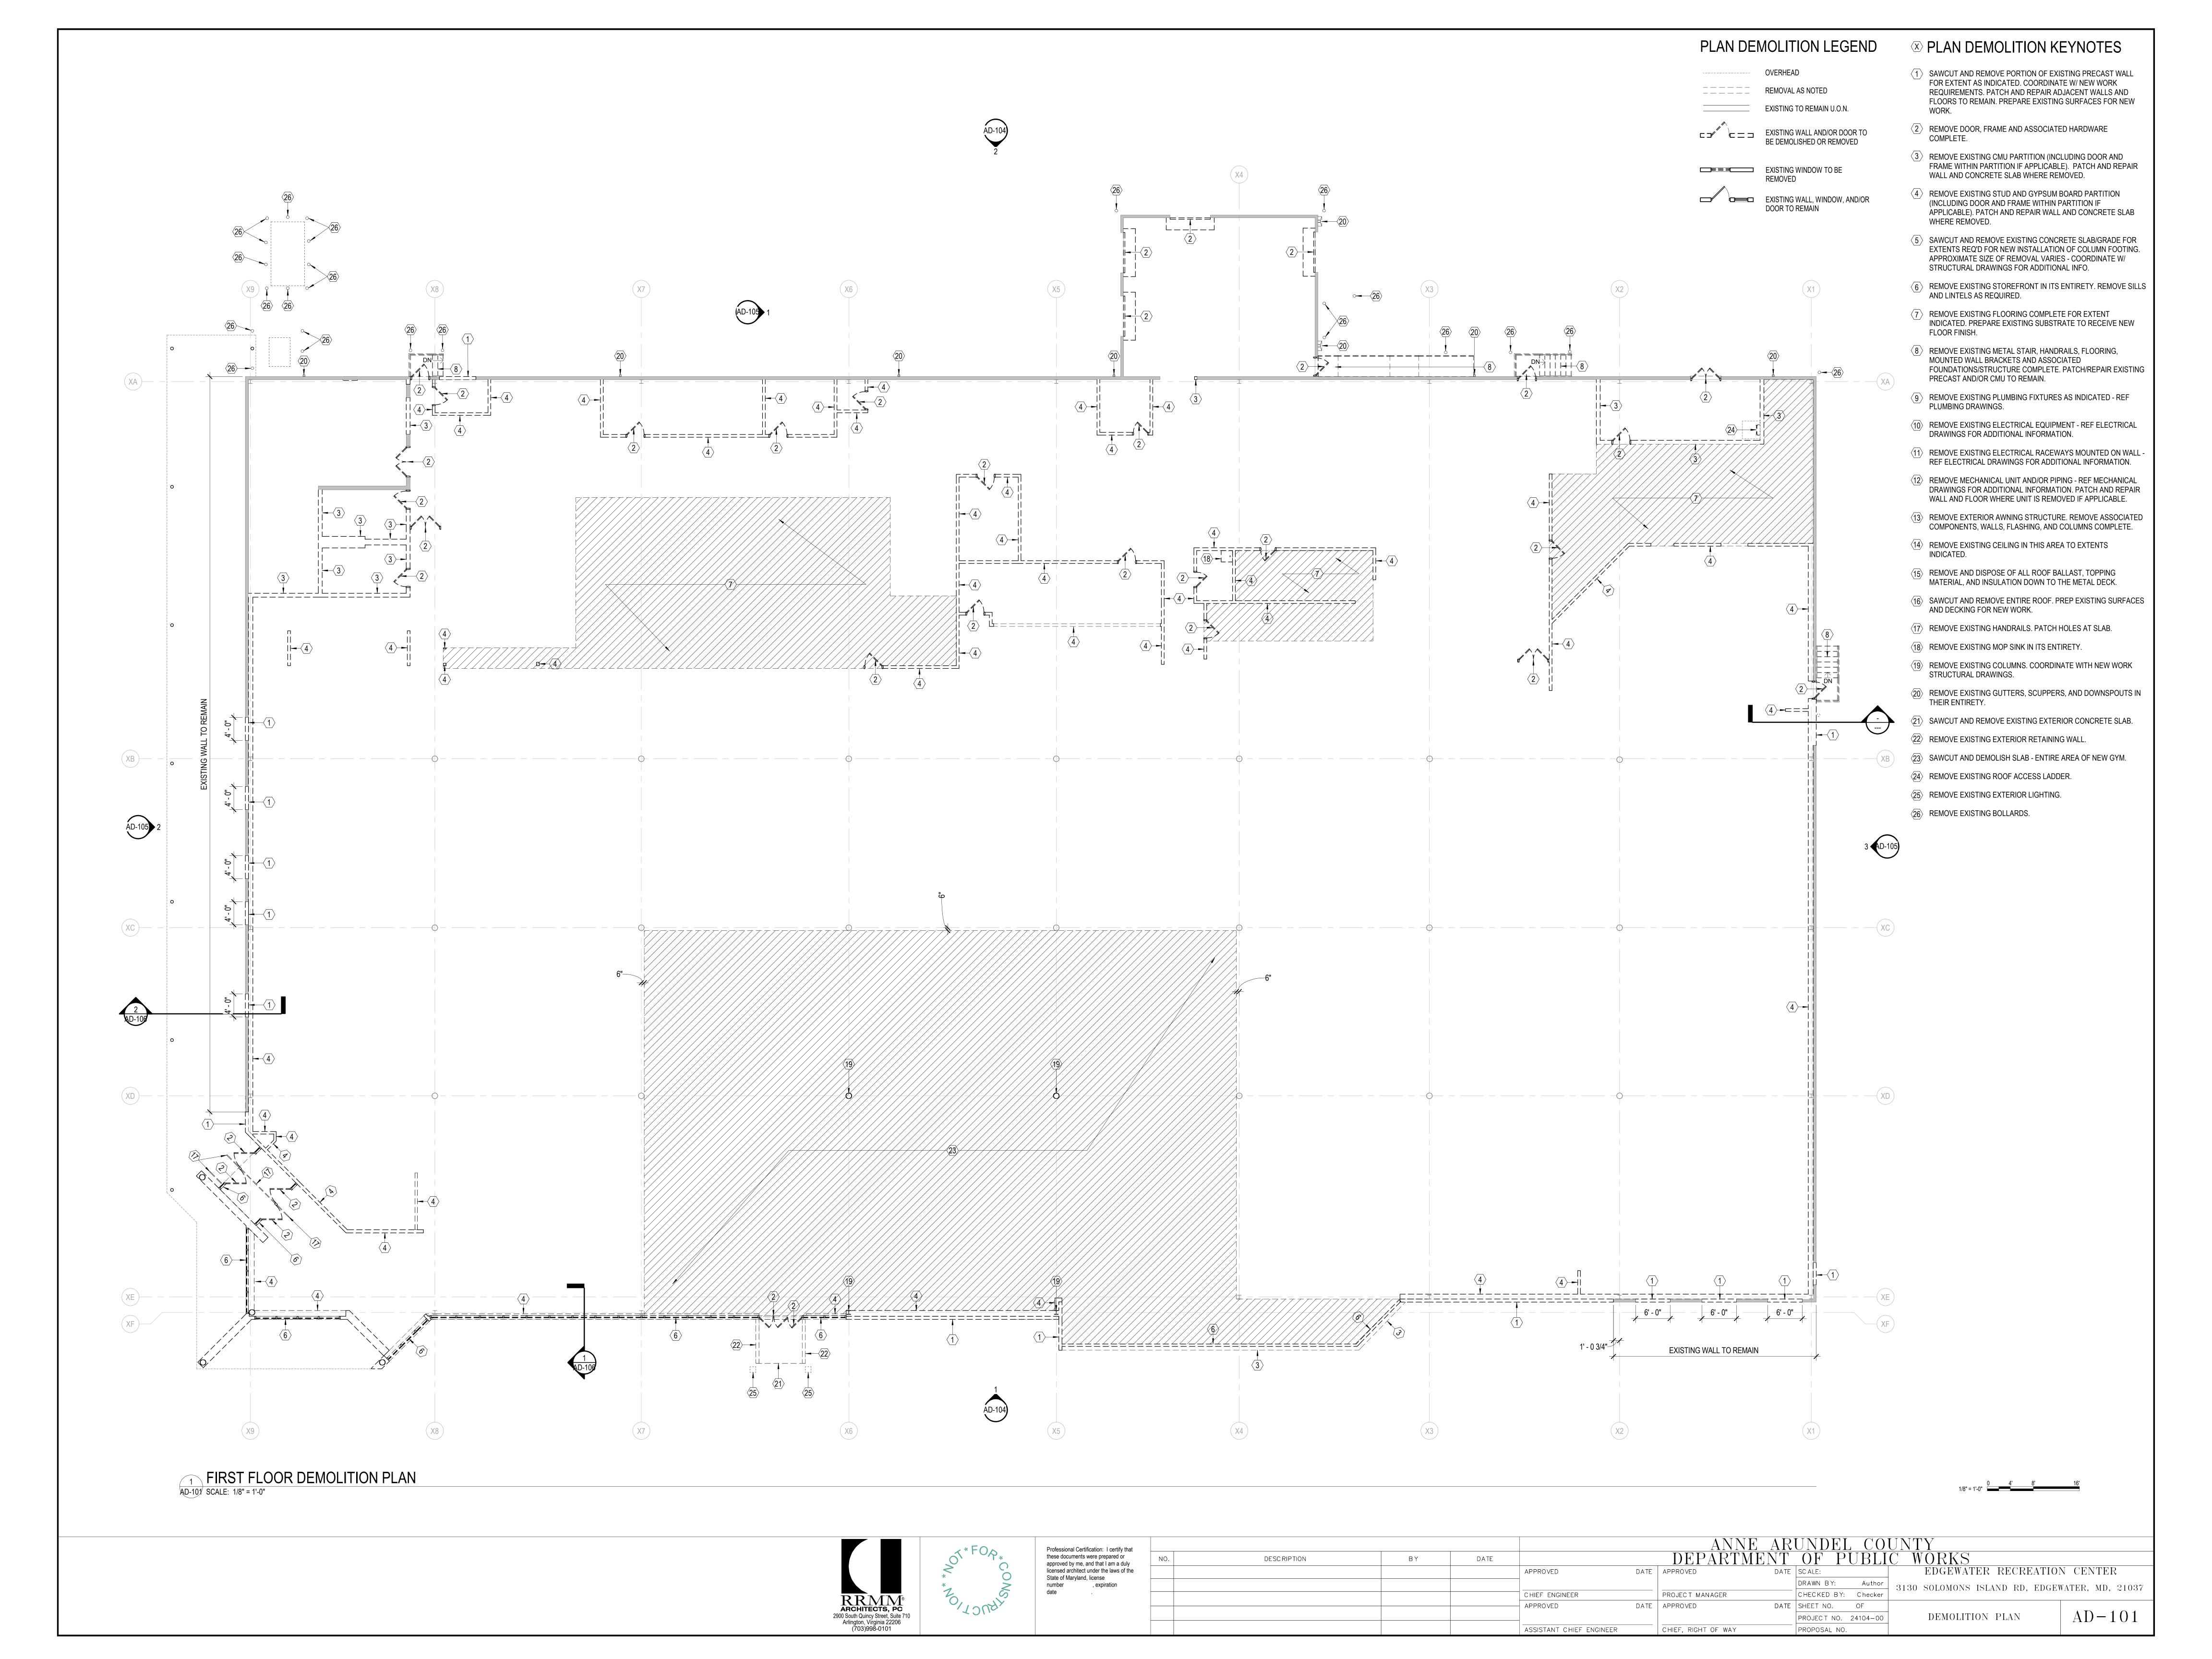

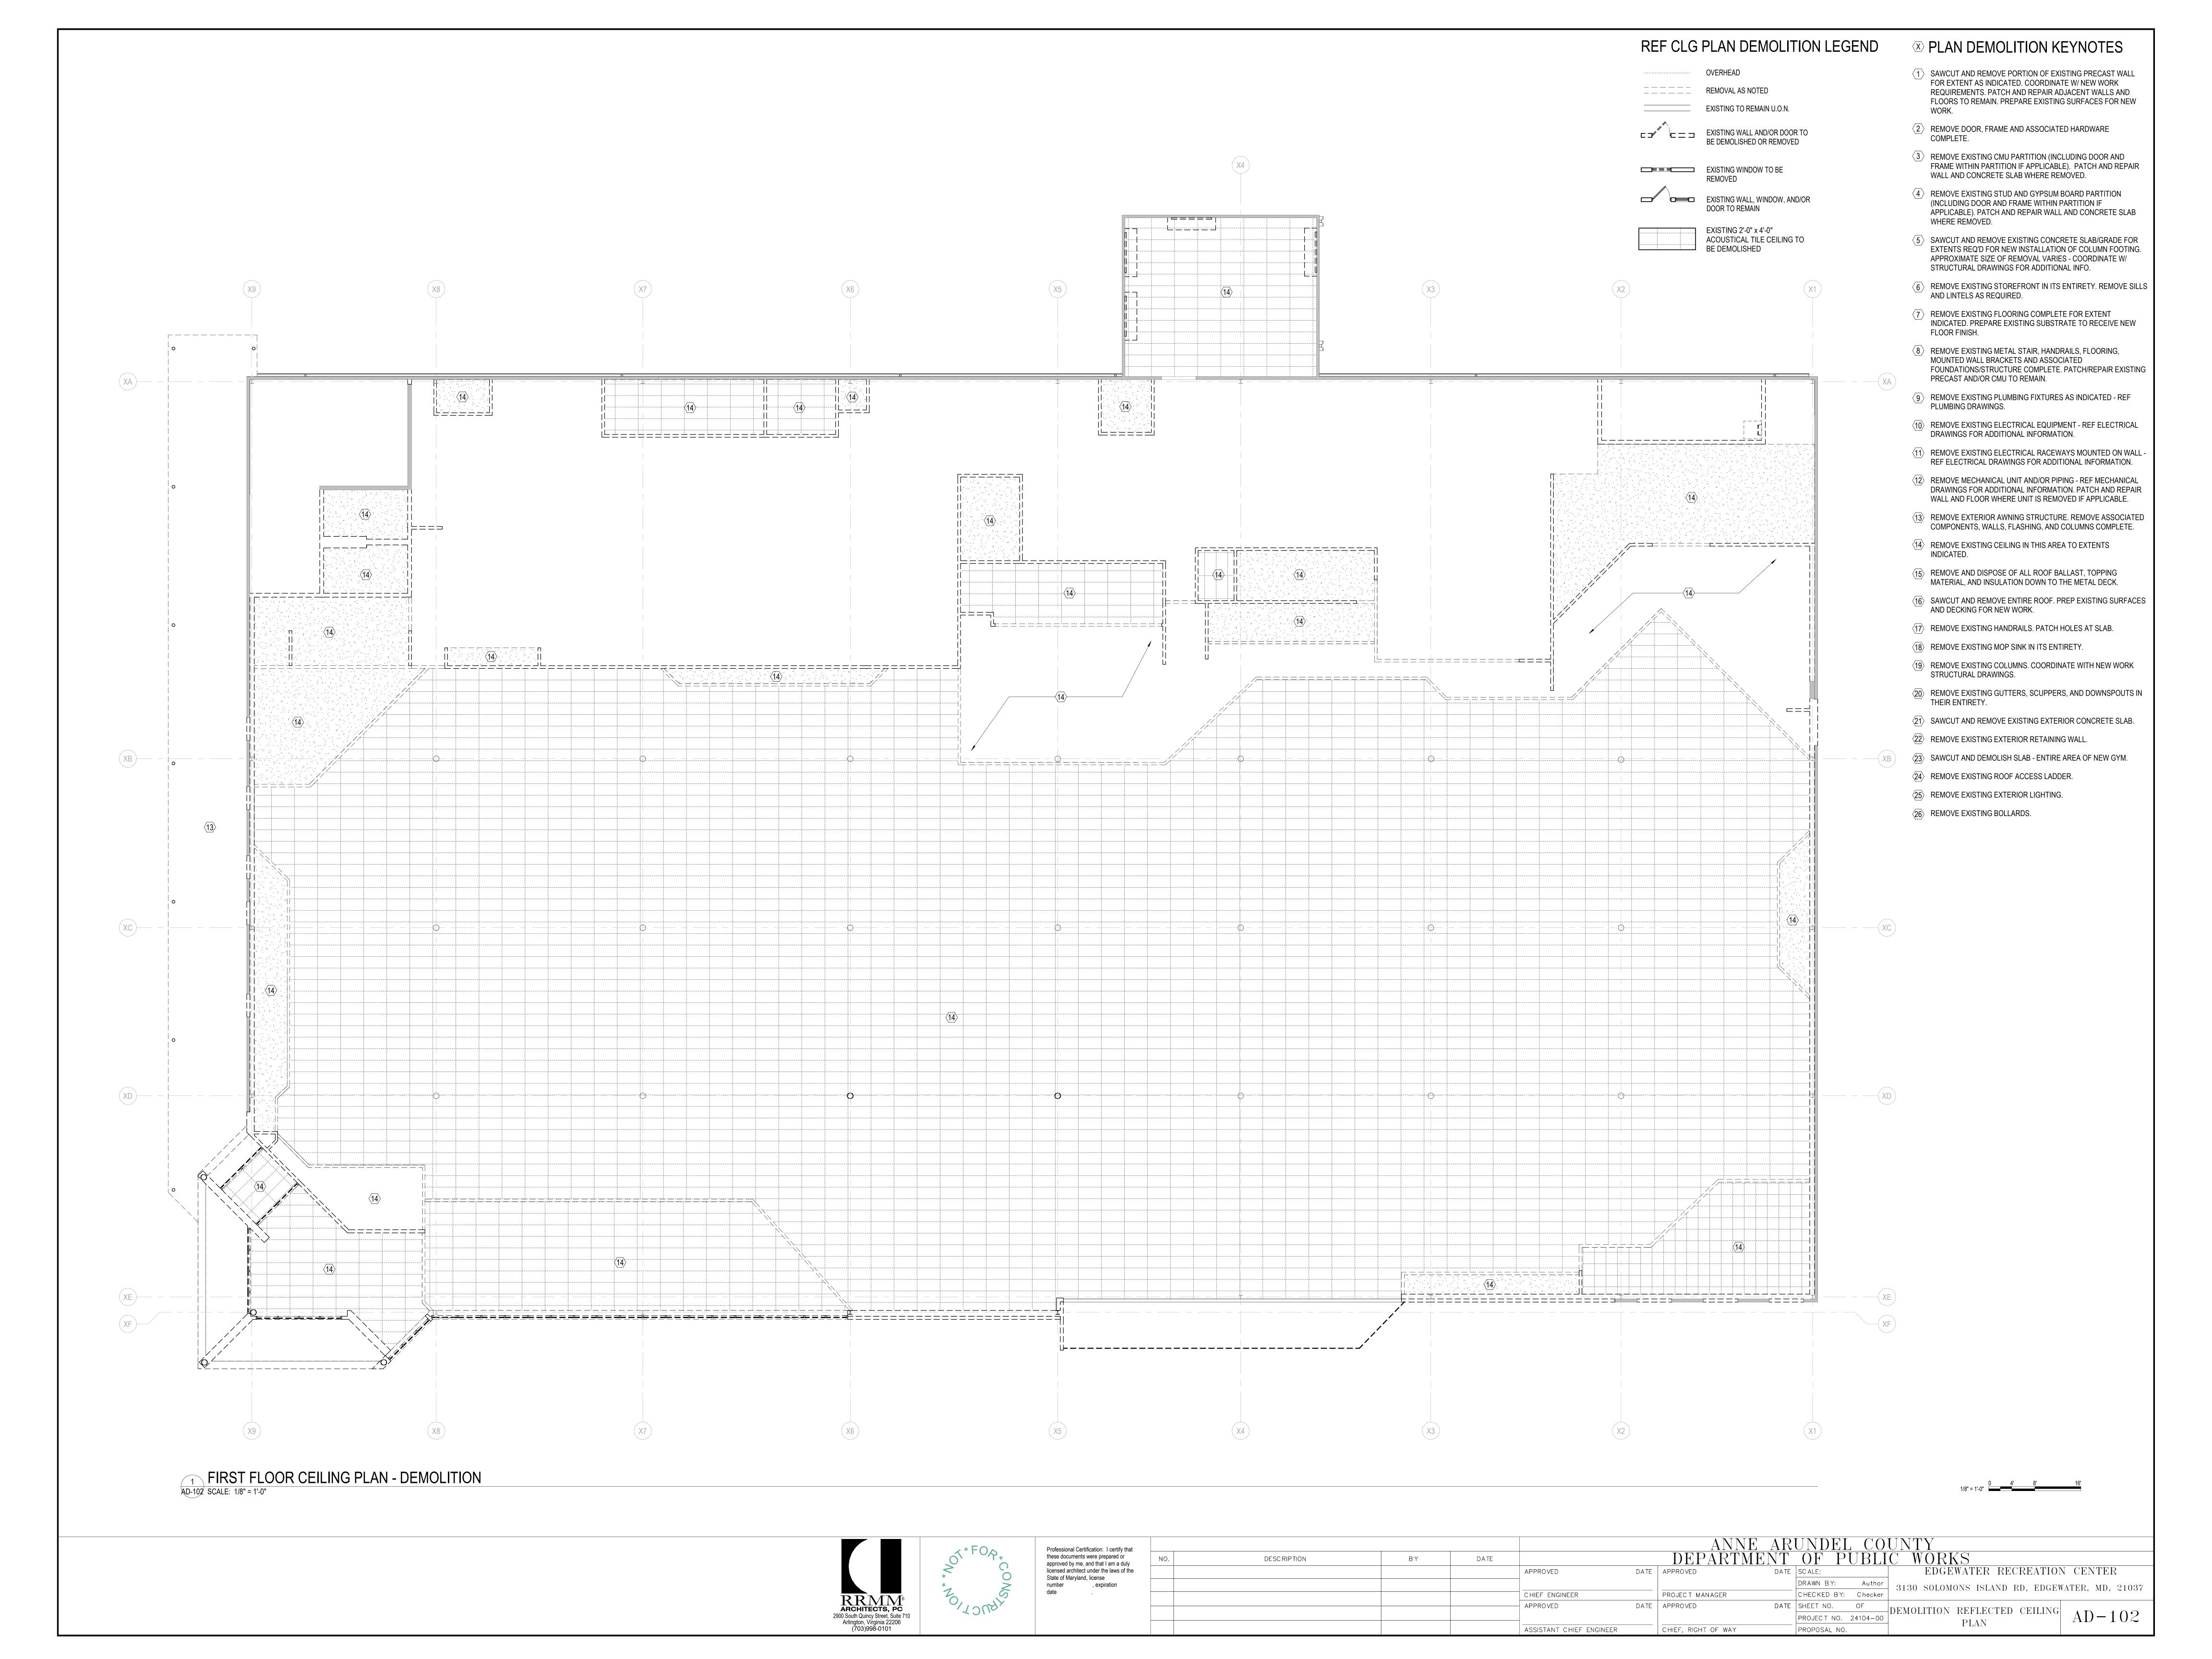

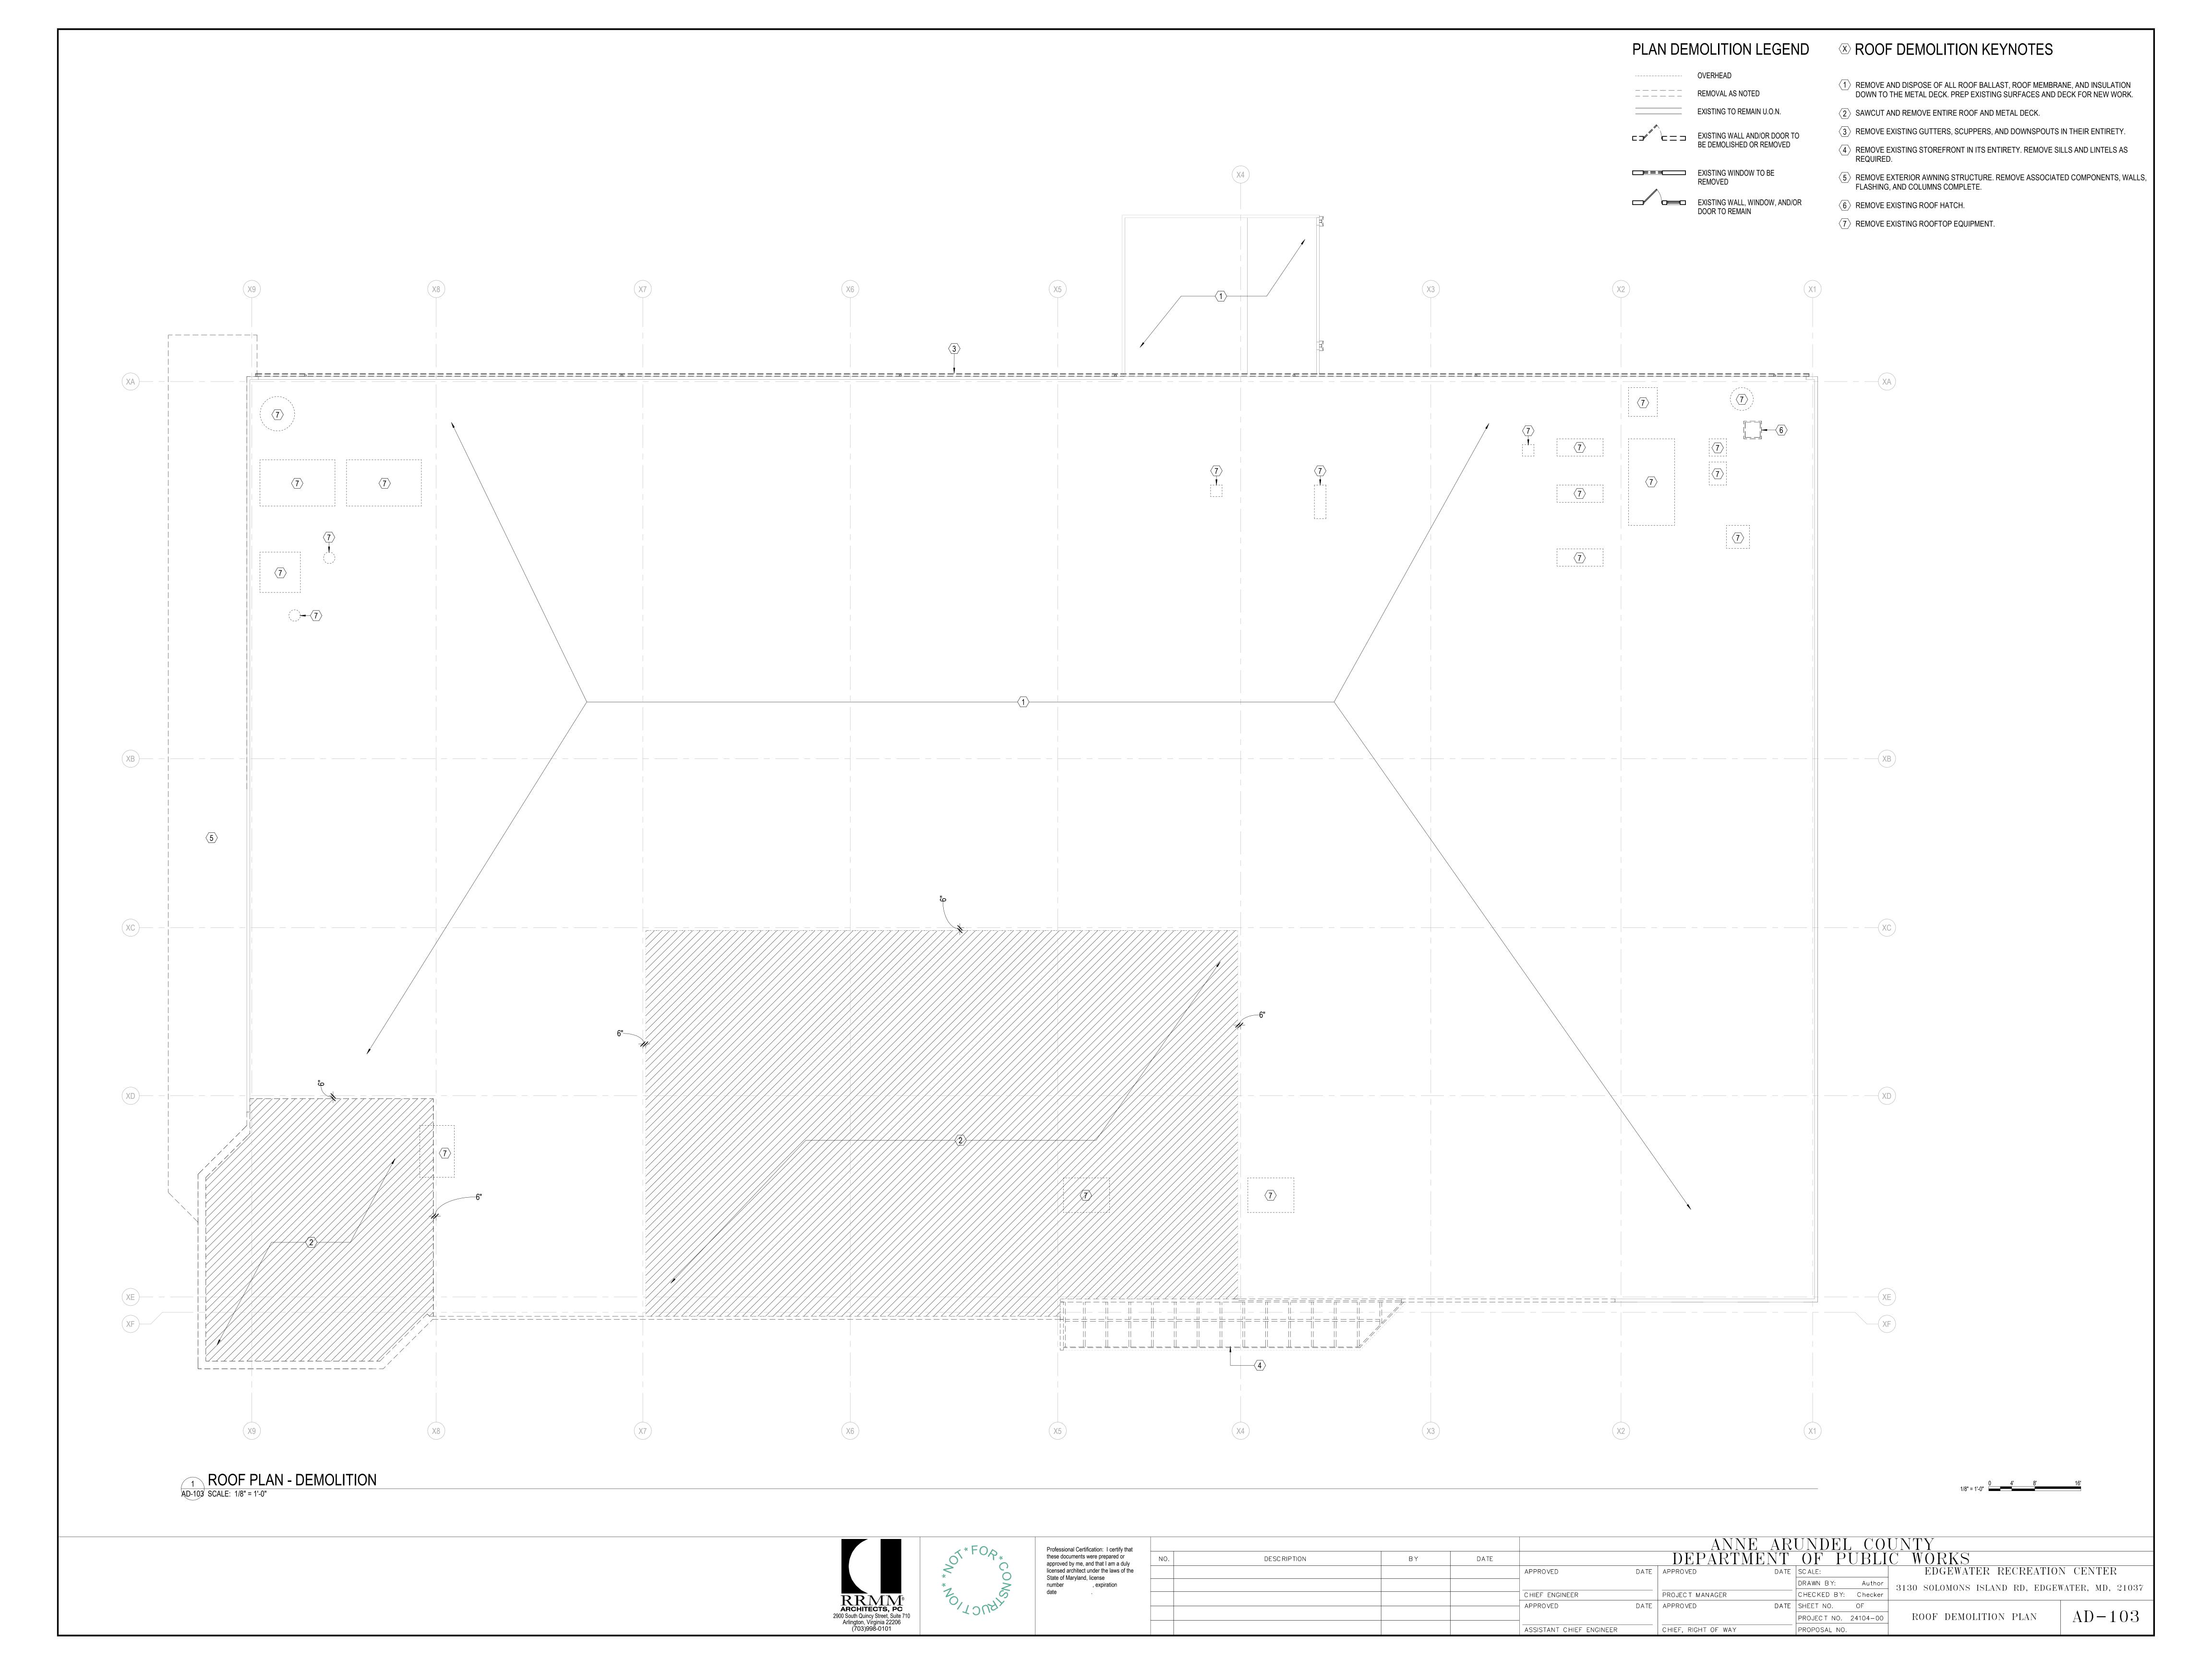

ELEVATION DEMOLITION LEGEND

REMOVAL AS NOTED

EXISTING TO REMAIN U.O.N.

ELEVATION DEMOLITION KEYNOTES

- SAWCUT AND REMOVE PORTION OF EXISTING PRECAST WALL FOR EXTENT AS INDICATED. COORDINATE W/ NEW WORK REQUIREMENTS. PATCH AND REPAIR ADJACENT WALLS AND FLOORS TO REMAIN. PREPARE EXISTING SURFACES FOR NEW WORK.
- 2 REMOVE DOOR, FRAME AND ASSOCIATED HARDWARE COMPLETE.
- REMOVE EXISTING CMU PARTITION (INCLUDING DOOR AND FRAME WITHIN PARTITION IF APPLICABLE). PATCH AND REPAIR WALL AND CONCRETE SLAB WHERE REMOVED.
- REMOVE EXISTING STUD AND GYPSUM BOARD PARTITION (INCLUDING DOOR AND FRAME WITHIN PARTITION IF APPLICABLE). PATCH AND REPAIR WALL AND CONCRETE SLAB WHERE REMOVED.
- 5 SAWCUT AND REMOVE EXISTING CONCRETE SLAB/GRADE FOR EXTENTS REQ'D FOR NEW INSTALLATION OF COLUMN FOOTING. APPROXIMATE SIZE OF REMOVAL VARIES COORDINATE W/ STRUCTURAL DRAWINGS FOR ADDITIONAL INFO.
- (6) REMOVE EXISTING STOREFRONT IN ITS ENTIRETY. REMOVE SILLS AND LINTELS AS REQUIRED.
- REMOVE EXISTING FLOORING COMPLETE FOR EXTENT INDICATED. PREPARE EXISTING SUBSTRATE TO RECEIVE NEW FLOOR FINISH.
- (8) REMOVE EXISTING METAL STAIR, HANDRAILS, FLOORING, MOUNTED WALL BRACKETS AND ASSOCIATED FOUNDATIONS/STRUCTURE COMPLETE. PATCH/REPAIR EXISTING PRECAST AND/OR CMU TO REMAIN.
- 9 REMOVE EXISTING PLUMBING FIXTURES AS INDICATED REF PLUMBING DRAWINGS.
- (10) REMOVE EXISTING ELECTRICAL EQUIPMENT REF ELECTRICAL DRAWINGS FOR ADDITIONAL INFORMATION.
- REMOVE EXISTING ELECTRICAL RACEWAYS MOUNTED ON WALL REF ELECTRICAL DRAWINGS FOR ADDITIONAL INFORMATION.
- REPAIR WALL AND FLOOR WHERE UNIT IS REMOVED IF APPLICABLE.


 (13) REMOVE EXTERIOR AWNING STRUCTURE. REMOVE ASSOCIATED COMPONENTS, WALLS, FLASHING, AND COLUMNS

(12) REMOVE MECHANICAL UNIT AND/OR PIPING - REF MECHANICAL DRAWINGS FOR ADDITIONAL INFORMATION. PATCH AND


COMPLETE.

14 REMOVE EXISTING CEILING IN THIS AREA TO EXTENTS INDICATED.

- REMOVE AND DISPOSE OF ALL ROOF BALLAST, TOPPING MATERIAL, AND INSULATION DOWN TO THE METAL DECK.
- (16) SAWCUT AND REMOVE ENTIRE ROOF. PREP EXISTING SURFACES AND DECKING FOR NEW WORK.
- (17) REMOVE EXISTING HANDRAILS. PATCH HOLES AT SLAB.
- (18) REMOVE EXISTING MOP SINK IN ITS ENTIRETY.
- (19) REMOVE EXISTING COLUMNS. COORDINATE WITH NEW WORK STRUCTURAL DRAWINGS.
- (20) REMOVE EXISTING GUTTERS, SCUPPERS, AND DOWNSPOUTS IN THEIR ENTIRETY.
- (21) SAWCUT AND REMOVE EXISTING EXTERIOR CONCRETE SLAB.
- 22 REMOVE EXISTING EXTERIOR RETAINING WALL.
- 23 REMOVE EXISTING EXTERIOR HORN.
- (24) REMOVE EXISTING OVERHEAD DOOR BUMPERS.
- 25 REMOVE EXISTING EXTERIOR CANOPY.
- 26 EXISTING EXTERIOR LIGHT TO BE REPLACED.
- 27 REMOVE EXISTING BOLLARDS.
- REMOVE EQUIPMENT FOR EXTENT AS INDICATED. COORDINATE WITH NEW WORK REQUIREMENTS. PATCH AND REPAIR PRECAST WALLS.
- (29) REMOVE EXTERIOR SIGNAGE.
- 30 REMOVE DOWNSPOUT GUARDS.
- (31) REMOVE SECURITY CAMERA.
- (32) REMOVE FIRE HOSE CABINET. PATCH AND REPAIR PRECAST WALL.
- (33) REMOVE EXISITNG FUEL TANK.
- REMOVE AND REPLACE EXISTING TRANSFORMER.
- 35 REMOVE EXISTING LOUVER.
- (36) REMOVE EXISTING FIRE DEPARTMENT CONNECTION EQUIPMENT.

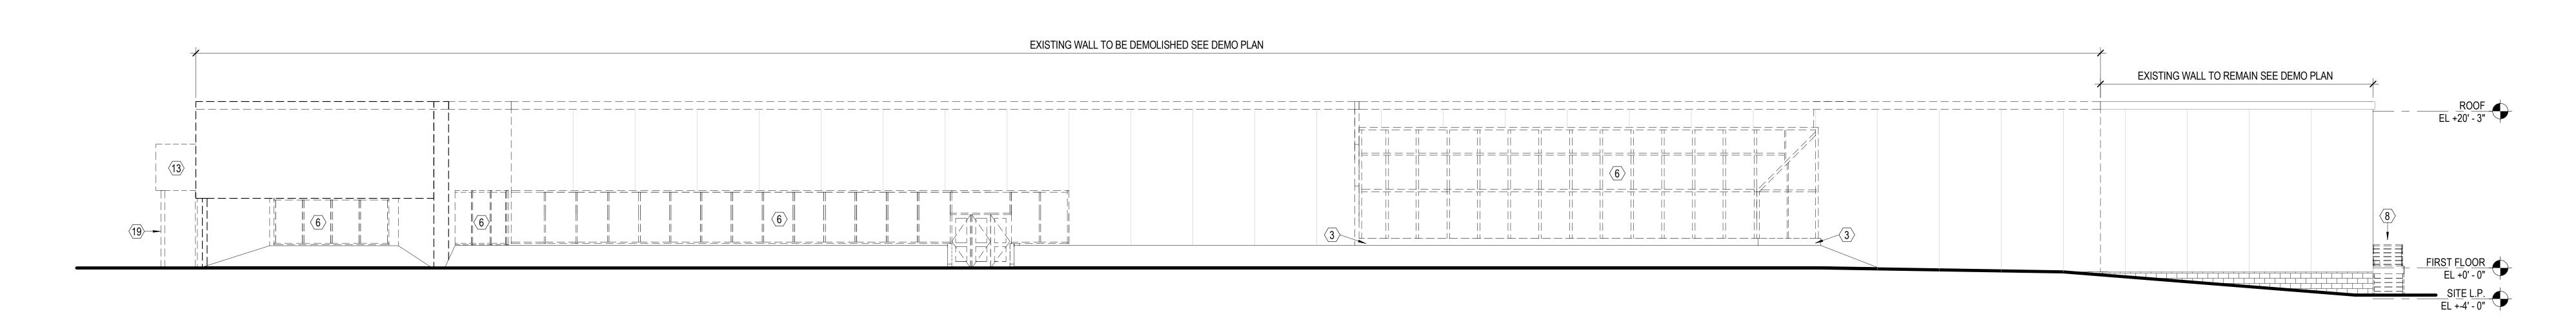

NORTH ELEVATION - DEMOLITION

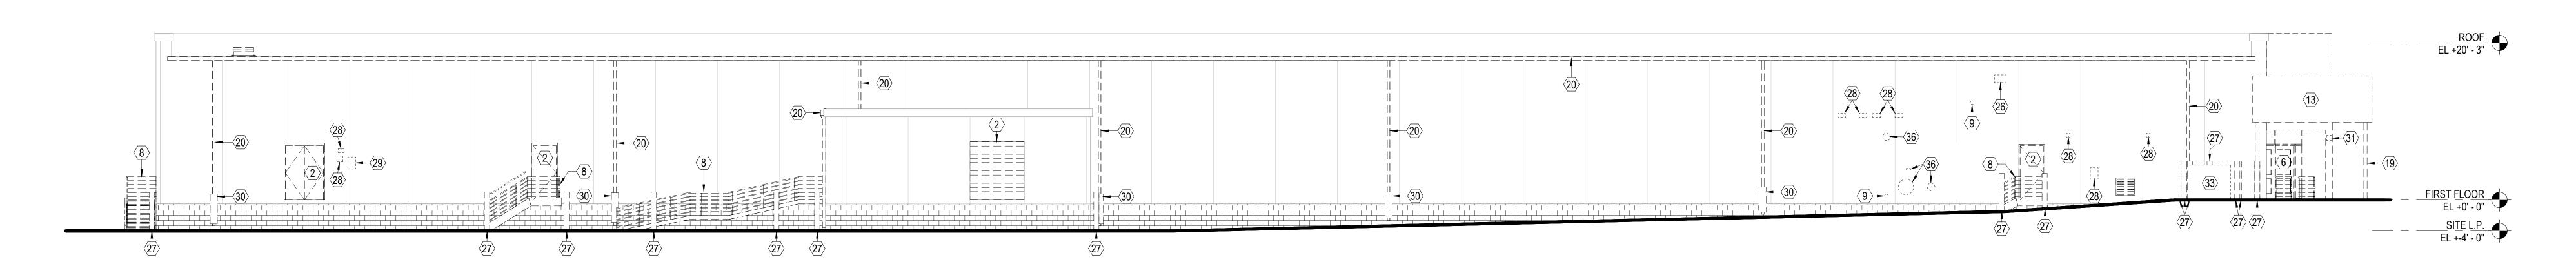


SOUTH ELEVATION - DEMOLITION

AD-104 SCALE: 1/8" = 1'-0"


0 4' 8' 16'






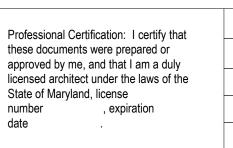


ANNE ARUNDEL COUNTY NO. DESCRIPTION BY DATE APPROVED DATE DEPARTMENT OF PUBLIC WORKS APPROVED DATE DEPARTMENT OF PUBLIC WORKS CHIEF ENGINEER PROJECT MANAGER CHECKED BY: Checker APPROVED DATE SCALE: DRAWN BY: Author CHECKED BY: Checker CHECKED BY: Checker APPROVED DATE SHEET NO. OF PROJECT NO. 24104-00 ASSISTANT CHIEF ENGINEER ASSISTANT CHIEF ENGINEER CHIEF, RIGHT OF WAY PROPOSAL NO. ANNE ARUNDEL COUNTY BOUNTS EDGEWATER RECREATION CENTY AUTHOR NORTH & SOUTH DEMOLITION PROPOSAL NO. ADDED ADDED ADDED ADDED ASSISTANT CHIEF ENGINEER ANNE ARUNDEL COUNTY DEMONSOR FROJECT NO. 24104-00 PROPOSAL NO. ADDED												
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PROJECT NO. 24104-00 ELEVATIONS					APPROVED	DATE	APPROVED	DATE	SHEET NO.	OF	NORTH & SOUTH DEMOLITION	
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					ASSISTANT CHIEF ENGINEER		CHIEF, RIGHT OF WAY		PROPOSAL NO).	ELEVATIONS	

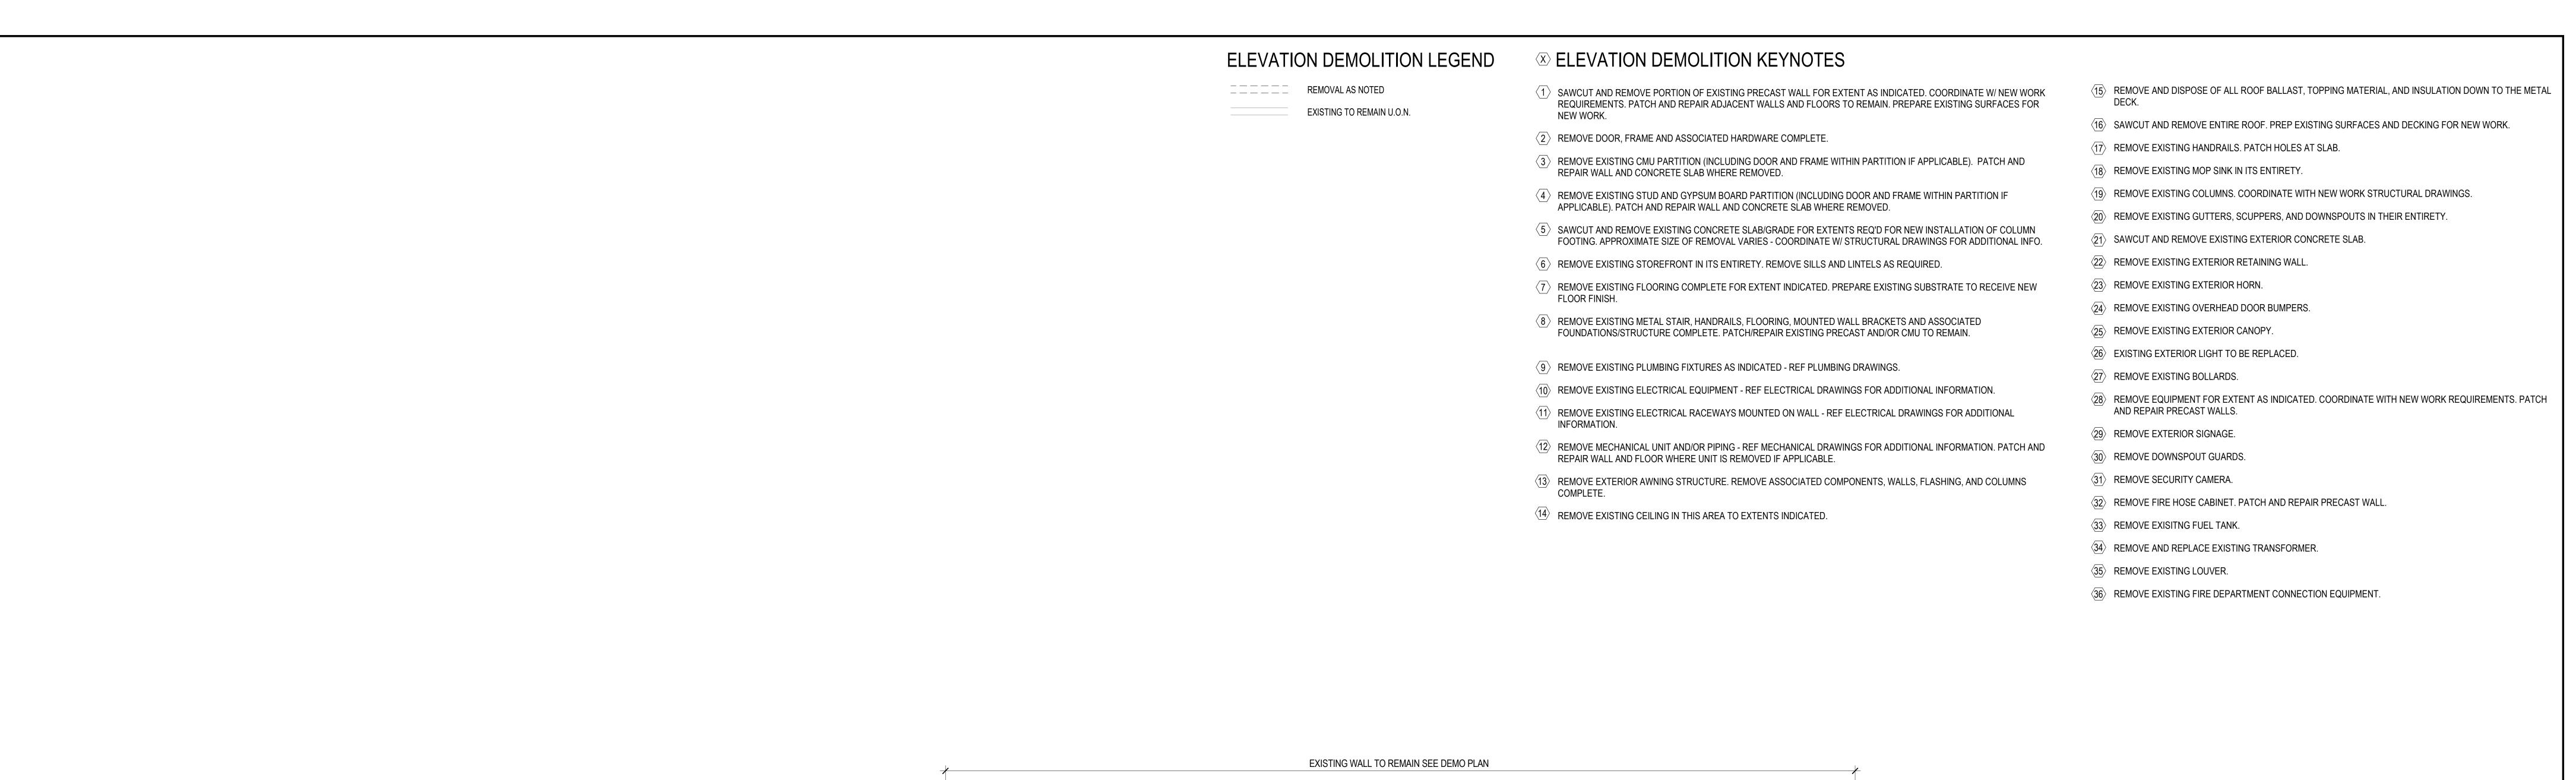


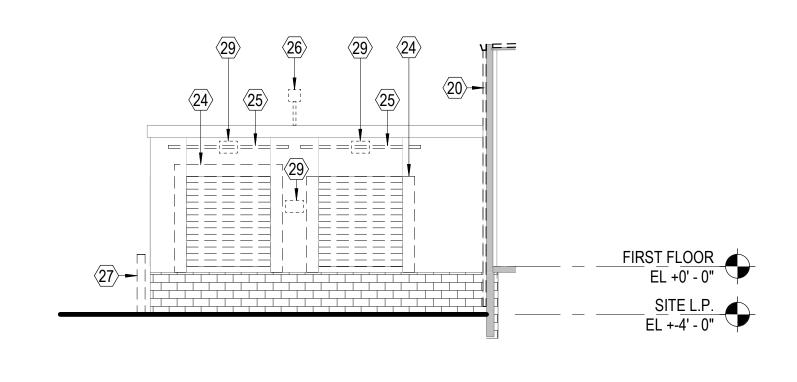

EAST ELEVATION DEMOLITION - LOADING DOCK
AD-105 SCALE: 1/8" = 1'-0"

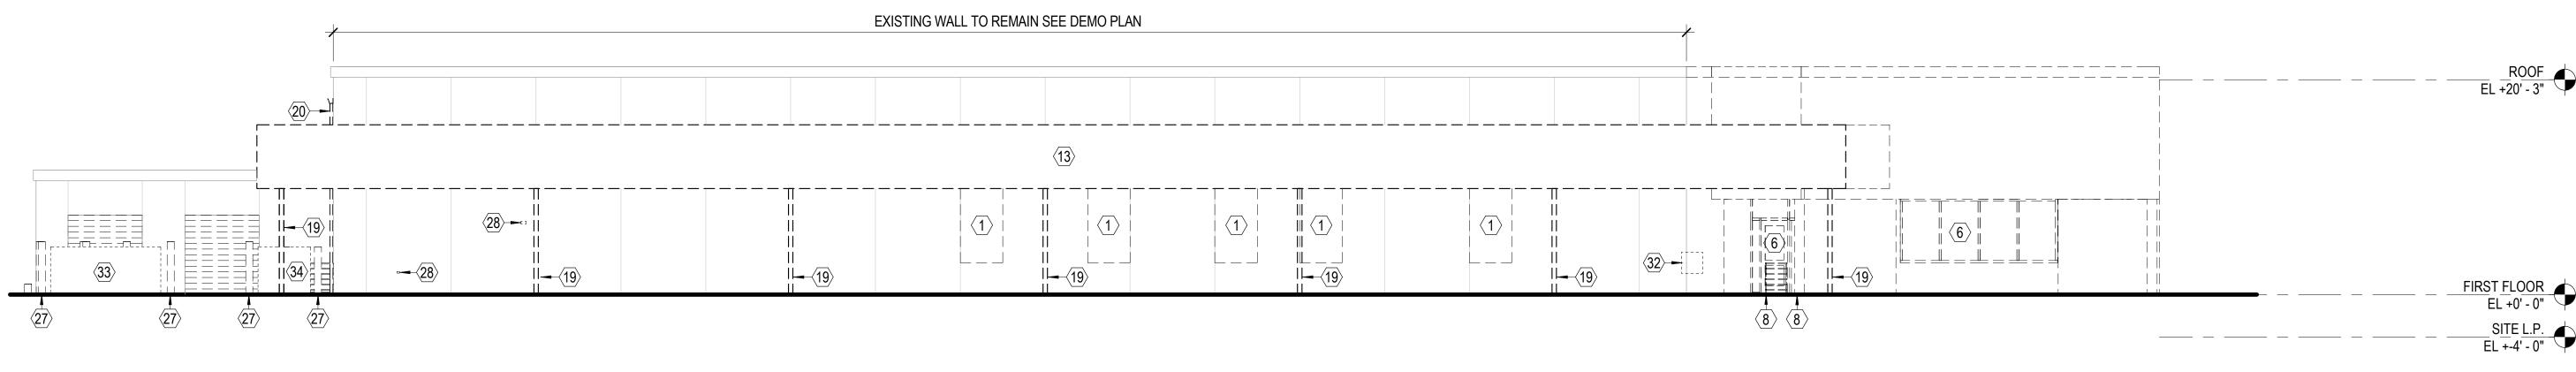

2 EAST ELEVATION - DEMOLITION

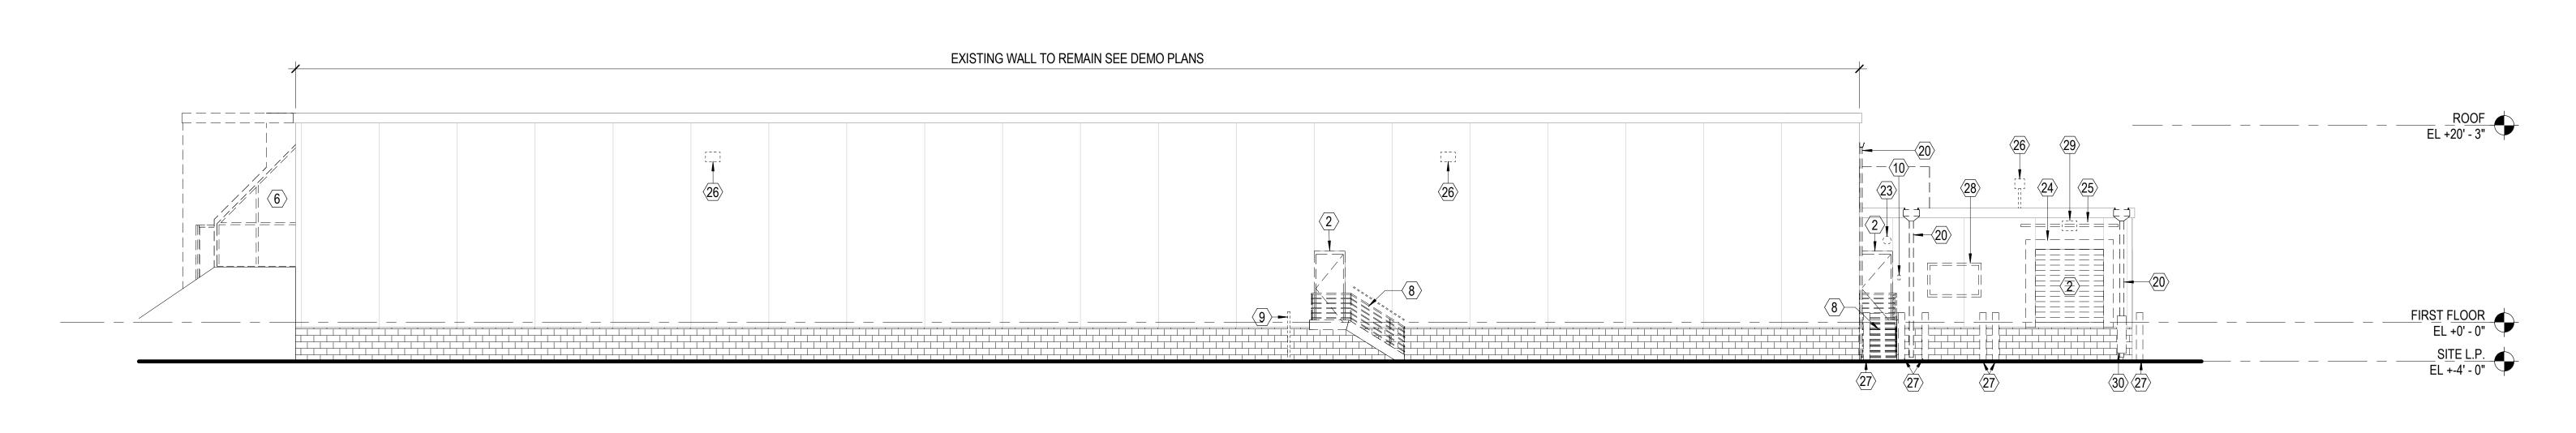


WEST ELEVATION - DEMOLITION


AD-105 SCALE: 1/8" = 1'-0"

1/8" = 1'-0"






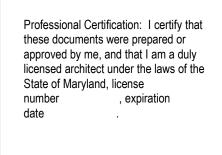

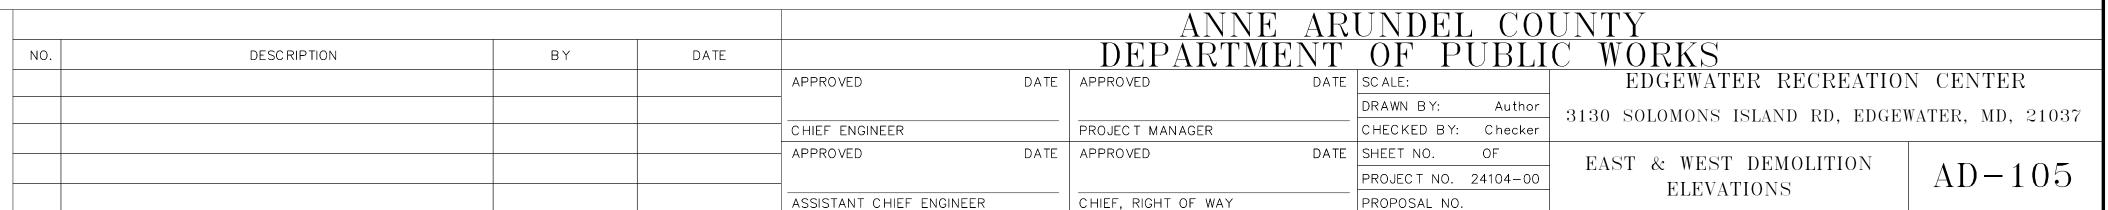


REMOVAL AS NOTED

EXISTING TO REMAIN U.O.N.

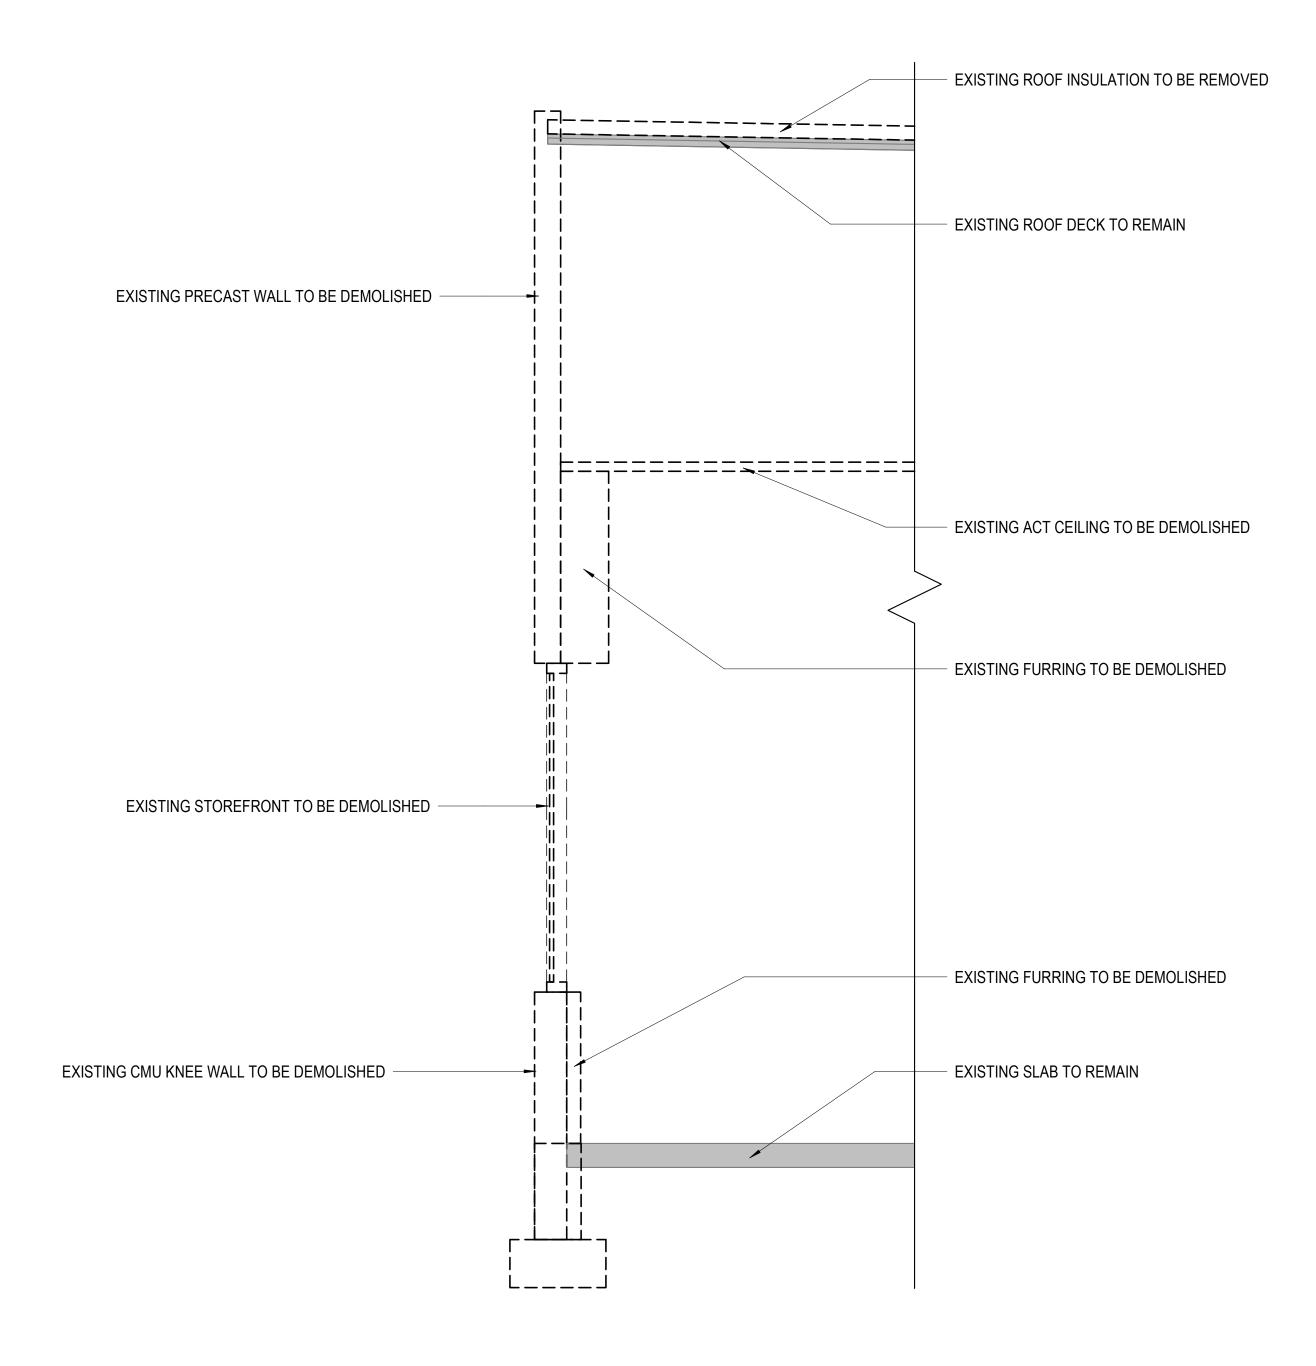




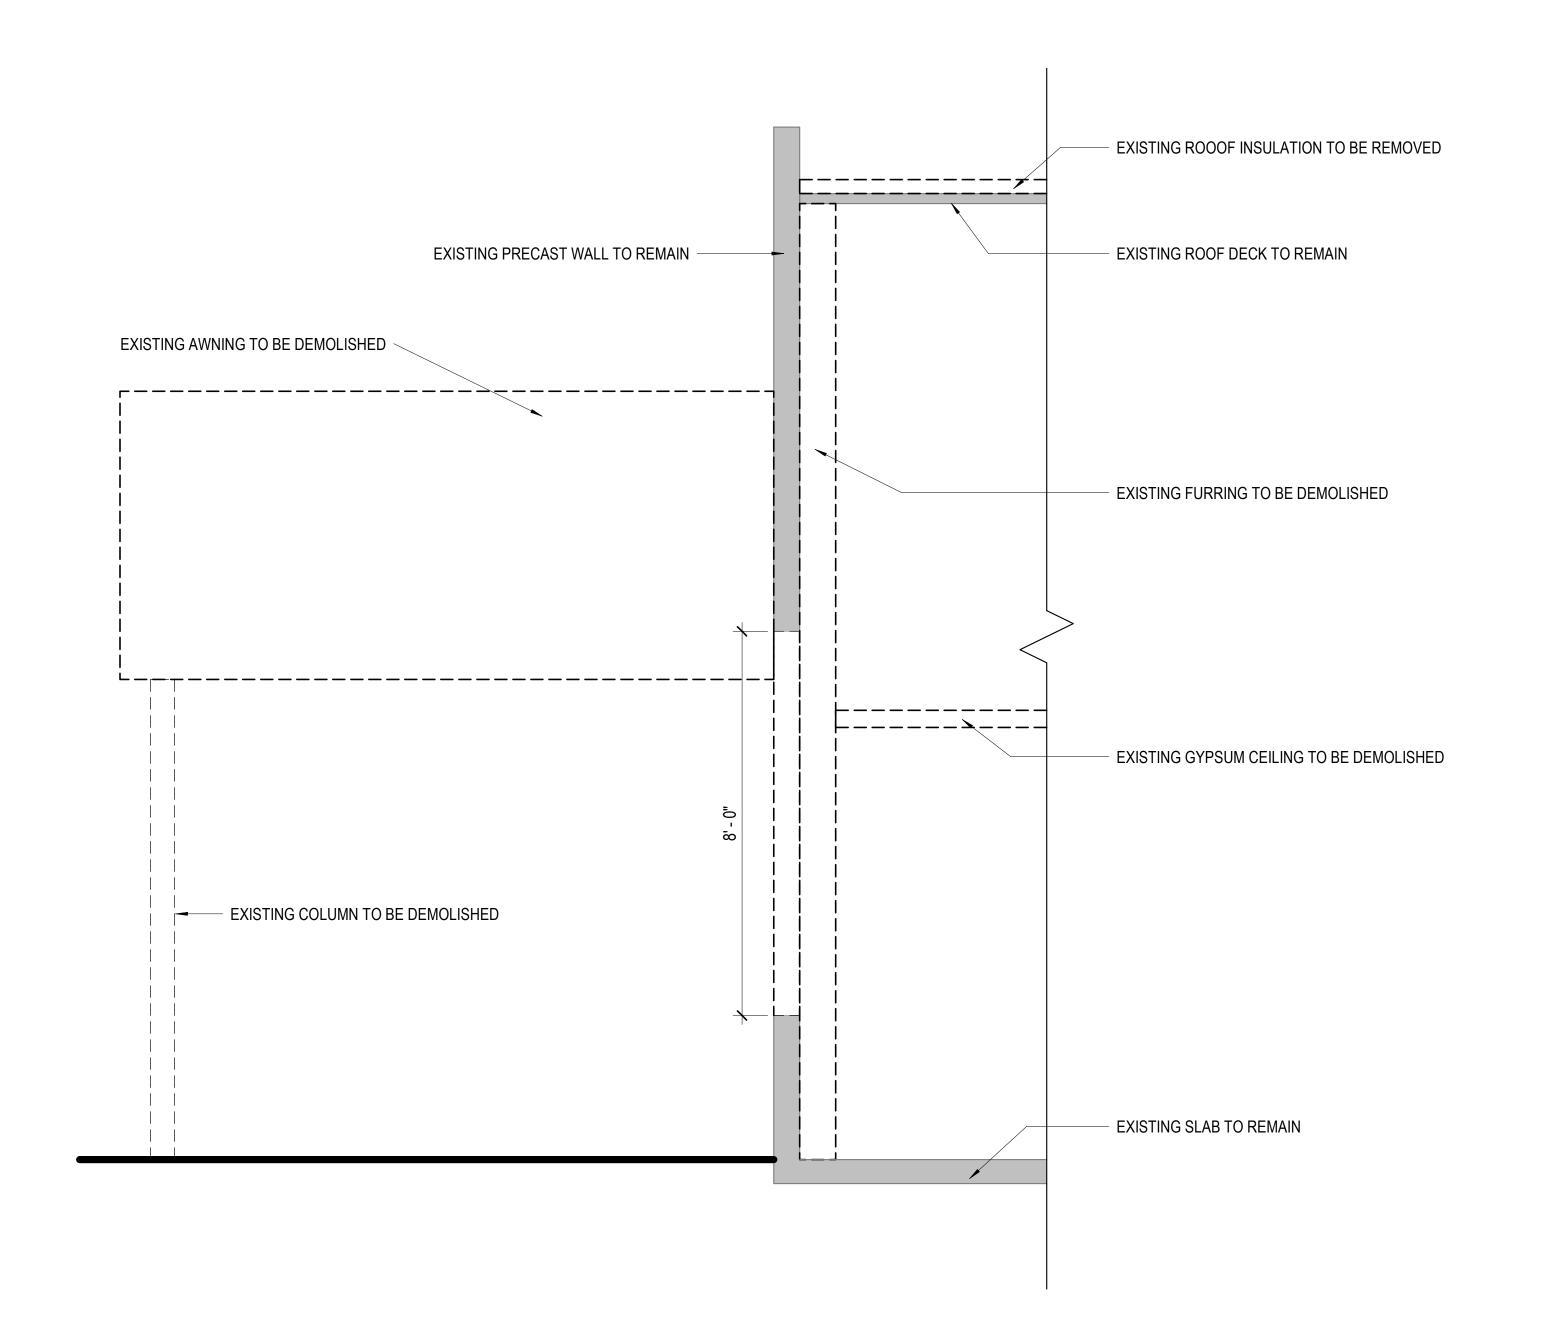

DEMOLITION SECTION - EAST WALL





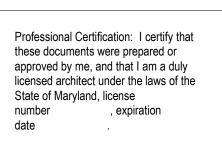

			ARI	UNDEL	CO	UNTY				
NO.	DESC RIPTION	ВҮ	DATE			DEPARTMEN	IT	OF PU	<u>UBLI</u>	C WORKS
				APPROVED	DATE	APPROVED	DATE	SC ALE:		EDGEWATER RECREATION CENTER
								DRAWN BY:	Author	3130 SOLOMONS ISLAND RD, EDGEWATER, MD, 21037
				CHIEF ENGINEER		PROJECT MANAGER		CHECKED BY:	Checker	SISO SOLOMONS ISLAND ND, EDGEWATER, MD, 21051
				- APPROVED	DATE	APPROVED	DATE	SHEET NO.	OF	
								PROJECT NO. :	24104-00	demolition wall sections $AD-106$
				ASSISTANT CHIEF ENGINEER		CHIEF, RIGHT OF WAY		PROPOSAL NO.		









EXTERIOR VIEW #1

EXTERIOR VIEW #2

EXTERIOR VIEW #3

EXTERIOR VIEW #4




EXTERIOR VIEW #5







EXTERIOR VIEW #7

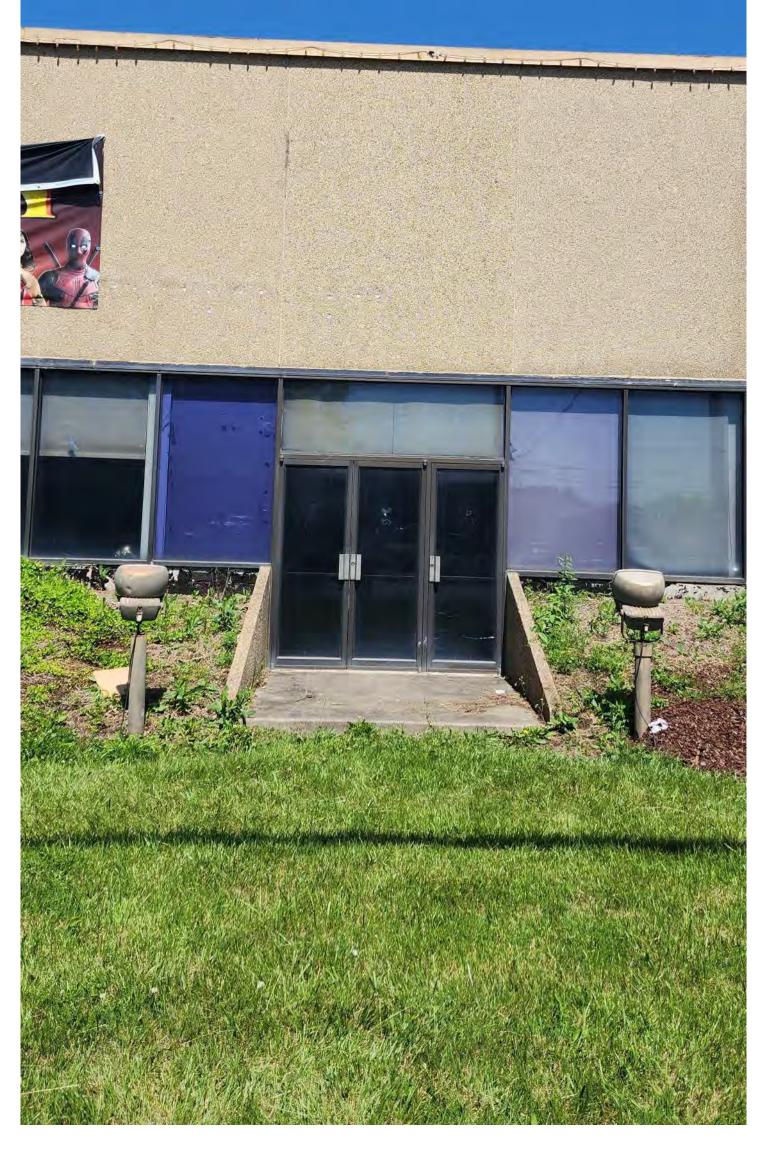



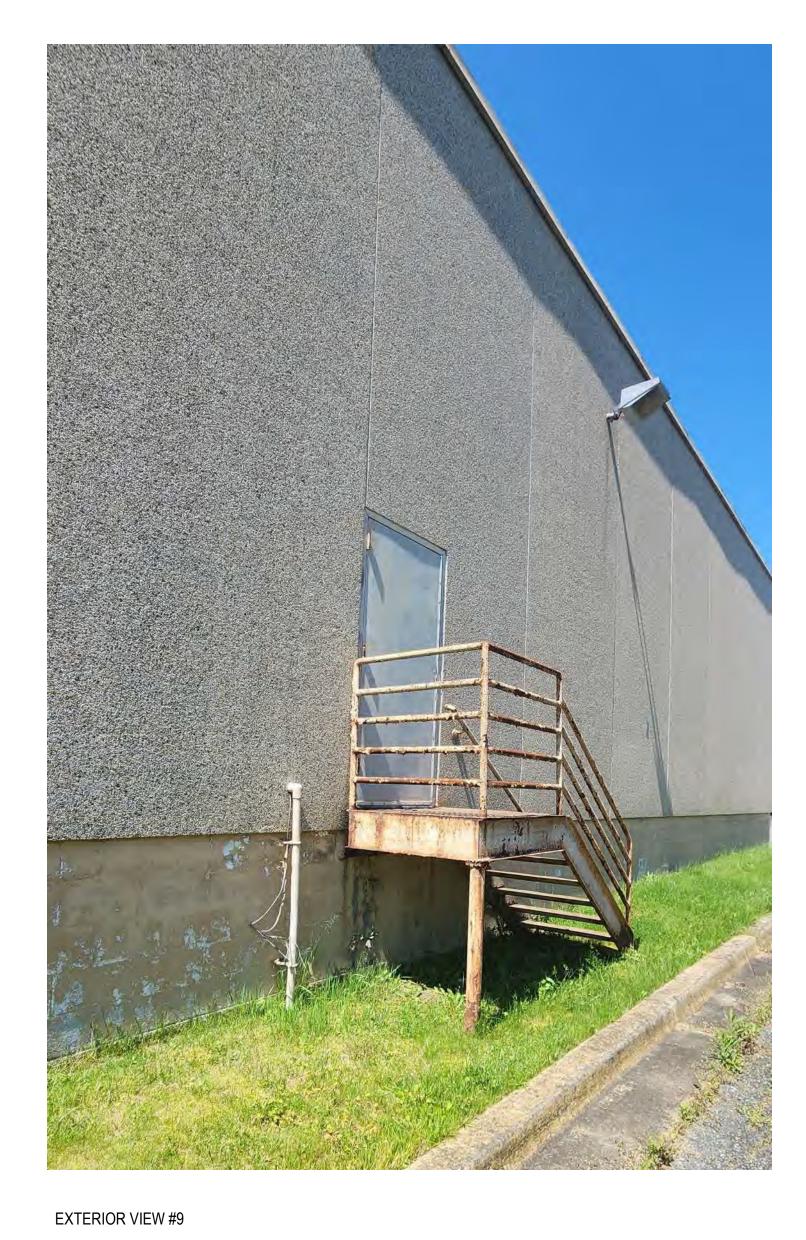

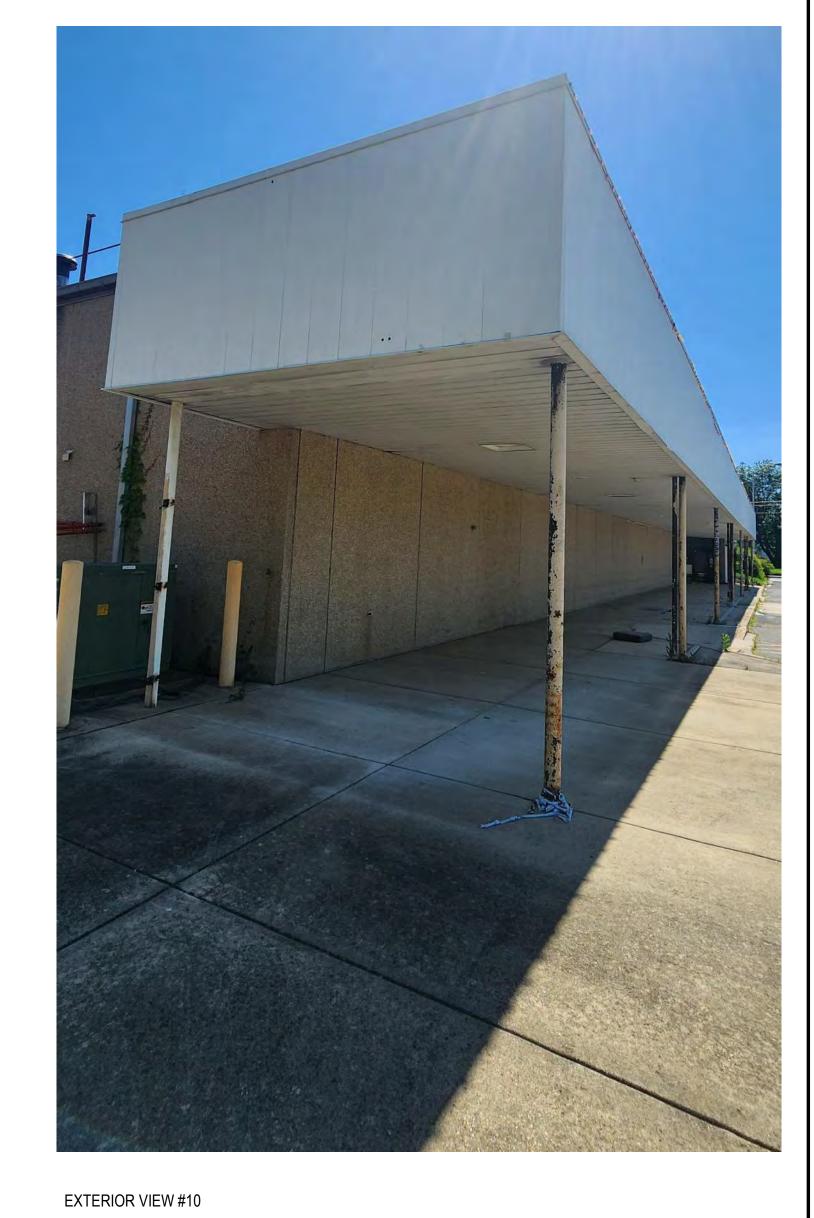


EXTERIOR VIEW #6









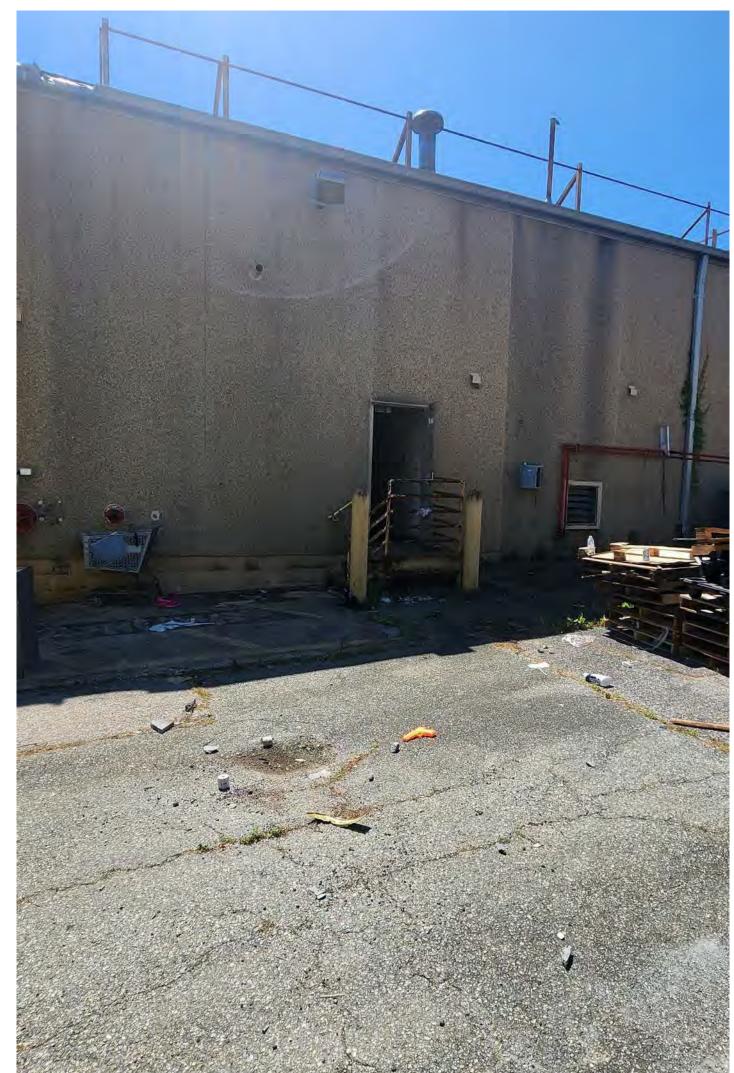



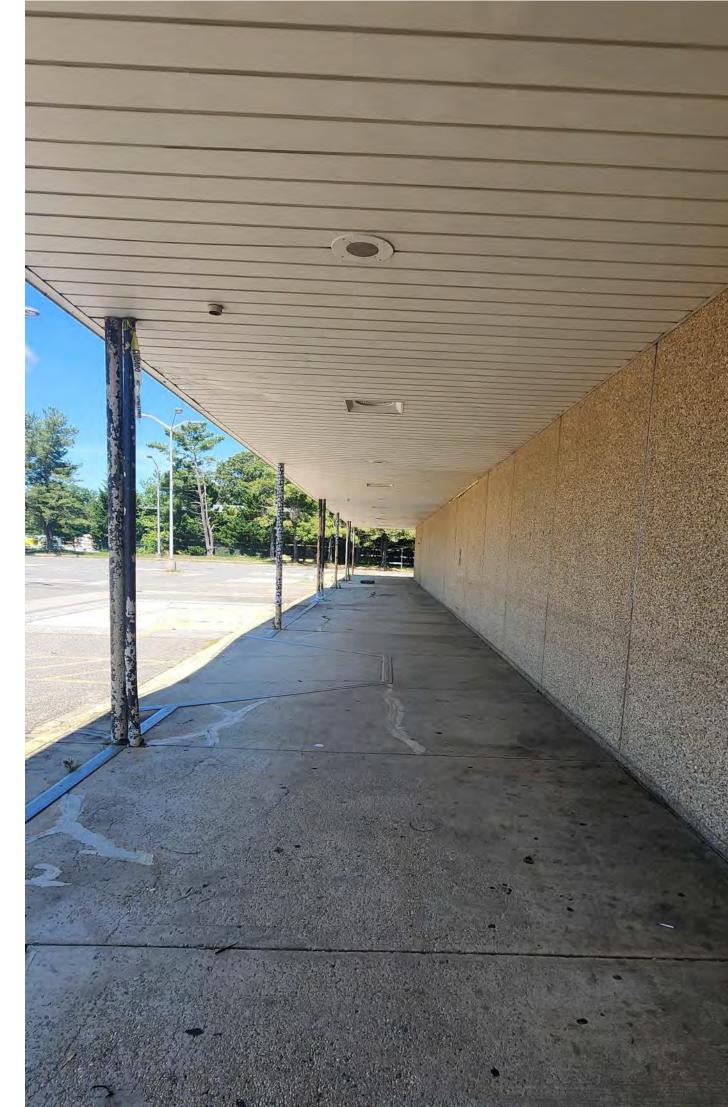

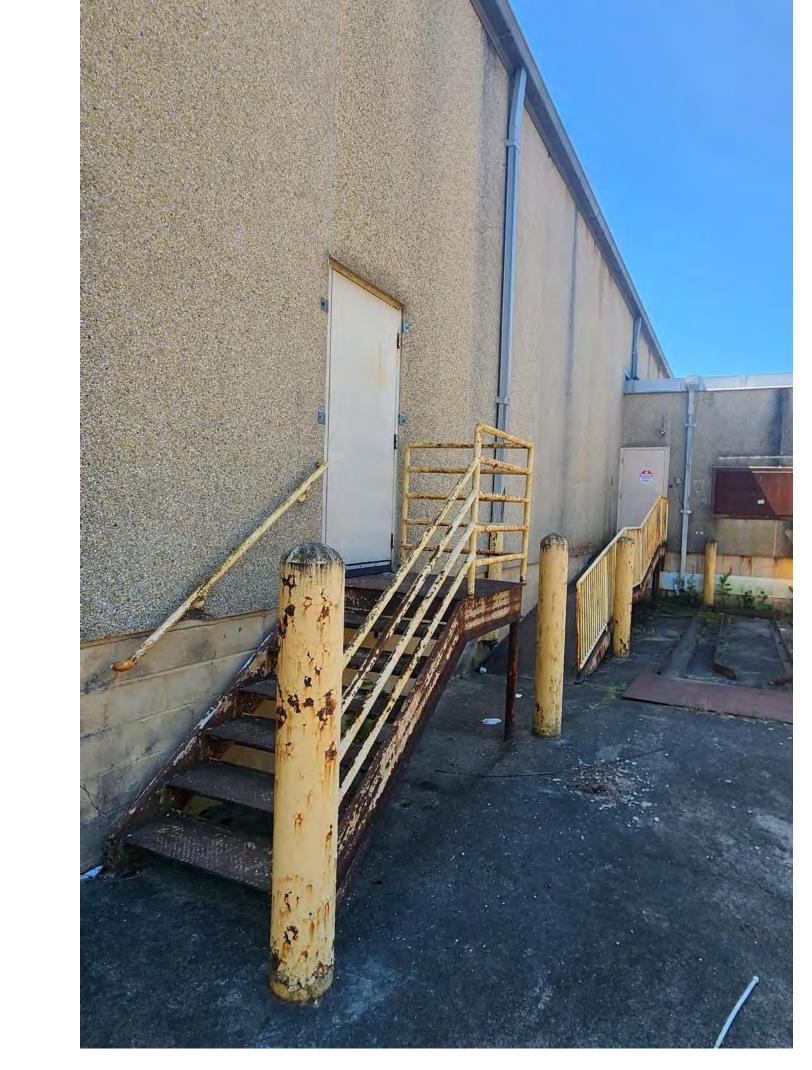



EXTERIOR VIEW #13

EXTERIOR VIEW #14

EXTERIOR VIEW #15


EXTERIOR VIEW #16





these docume approved by i	Certification: I certify ents were prepared of me, and that I am a d itect under the laws of land, license , expiration


.4						ANNE A	\overline{RI}	UNDEL CO	UNTY
ıı	NO.	DESCRIPTION BY	DATE			DEPARTMEN		OF PUBL	IC WORKS
е				APPROVED C	ATE	APPROVED D	ATE	SC ALE:	EDGEWATER RECREATION CENTER
								DRAWN BY: Author	3130 SOLOMONS ISLAND RD, EDGEWATER, MD, 21037
				CHIEF ENGINEER		PROJECT MANAGER		CHECKED BY: Checker	STOO SOLOMONS ISLAND, EDGENNIEN, MB, 21001
				— APPROVED D	ATE	APPROVED D	ATE	SHEET NO. OF	
								PROJECT NO. 24104-00	\top existing photos – exterior $\parallel \mathrm{AD-107}$
				ASSISTANT CHIEF ENGINEER		CHIEF, RIGHT OF WAY		PROPOSAL NO.	

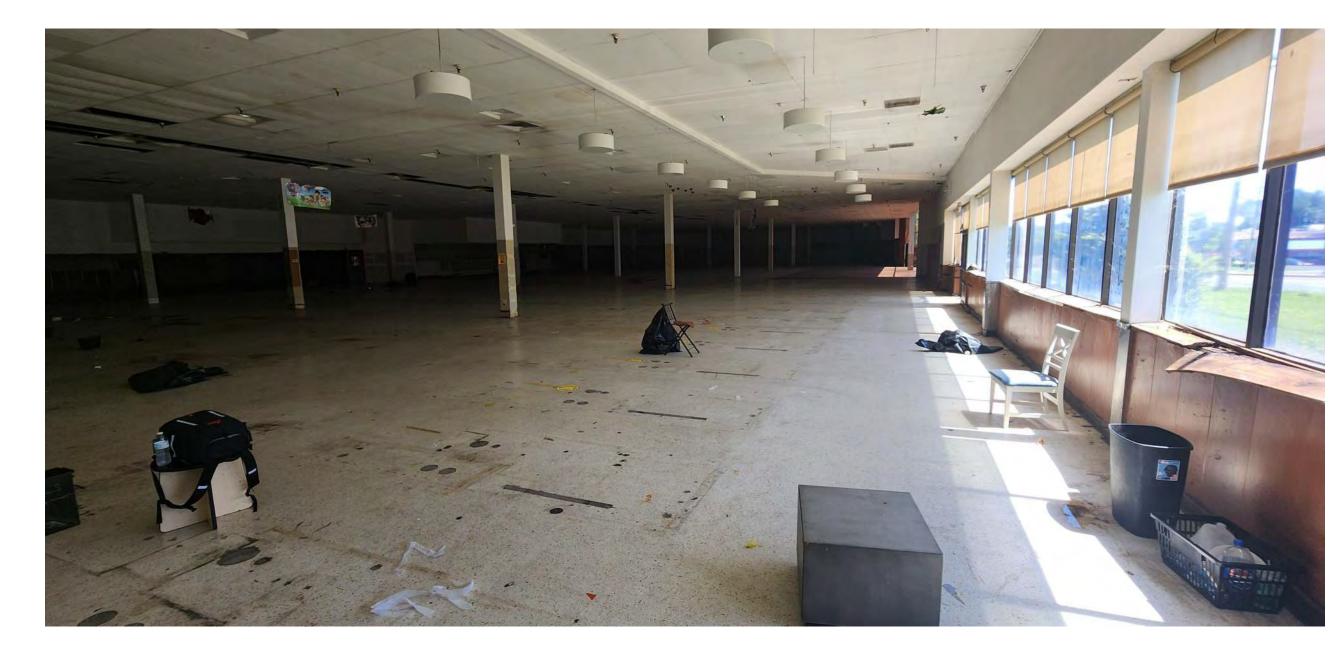


INTERIOR VIEW #1




INTERIOR VIEW #4

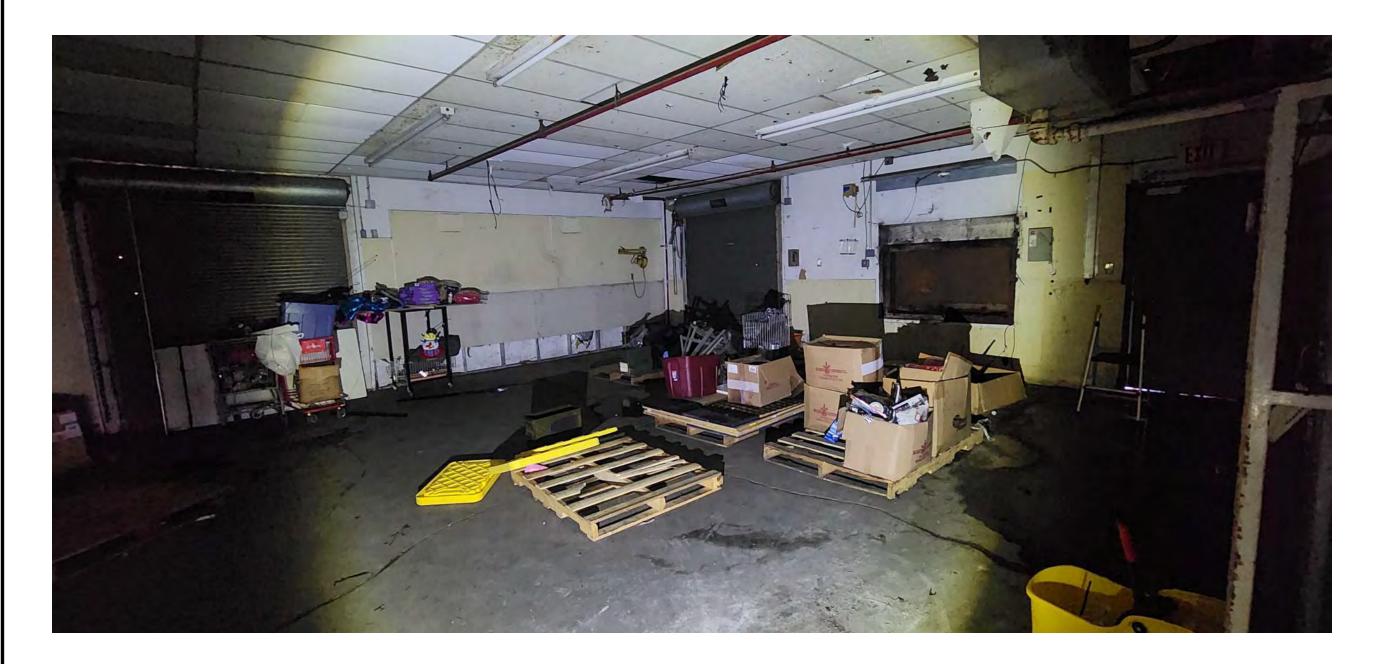


INTERIOR VIEW #7

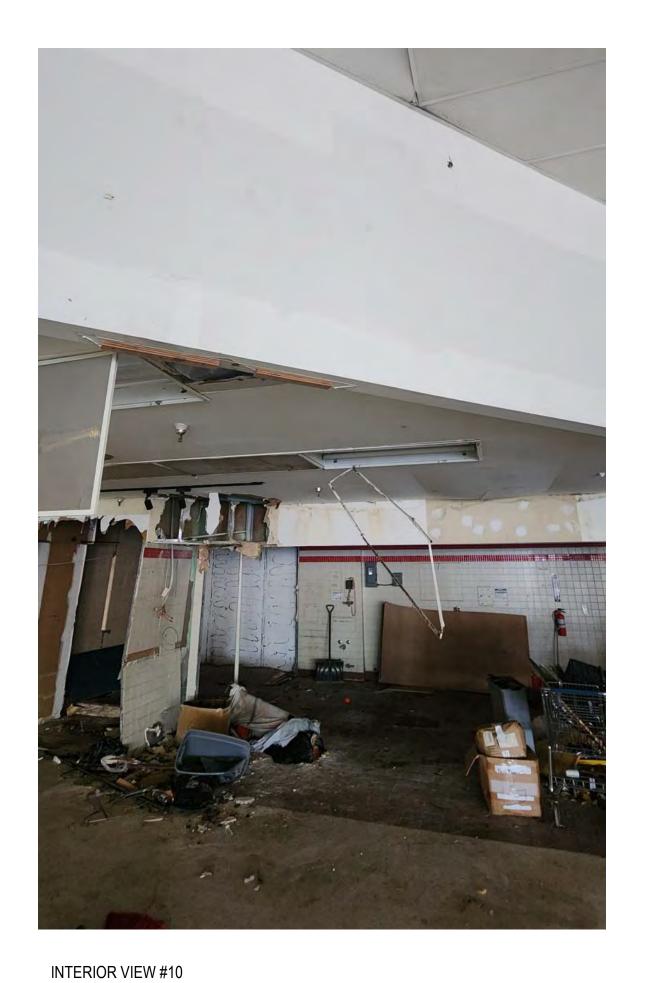

INTERIOR VIEW #11

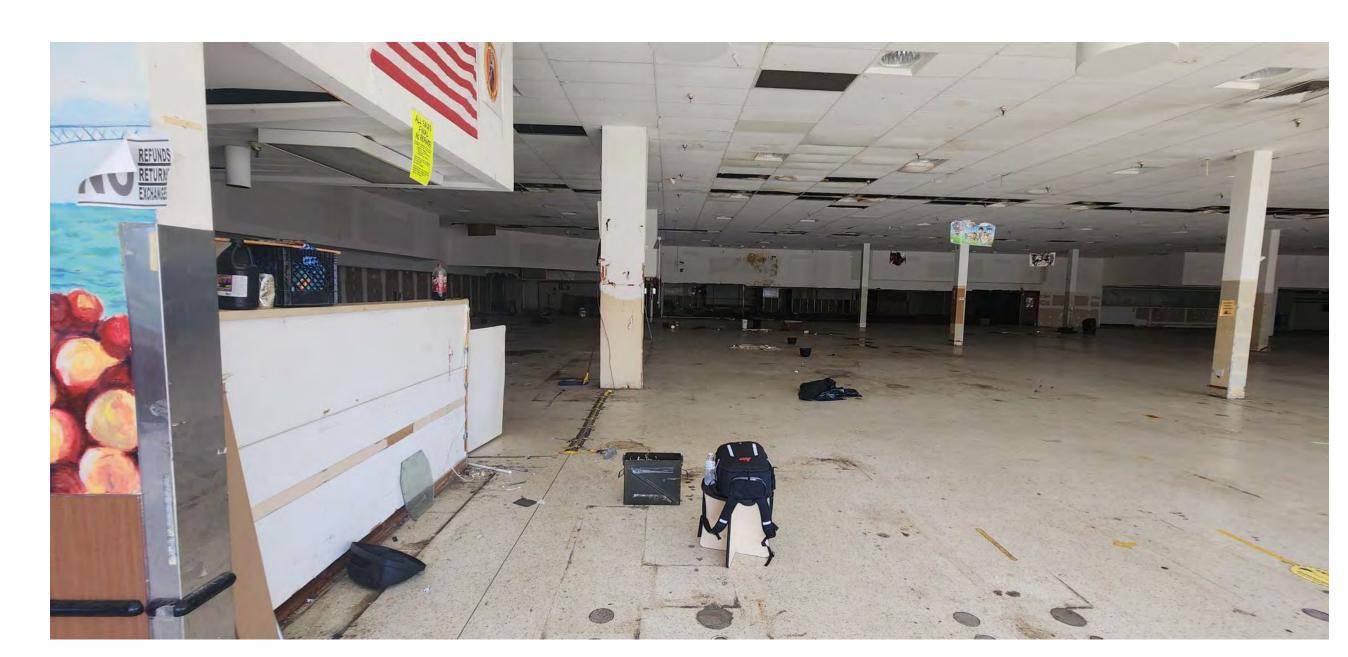

INTERIOR VIEW #2

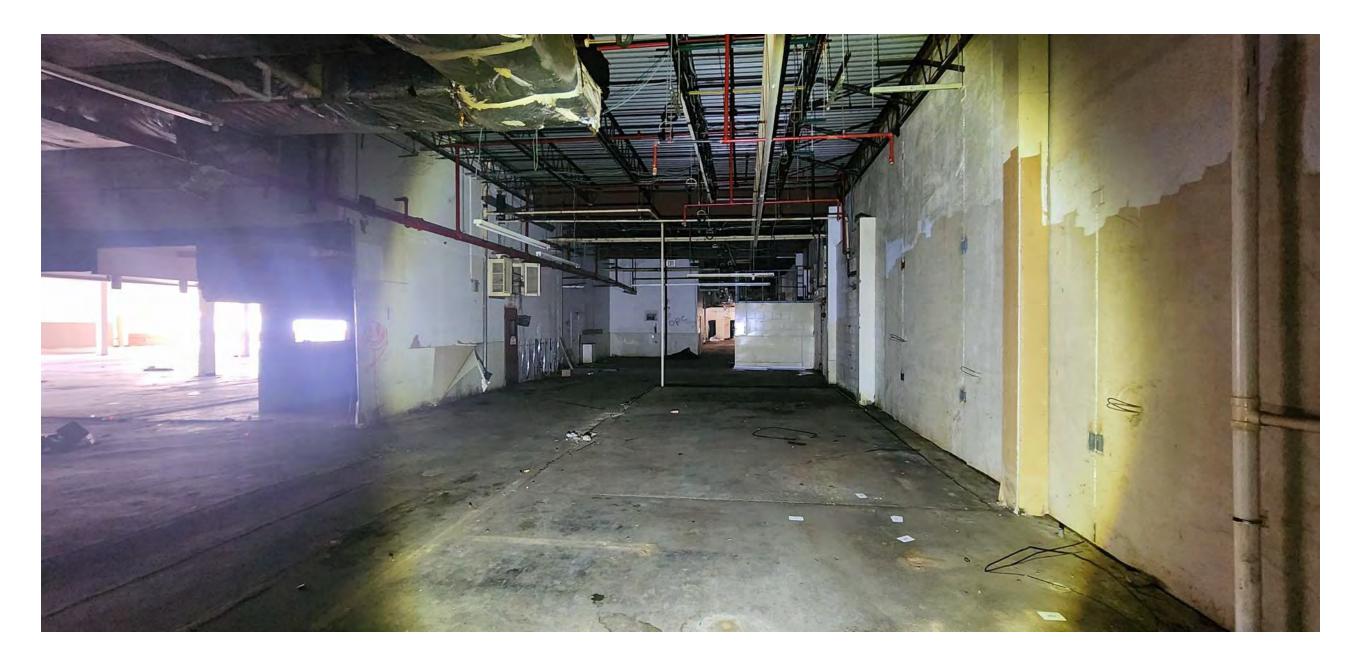

INTERIOR VIEW #5



INTERIOR VIEW #8




INTERIOR VIEW #12




INTERIOR VIEW #13




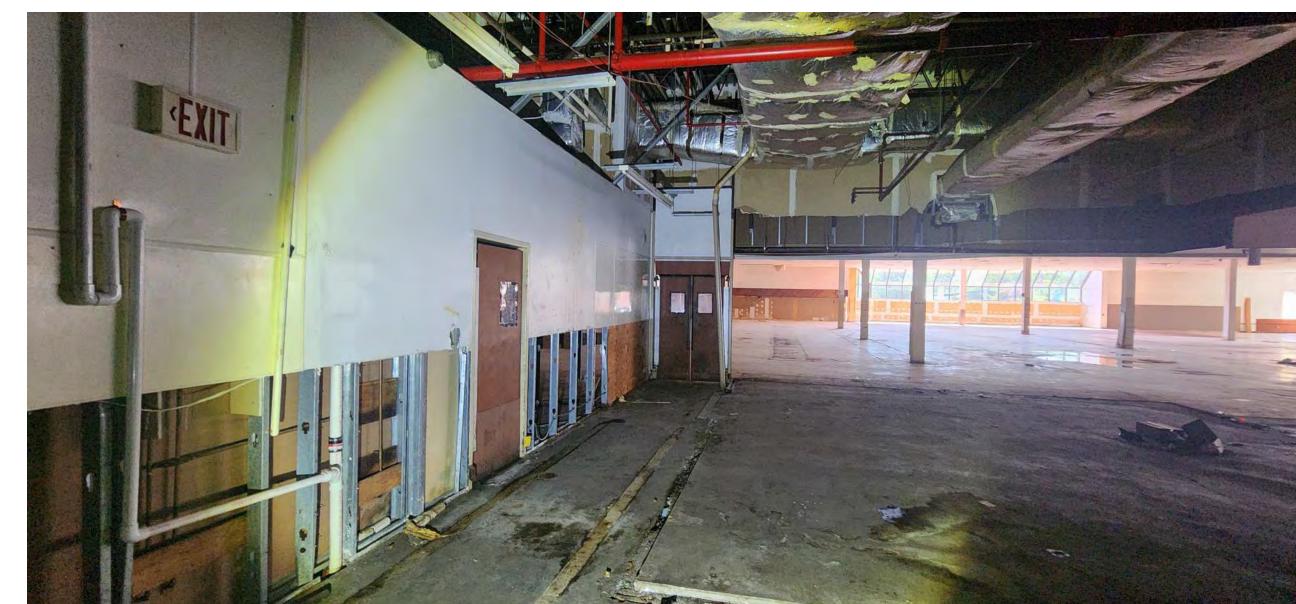


INTERIOR VIEW #6

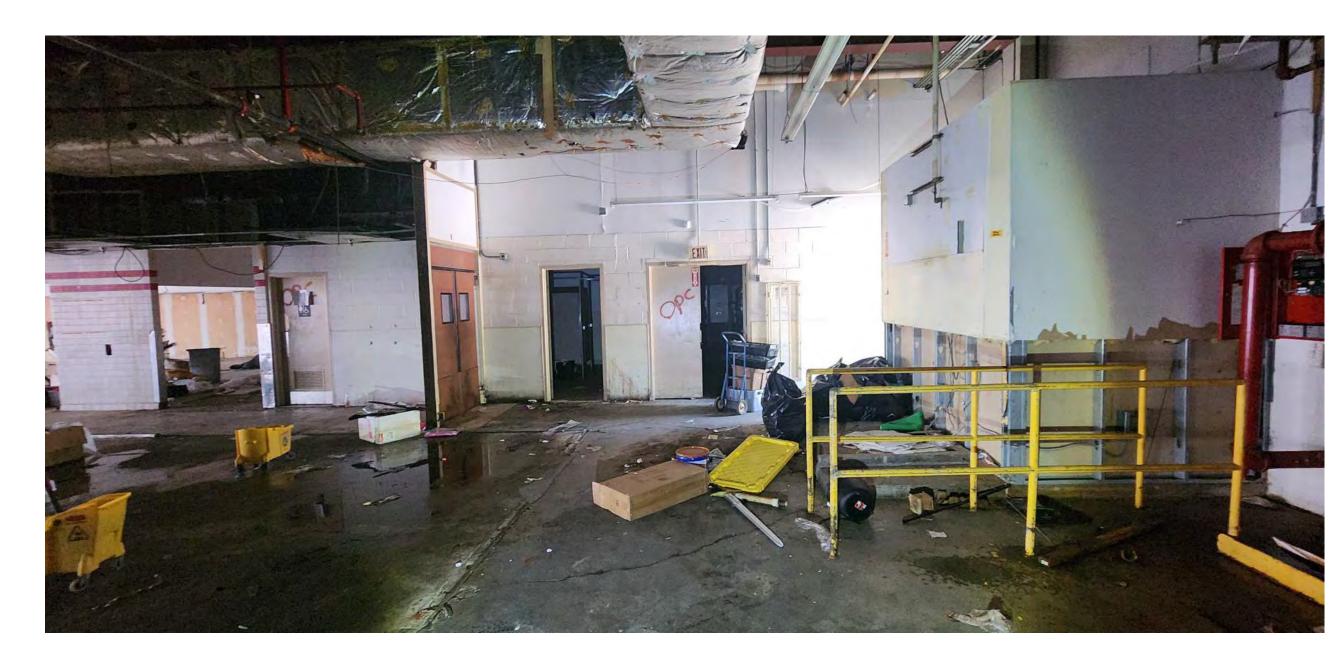

INTERIOR VIEW #9

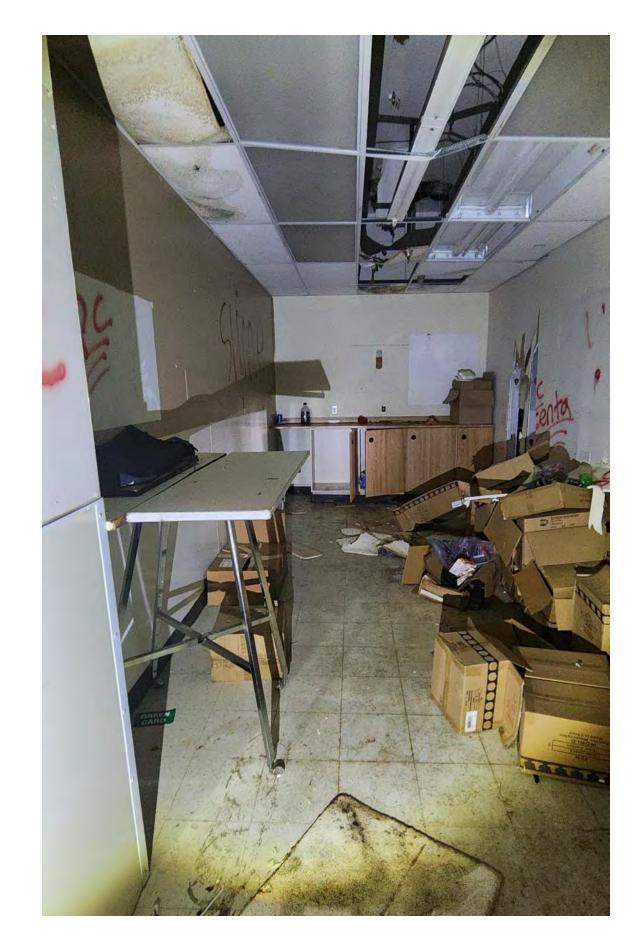

INTERIOR VIEW #14

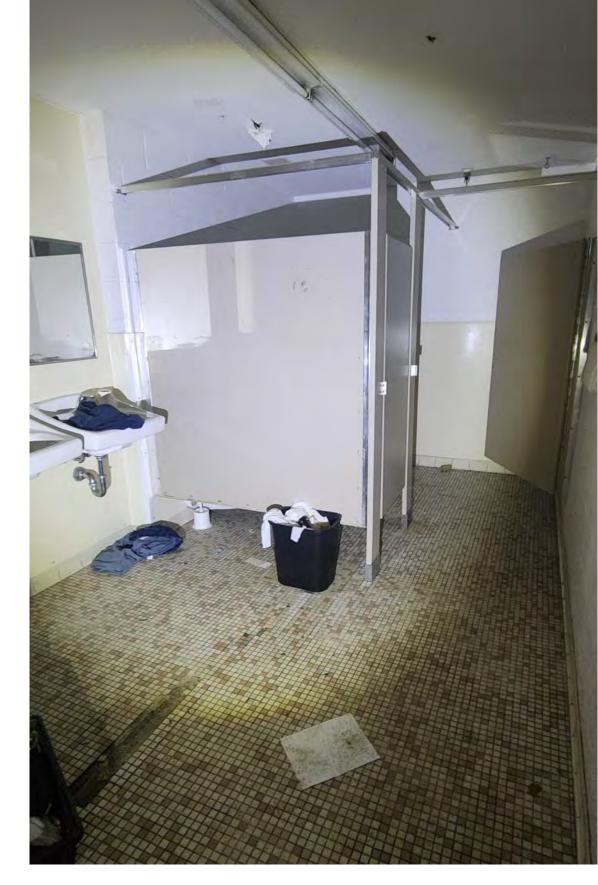

INTERIOR VIEW #15







Professional Certification: I certify that these documents were prepared or approved by me, and that I am a duly licensed architect under the laws of the State of Maryland, license number , expiration date .


ANNE ARUNDEL COUNTY											
NO. DESCRIPTION	ВҮ	DATE			DEPARTM	ENT	OF P	UBLI	C WORKS		
			APPROVED	DATE	APPROVED	DATE	SC ALE:		EDGEWATER RECREATION CENTER		
							DRAWN BY:	Author	3130 SOLOMONS ISLAND RD, EDGEWATER, MD, 21037		
			CHIEF ENGINEER		PROJECT MANAGER		CHECKED BY:	Checker			
			APPROVED	DATE	APPROVED		SHEET NO.	OF			
							PROJECT NO.	24104-00	existing photos – interior $\mid AD-108 \mid$		
			ASSISTANT CHIEF ENGINEER		CHIEF, RIGHT OF WAY		PROPOSAL NO.				



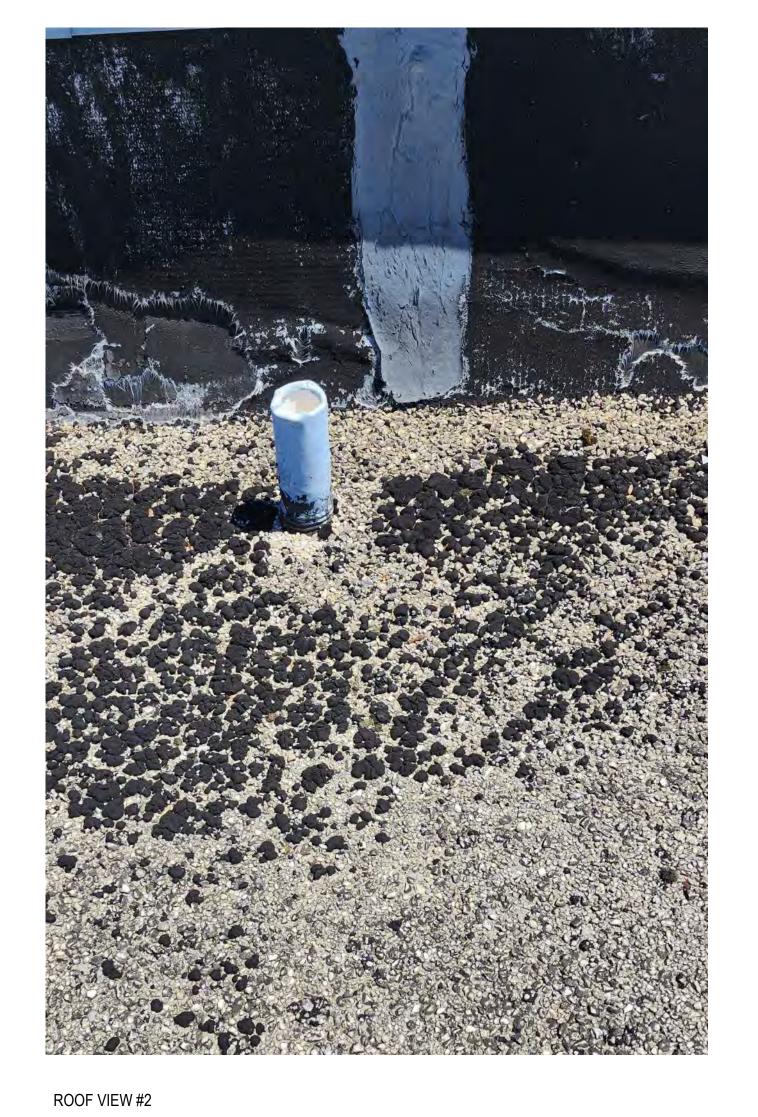



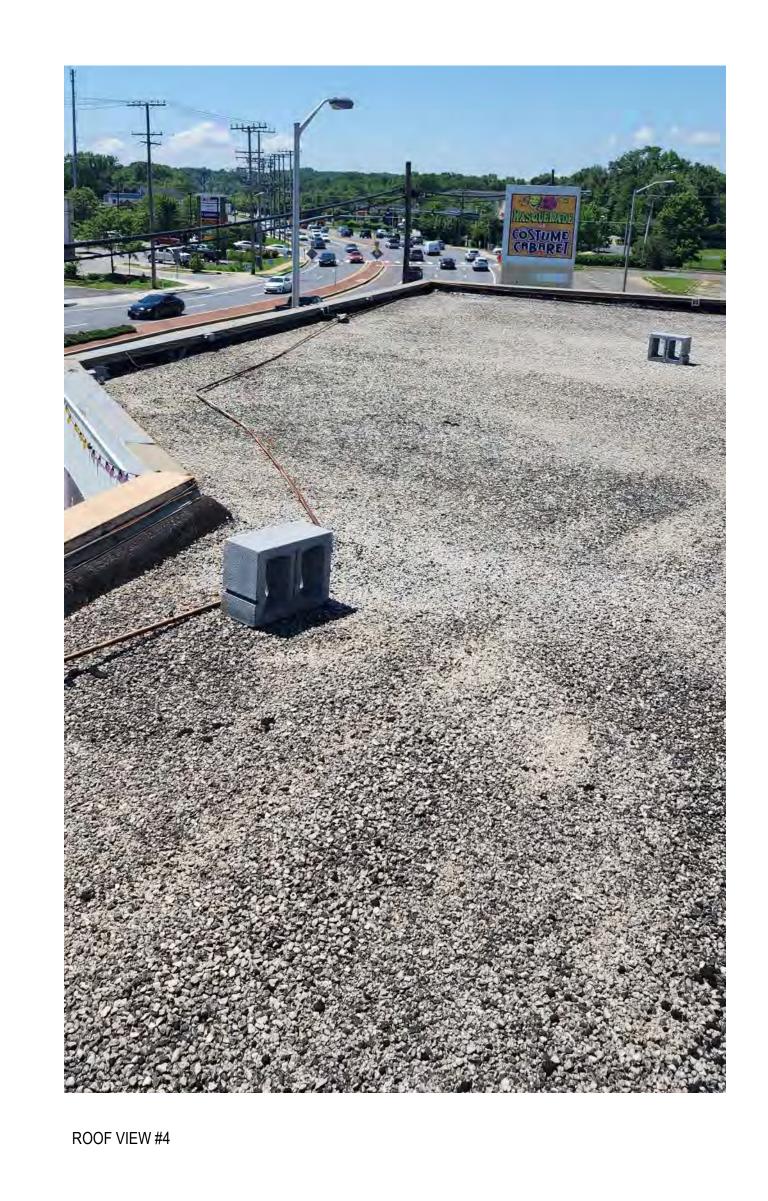

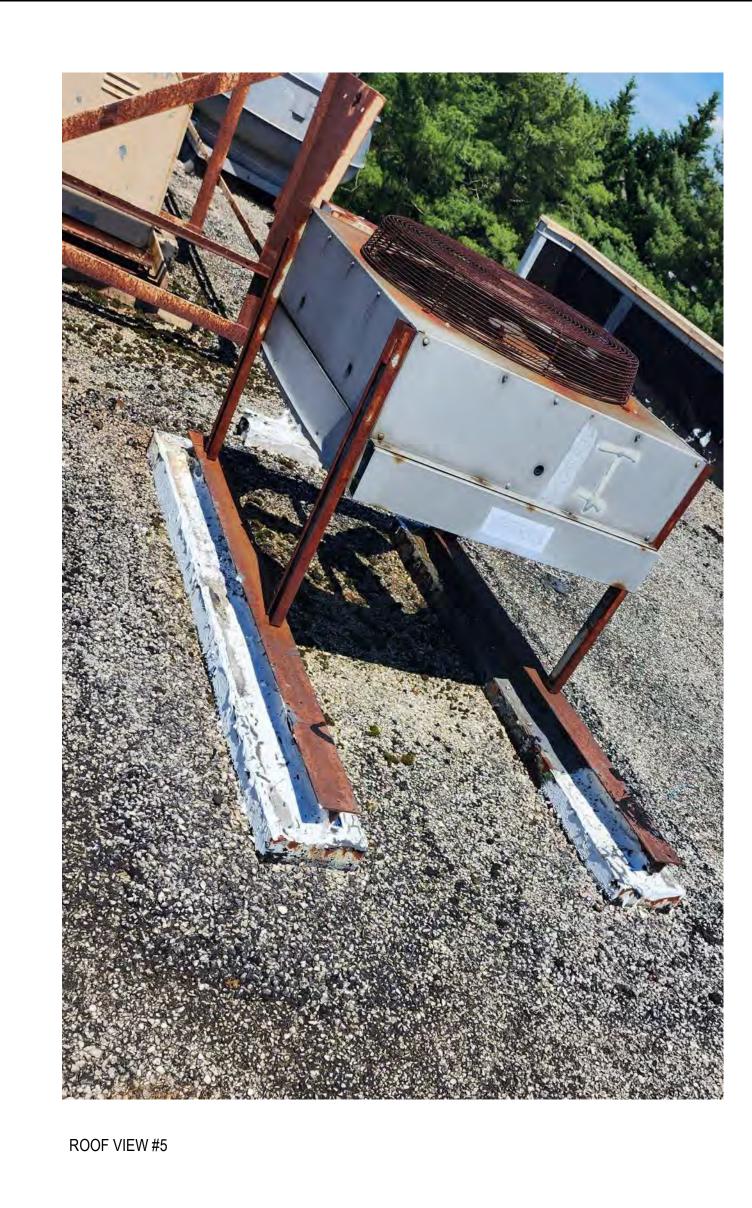












ROOF VIEW #6





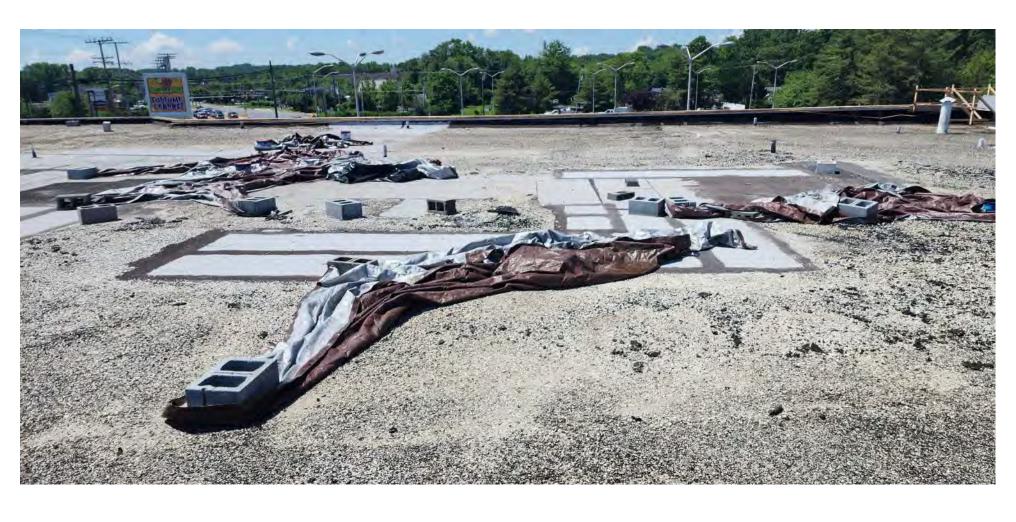



ROOF VIEW #10






ROOF VIEW #11

ROOF VIEW #7



ROOF VIEW #8

ROOF VIEW #12

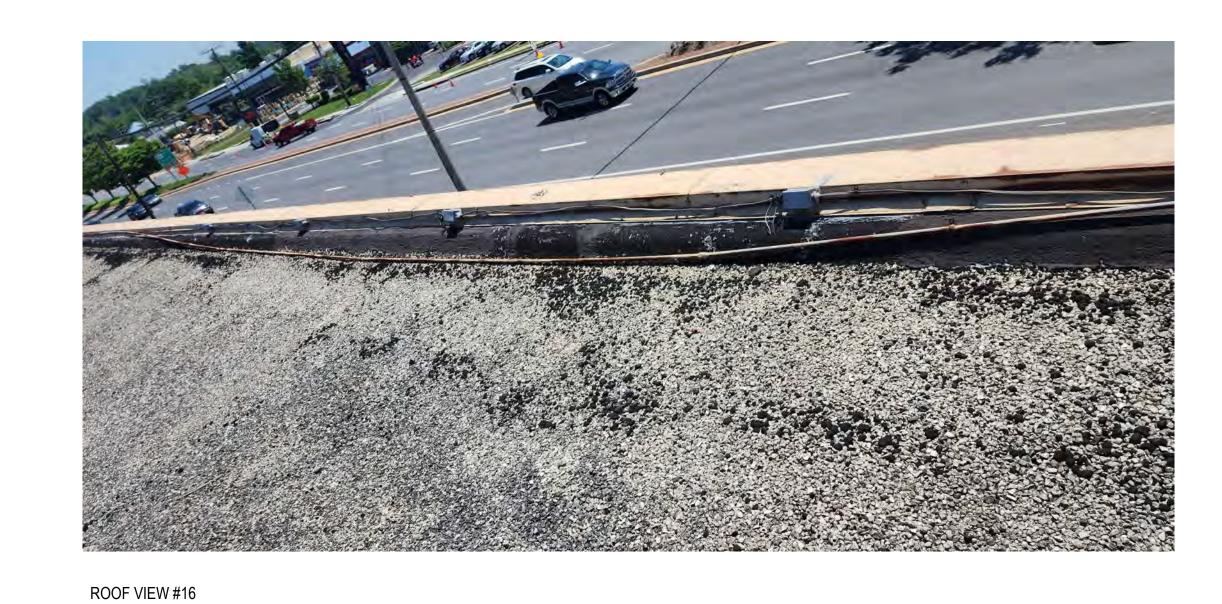

ROOF VIEW #14







Professional Certification: I certify that
these documents were prepared or
approved by me, and that I am a duly
licensed architect under the laws of the
State of Maryland, license
number , expiration
date .


							ANNE	AR	UNDEL CO	UNTY	
N	10.	DESCRIPTION	ВҮ	DATE			DEPARTME	NT	OF PUBLI	C WORKS	
					APPROVED	DATE	APPROVED	DATE	SC ALE:	EDGEWATER RECREATION	N CENTER
									DRAWN BY: Author	3130 SOLOMONS ISLAND RD, EDGEV	VATER. MD. 21037
					CHIEF ENGINEER	_	PROJECT MANAGER		CHECKED BY: Checker	STOC SOLUTION ISLAND IND, EDGE	TITELL, ME, WILLOUI
					- APPROVED	DATE	APPROVED	DATE	SHEET NO. OF		1 T O 1 0 0
									PROJECT NO. 24104-00	EXISTING PHOTOS - ROOF	AD - 109
					ASSISTANT CHIEF ENGINEER	-	CHIEF, RIGHT OF WAY		PROPOSAL NO.		


ROOF VIEW #9


ROOF VIEW #13

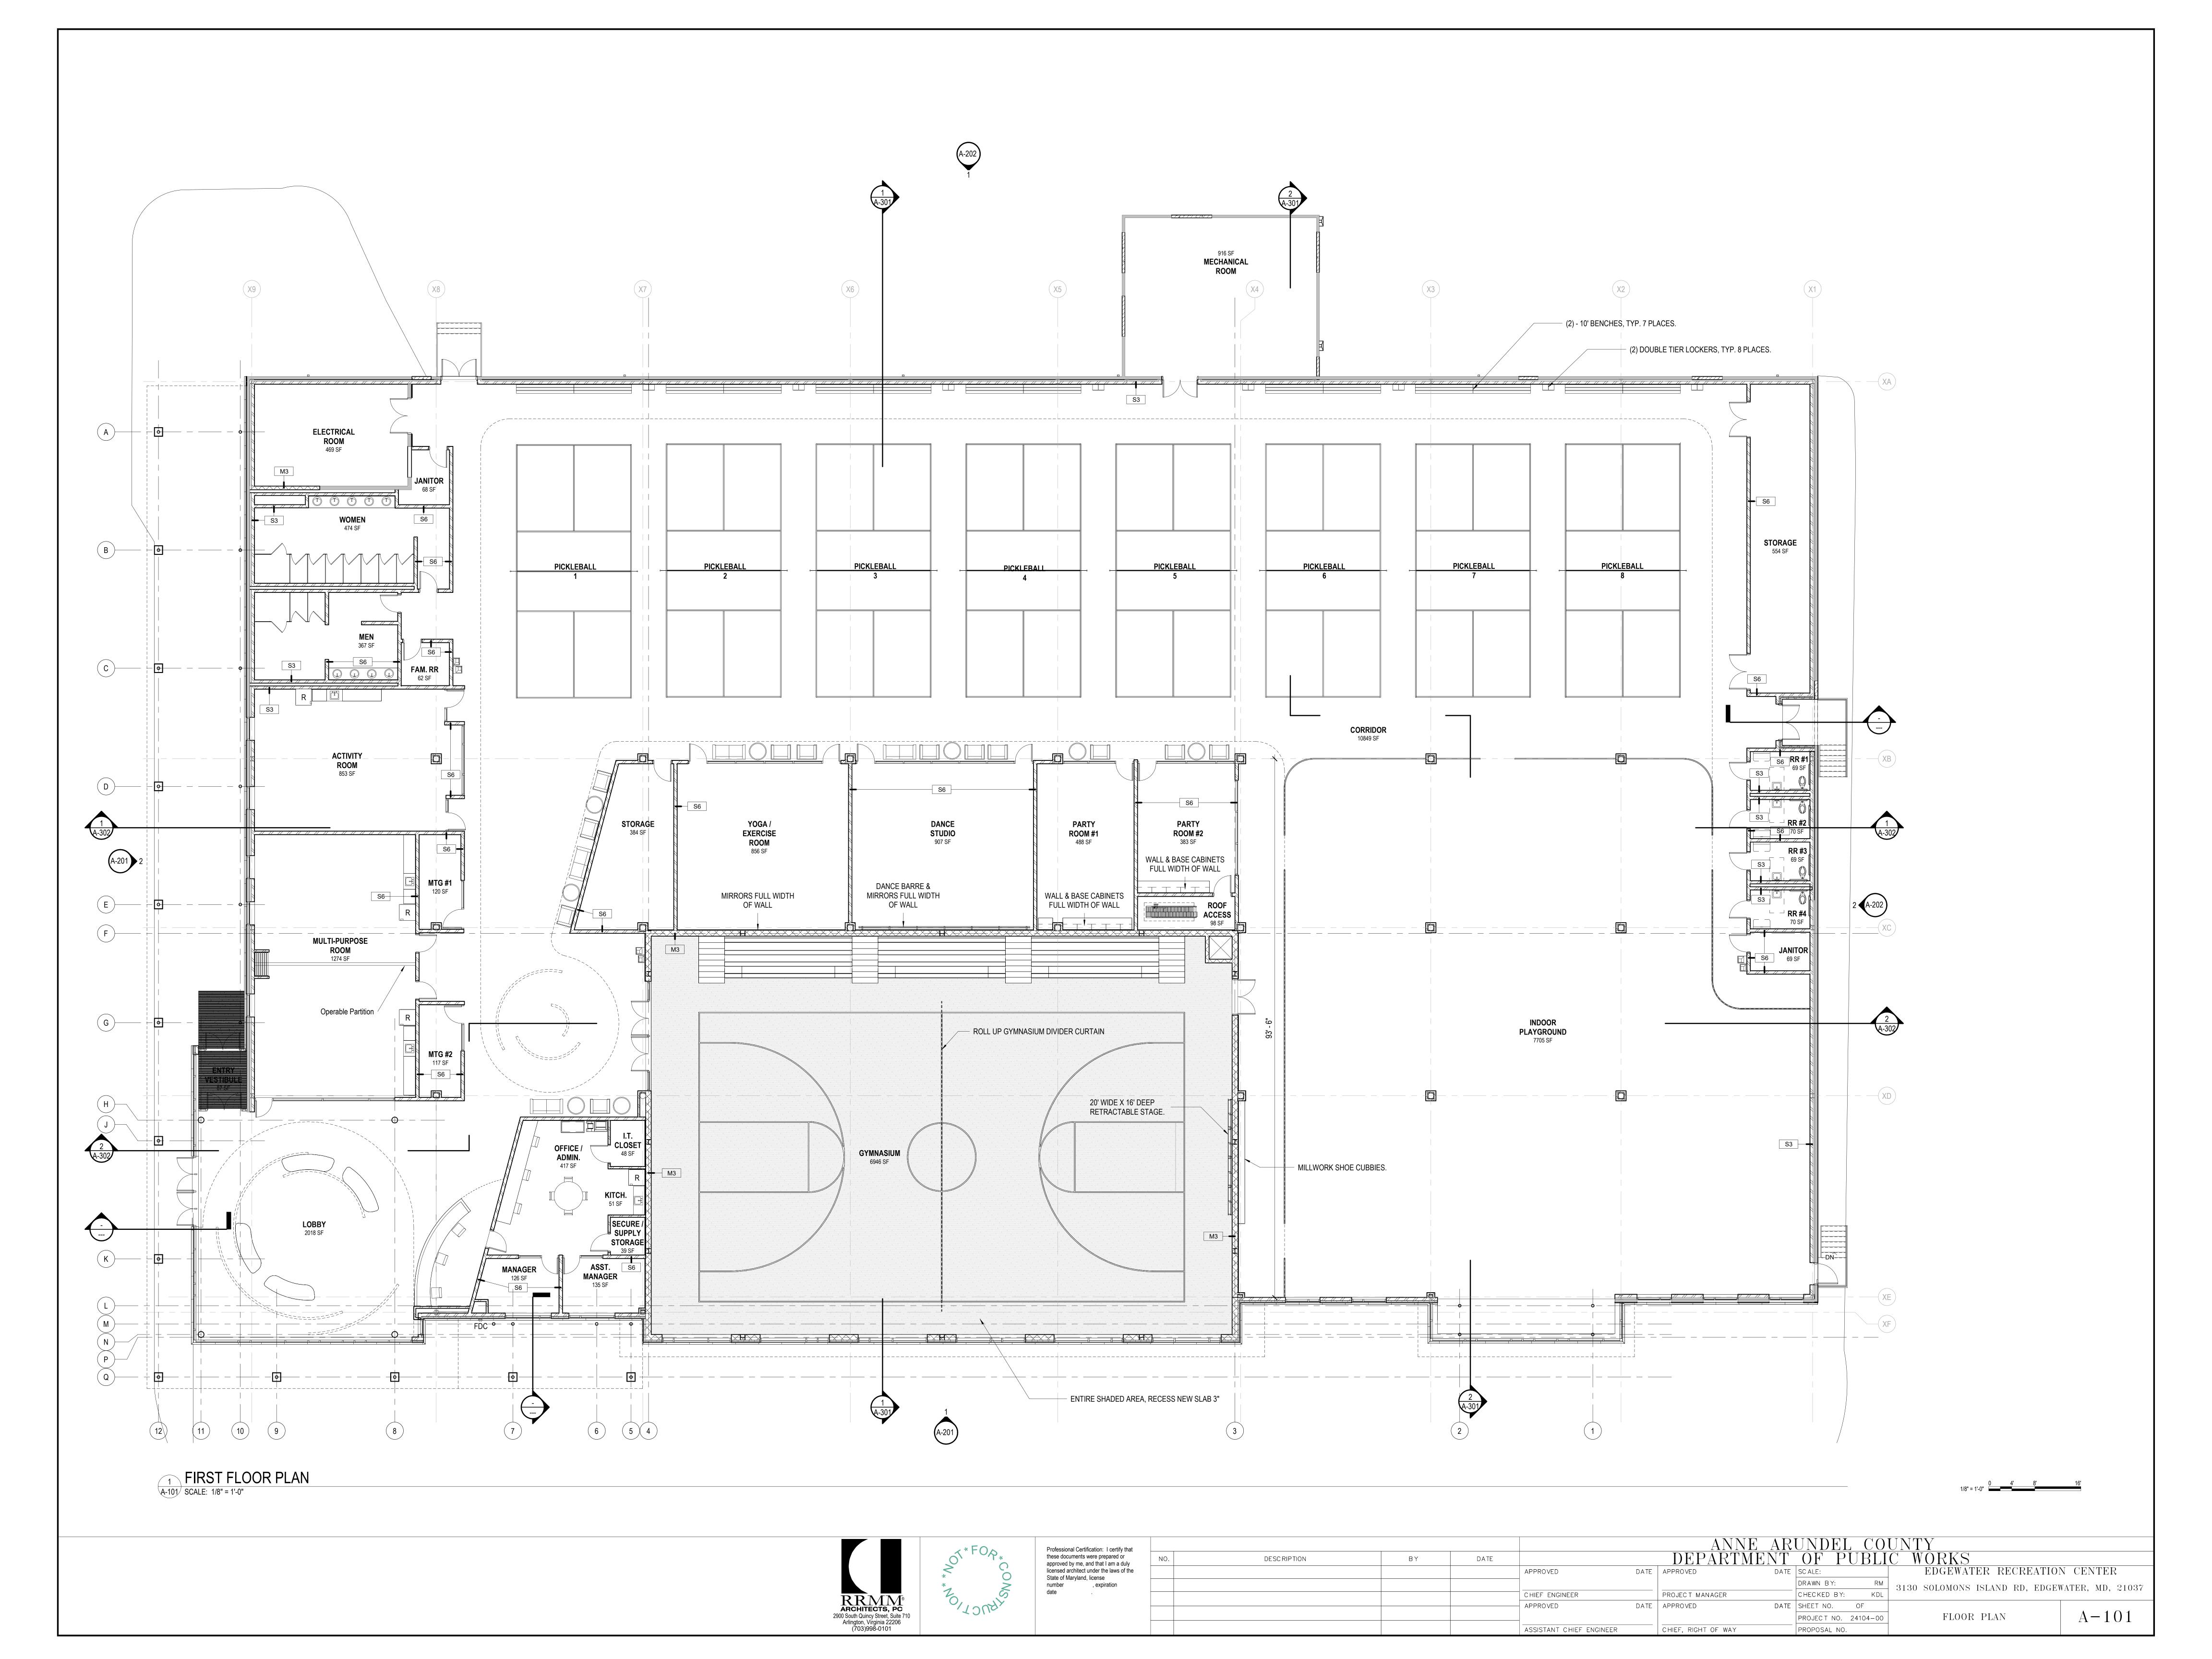


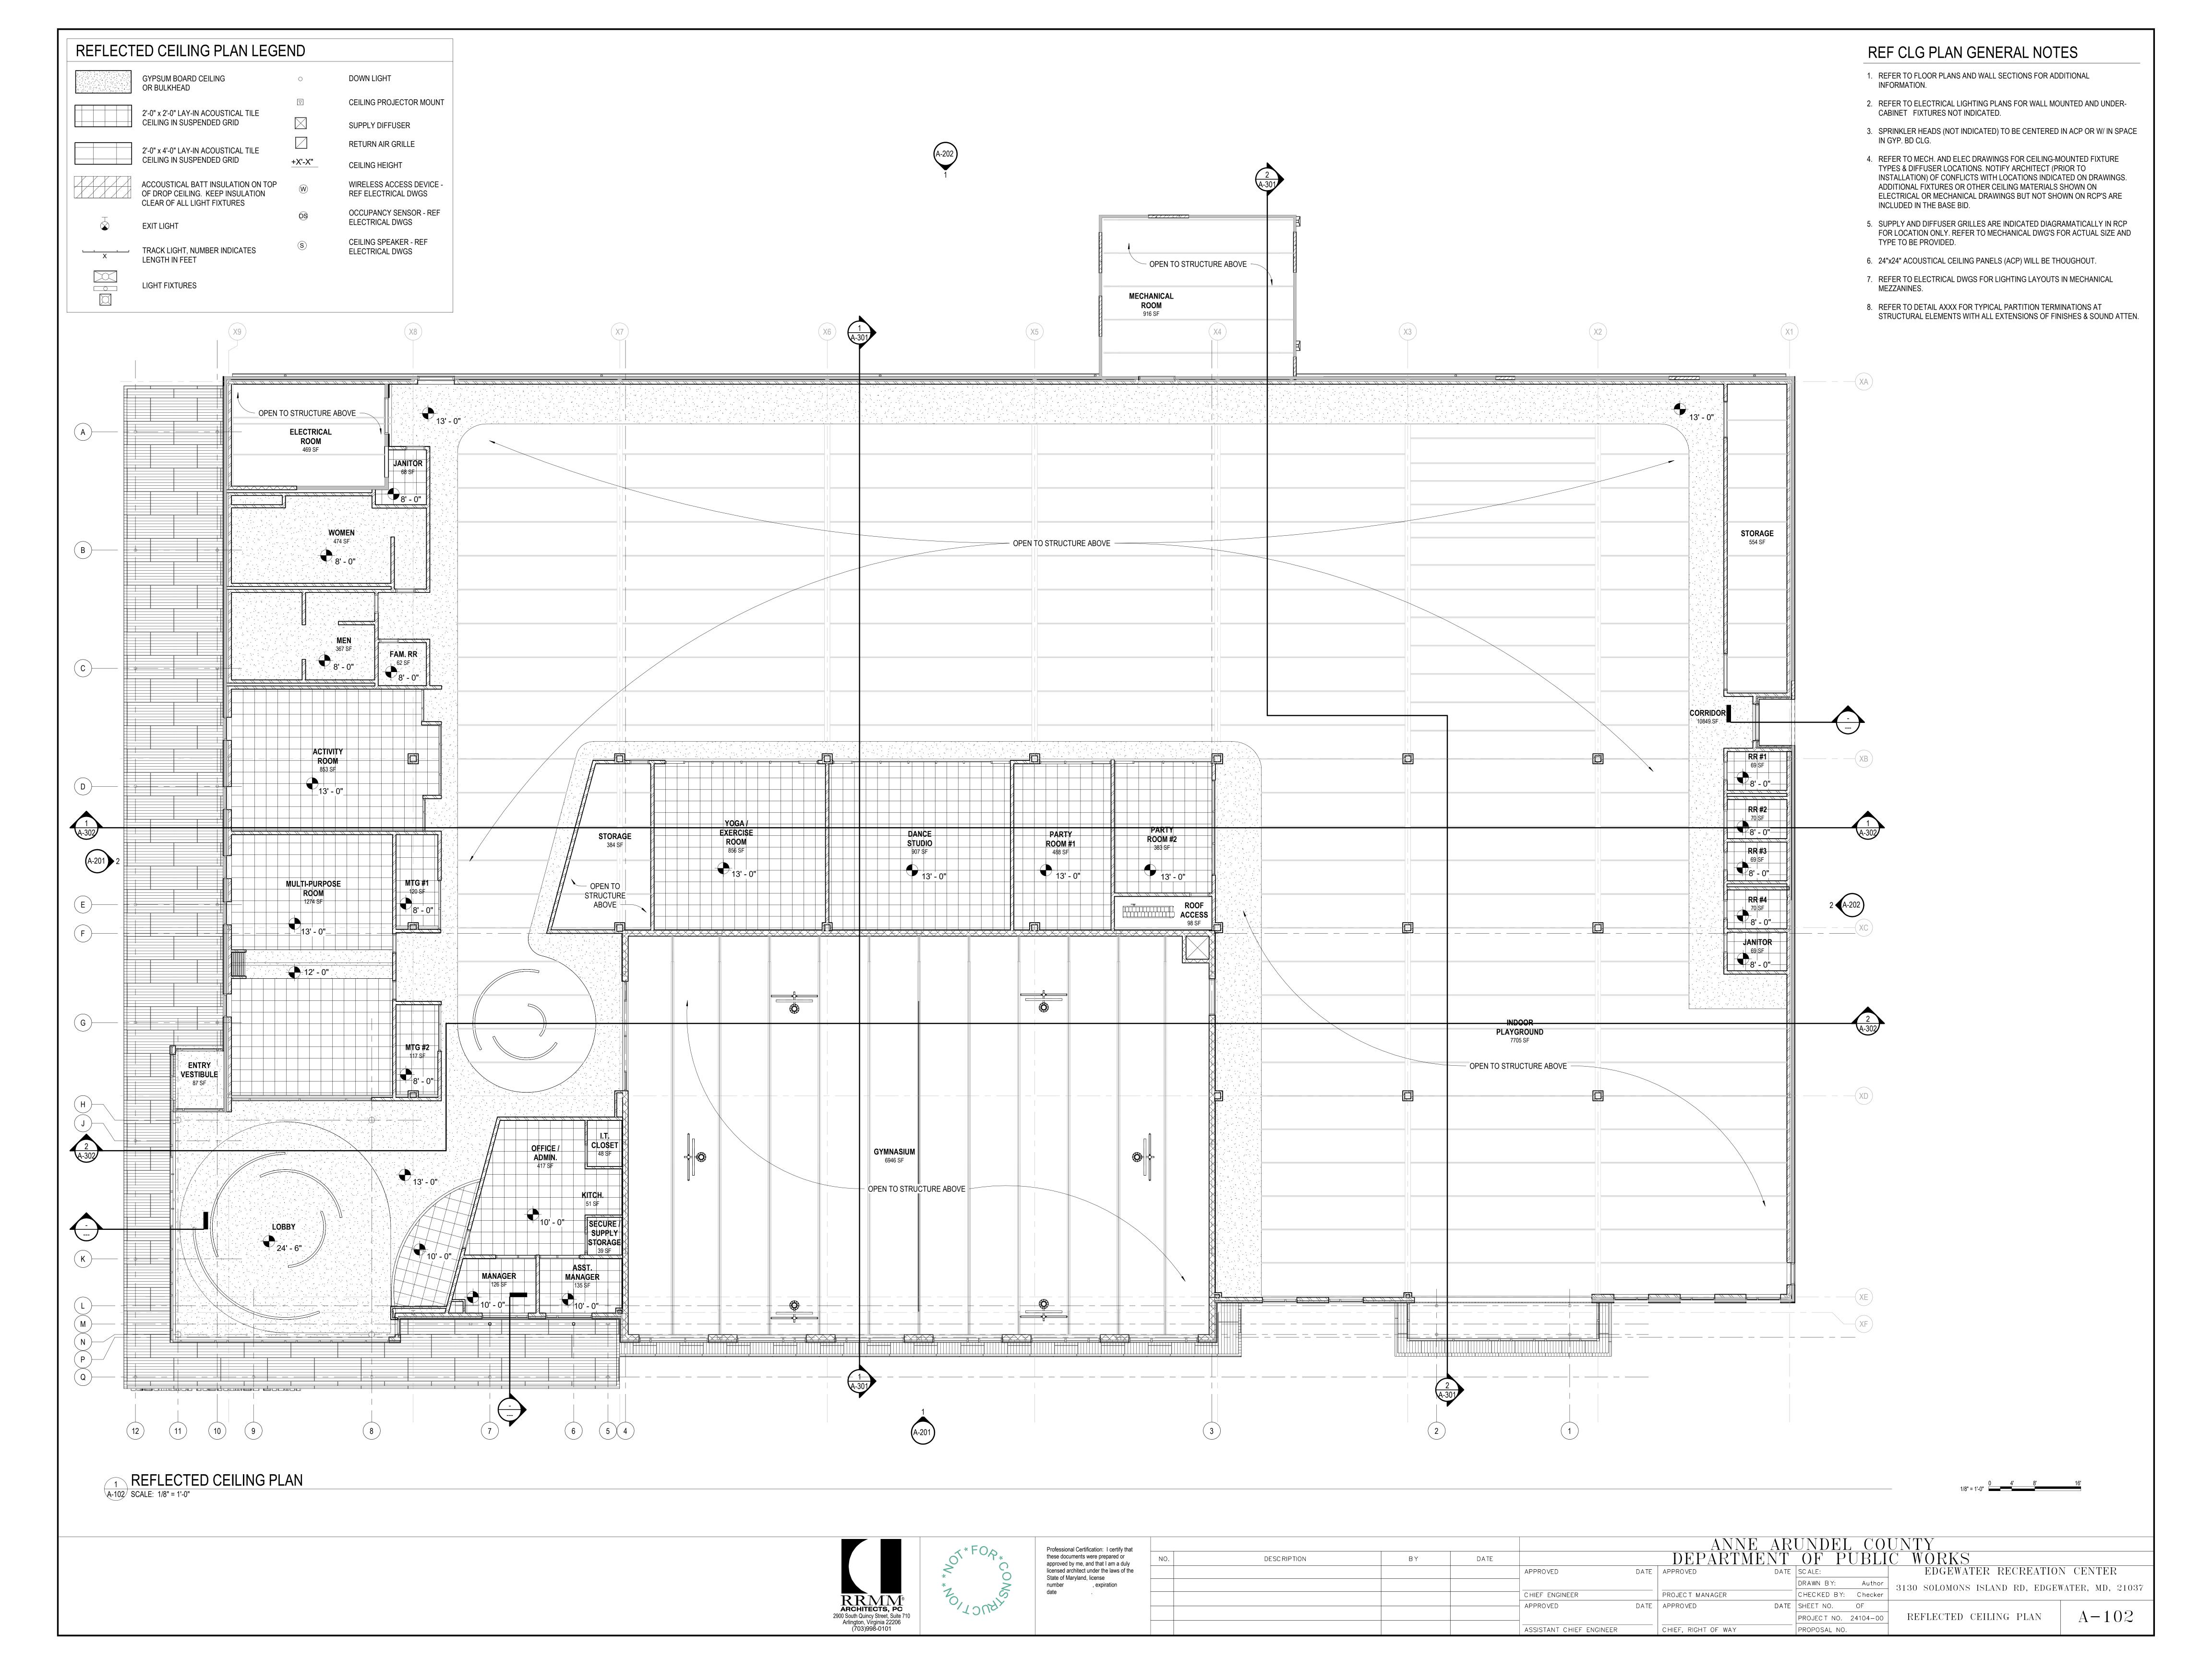

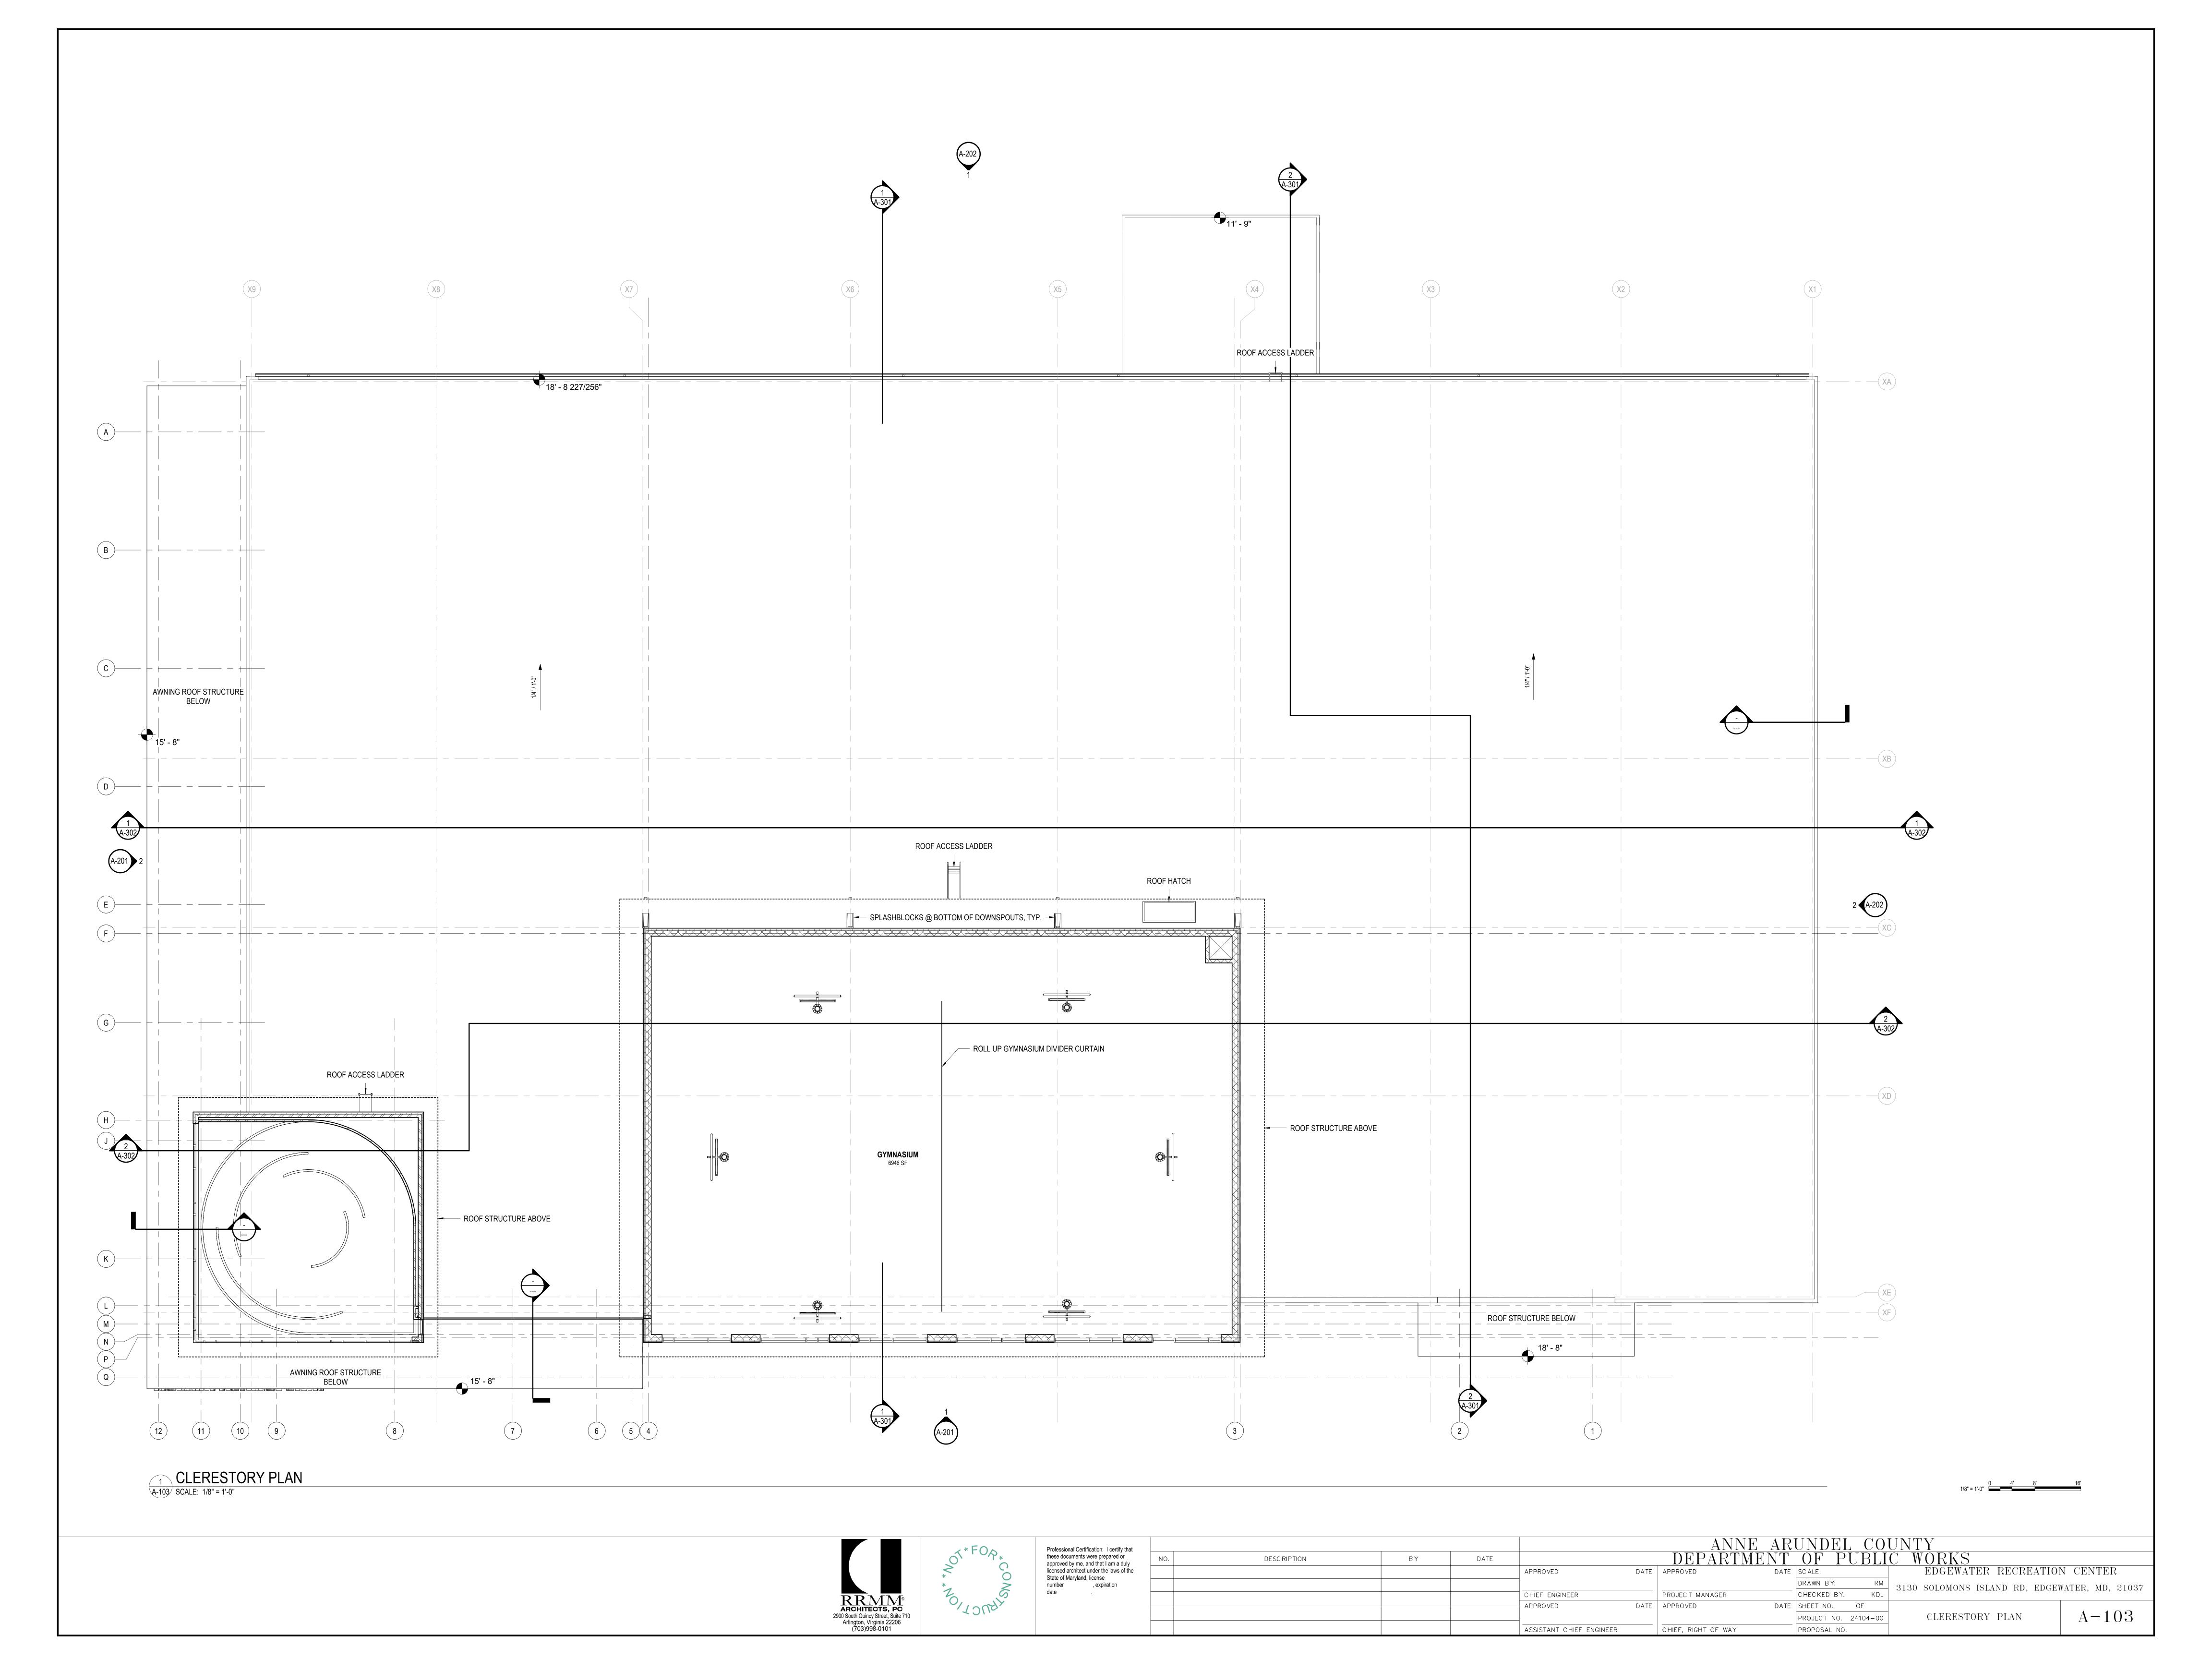

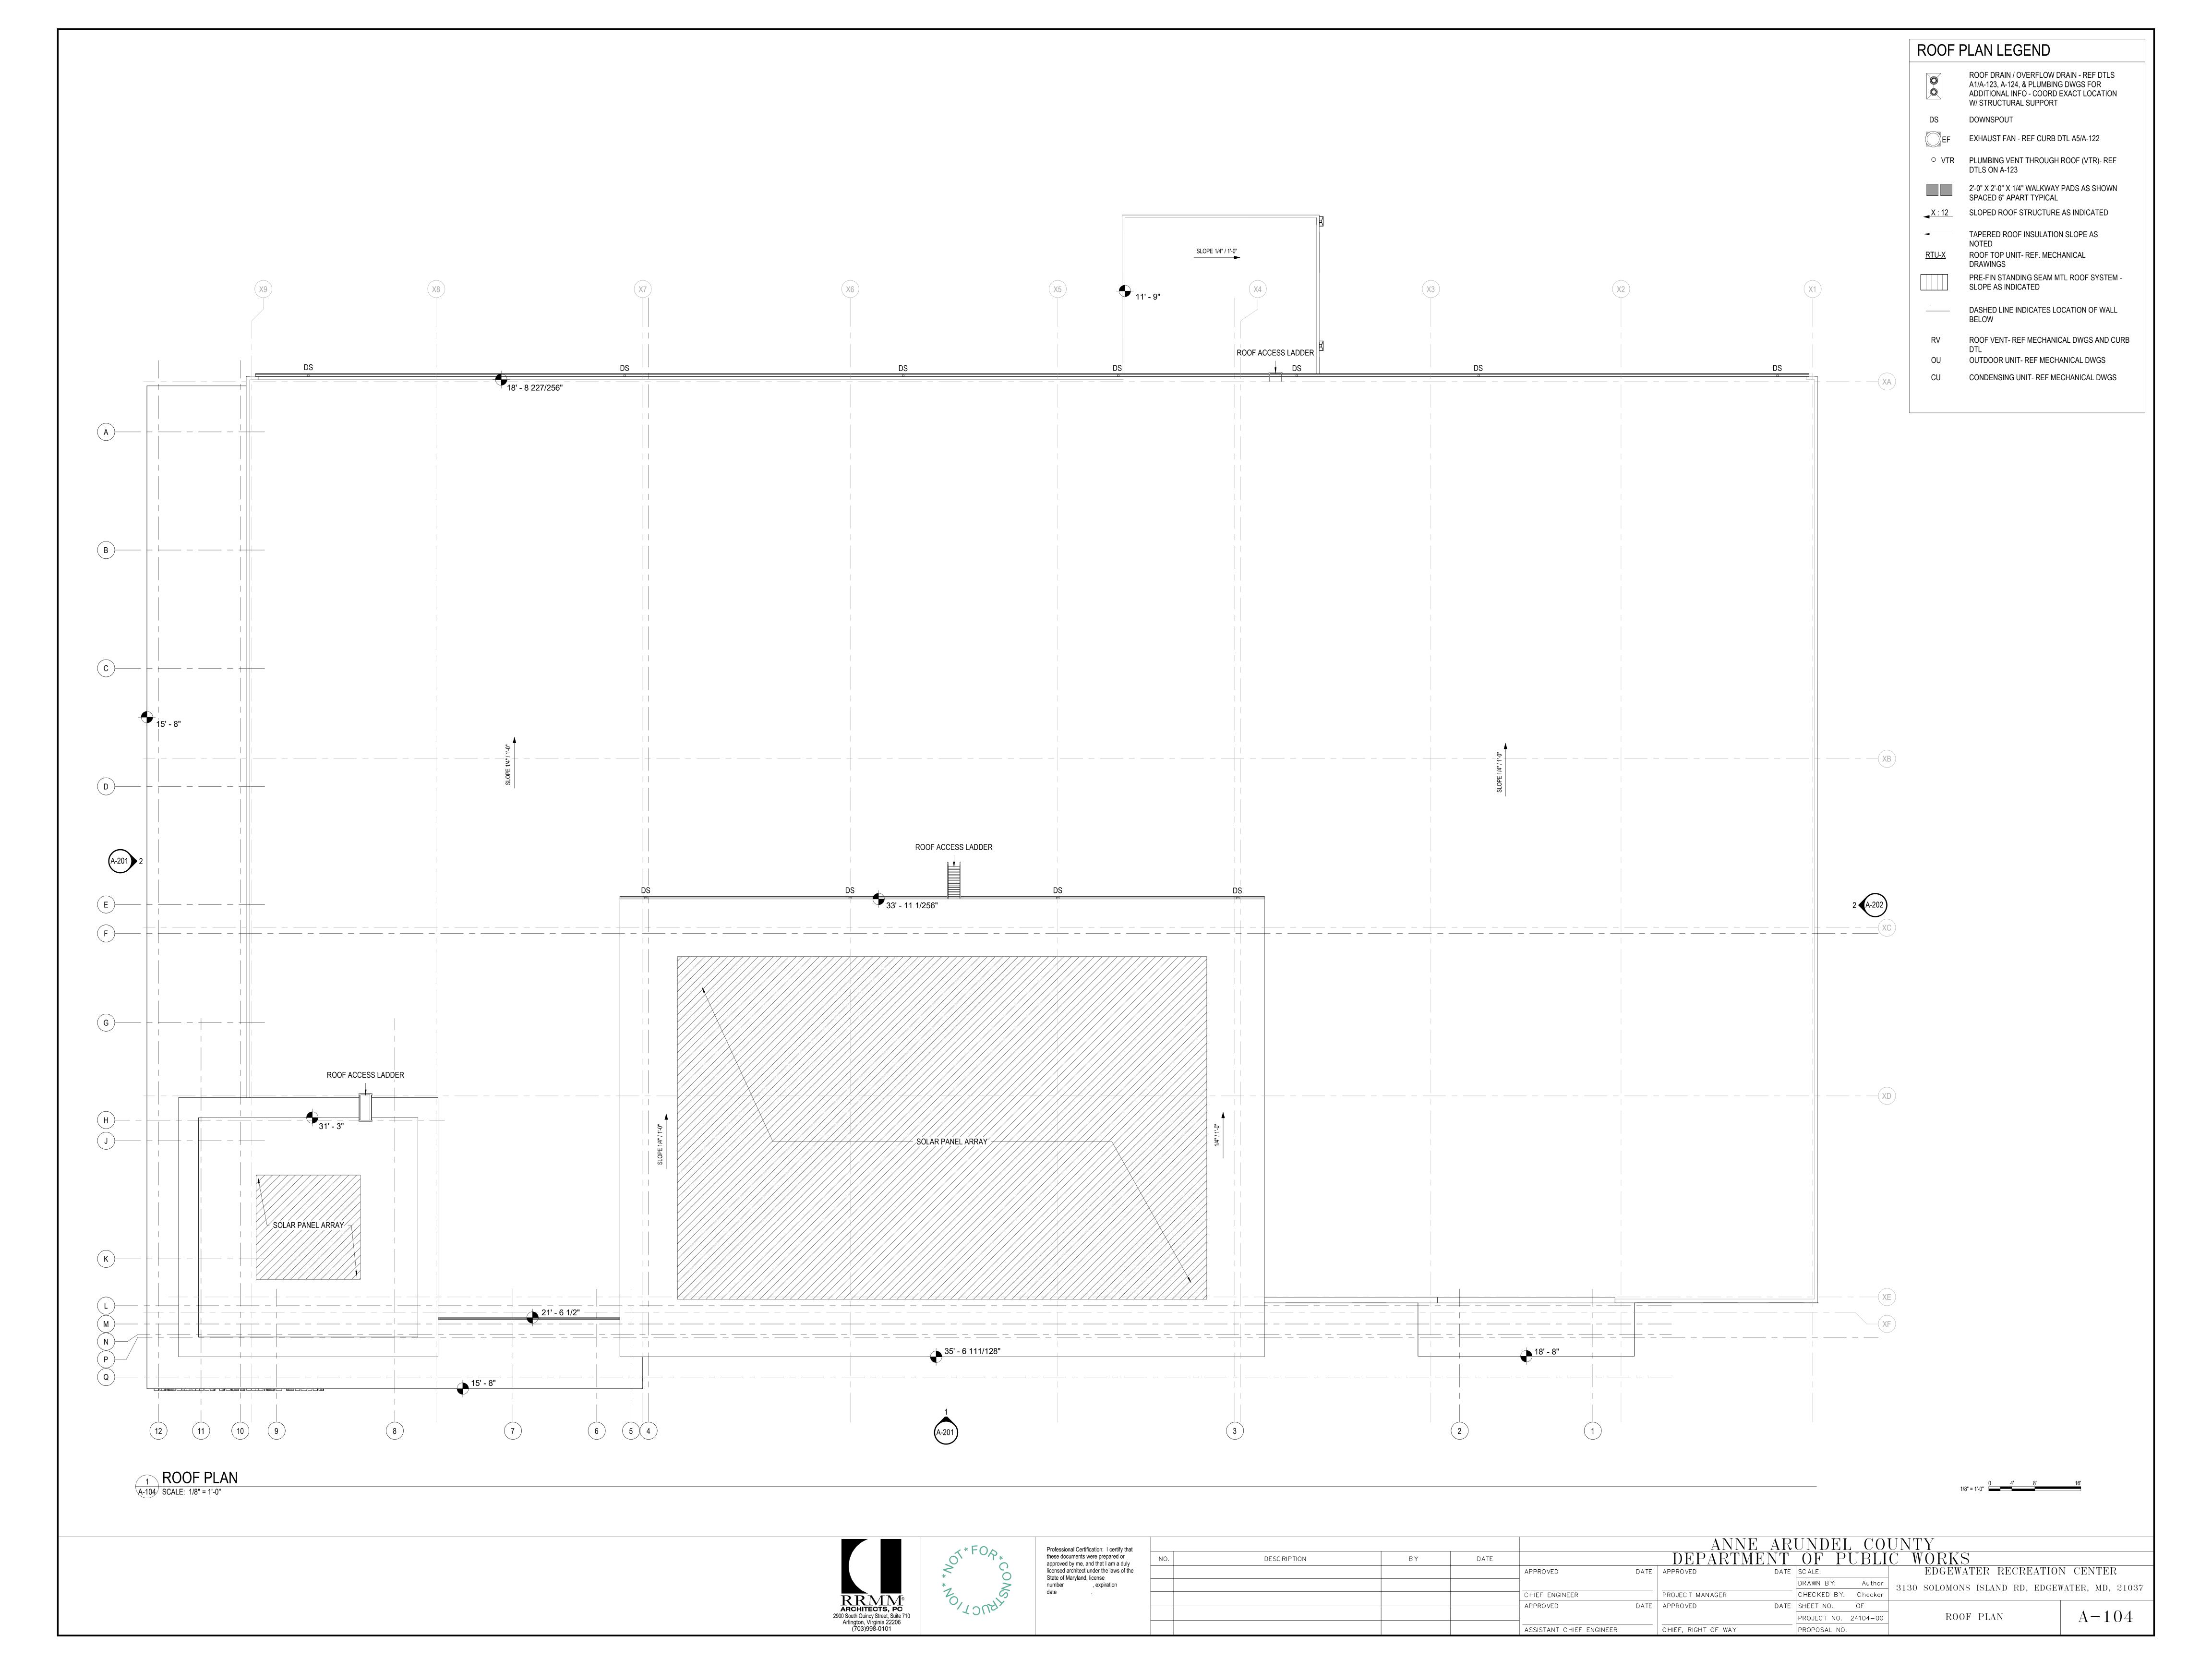

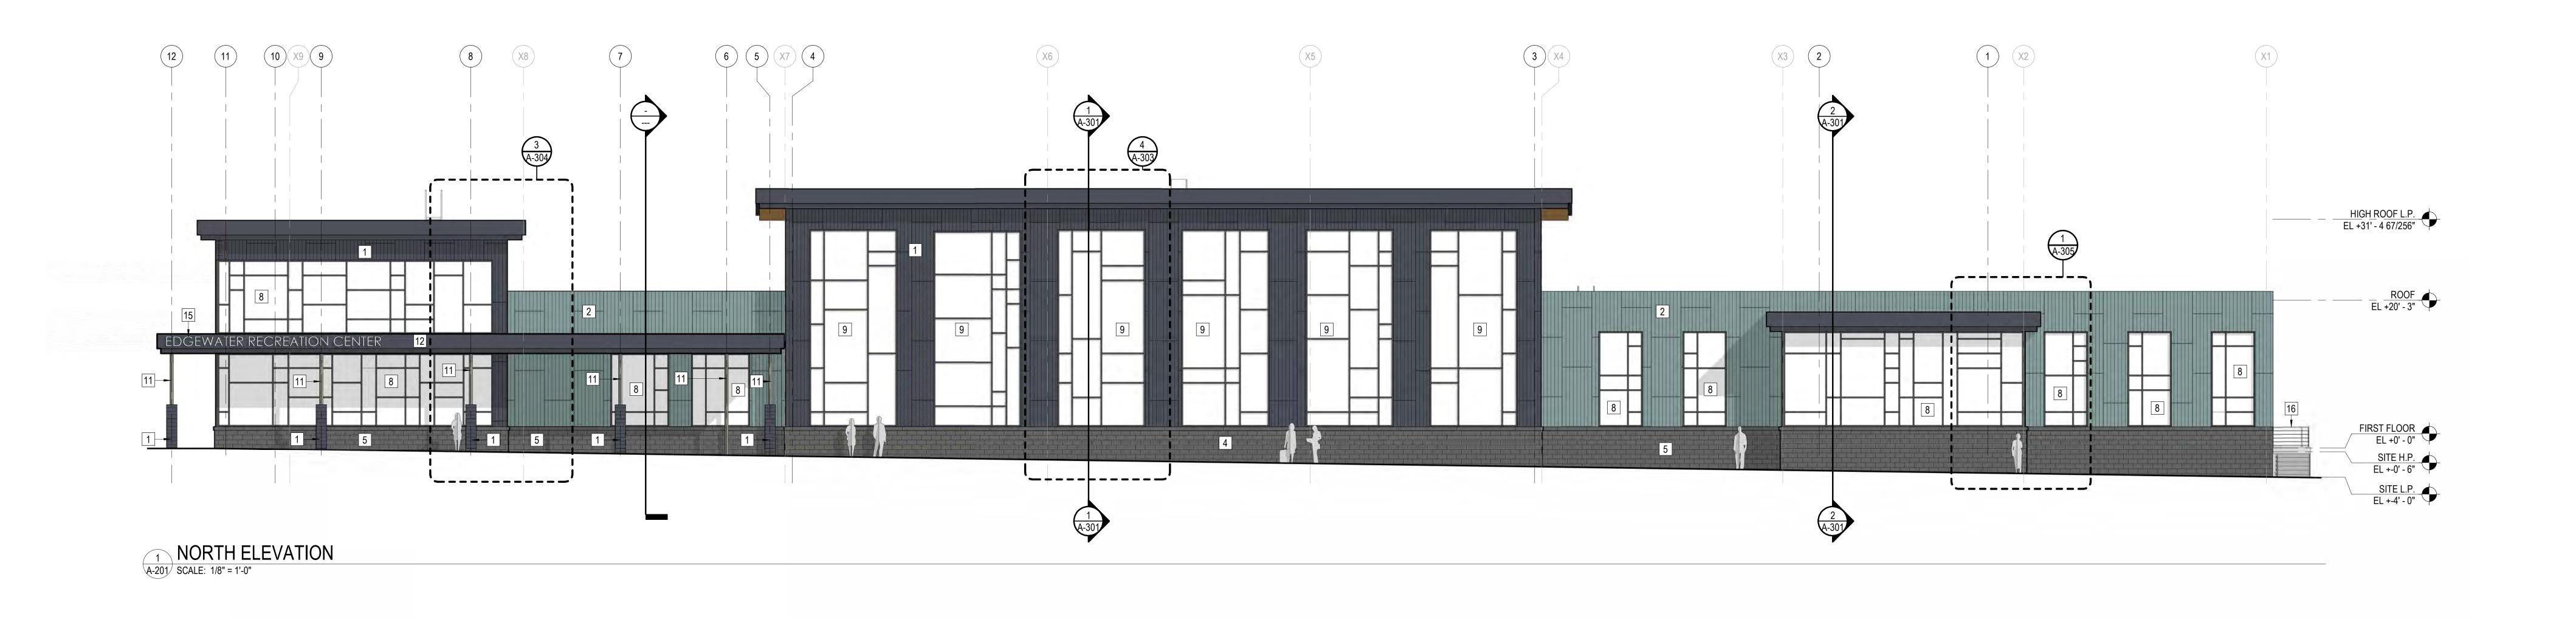

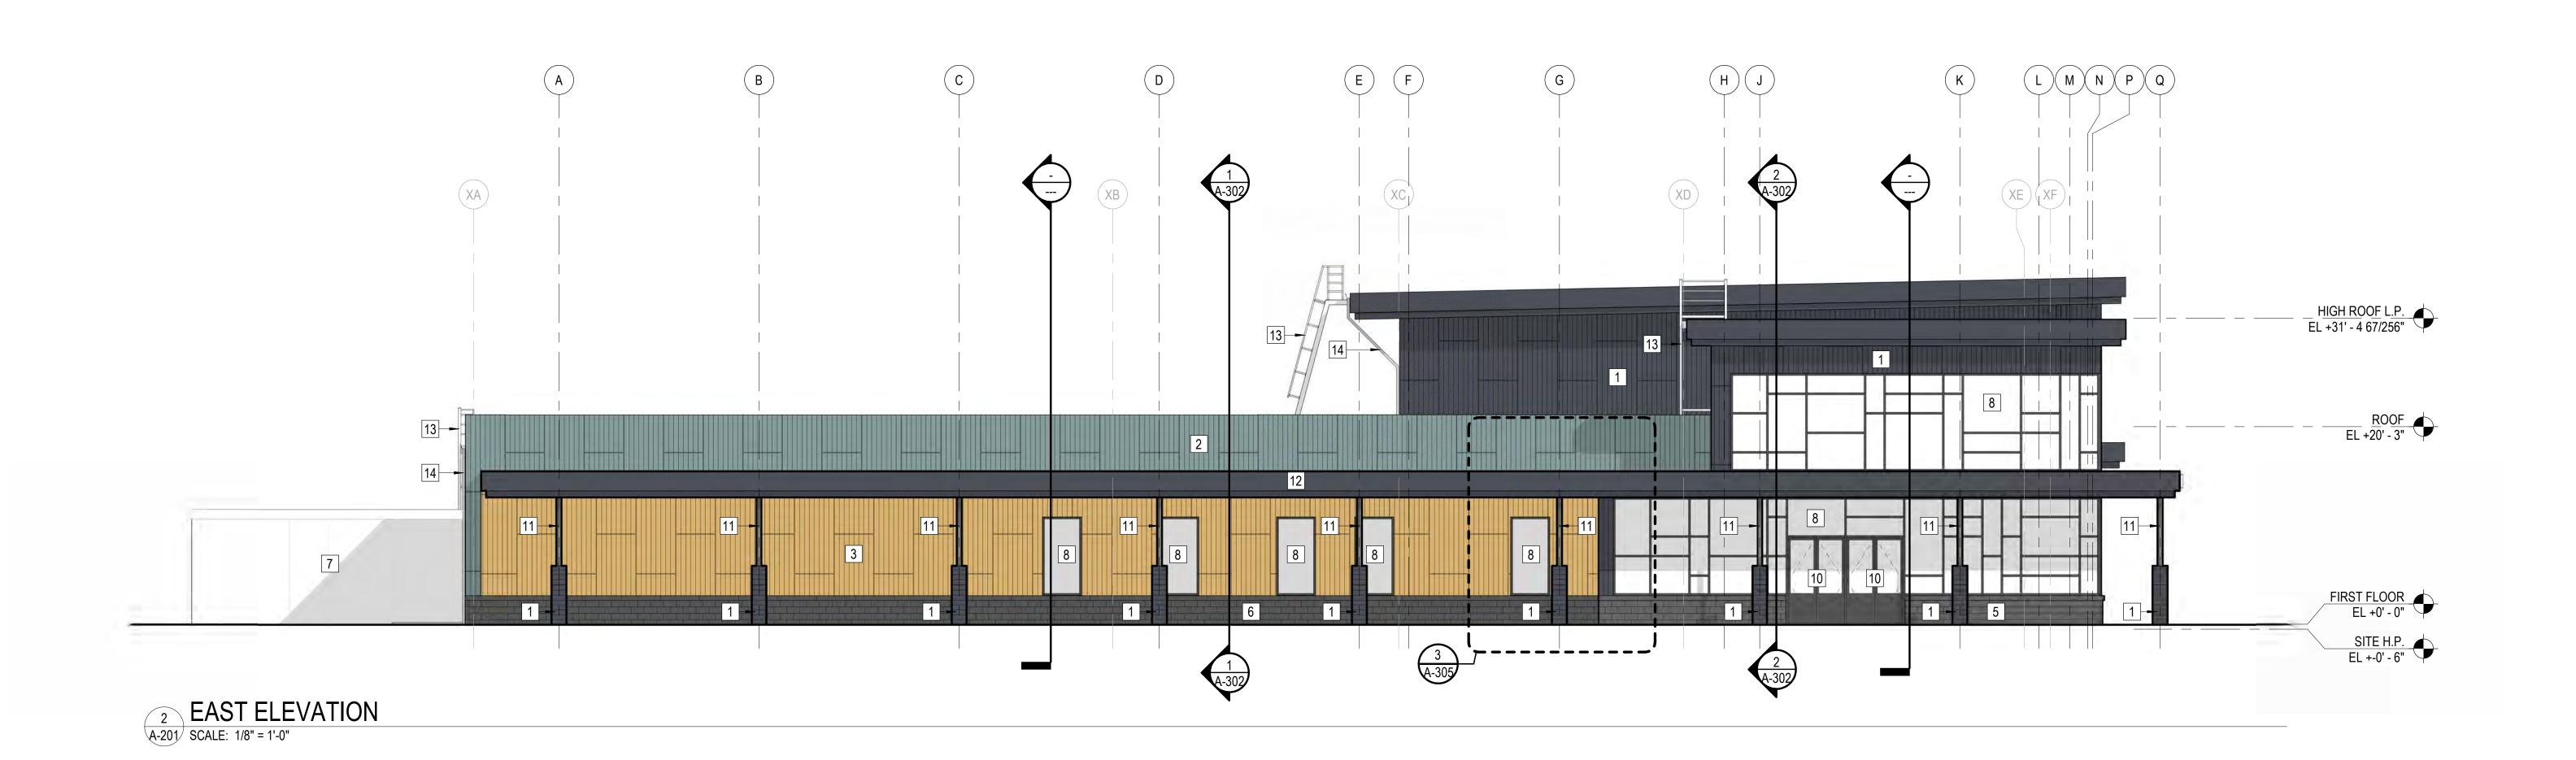



ELEVATION KEYNOTES

- 1 METAL PANEL HORIZONTAL LONGBOARD PANELBOARD SOLID 1/16" X 6" BLACK
- METAL PANEL HORIZONTAL LONGBOARD PANELBOARD SPECIALTY 1/16" X 6" MOONSTONE
- 3 METAL PANEL HORIZONTAL LONGBOARD PANELBOARD WOODGRAIN 1/16" X 6" SAND DRIFT
- 4 GROUND FACE CMU ON CMU
- 5 GROUND FACE CMU ON METAL STUD
- 6 GROUND FACE CMU ON PRECAST PANEL
- 7 PRECAST CONCRETE PANEL
- 8 STOREFRONT SYSTEM
- 9 CURTAIN WALL SYSTEM
- 10 DOOR. SEE SCHEDULE.
- 11 ROUND HOLLOW STRUCTURAL SECTION COLUMN HSS 6X0.375
- 12 ENTRY CANOPY. SEE DETAIL.
- 13 ROOF ACCESS LADDER.
- 14 GUTTERS & DOWNSPOUTS.
- 15 BUILDING NAME 24" DIMENSIONAL LETTERS.
- 16 EGRESS STAIR.
- 17 ROOF ACCESS HATCH.

RRIVINARCHITECTS, F. 2900 South Quincy Street, N. 2000 Adjustes Virginia 200



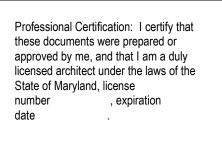

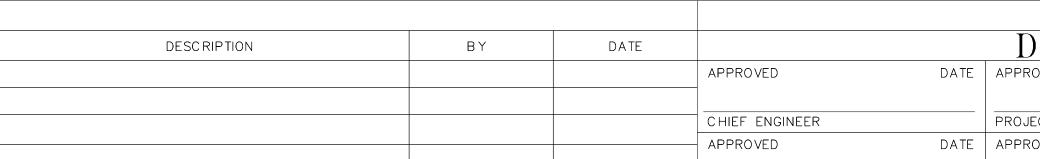

APPROVED DATE APPROVED DATE SCALE:

CHIEF ENGINEER PROJECT MANAGER

APPROVED DATE APPROVED DATE SCALE:

PROJECT MANAGER

CHECKED BY: Checker PROJECT NO. 24104-00

ASSISTANT CHIEF ENGINEER

CHIEF, RIGHT OF WAY

PROPOSAL NO.

CHIEF, RIGHT OF WAY

PROPOSAL NO.

DATE WORKS


EDGEWATER RECREATION CENTER


Author

3130 SOLOMONS ISLAND RD, EDGEWATER, MD, 21037

EXTERIOR ELEVATIONS

A-201

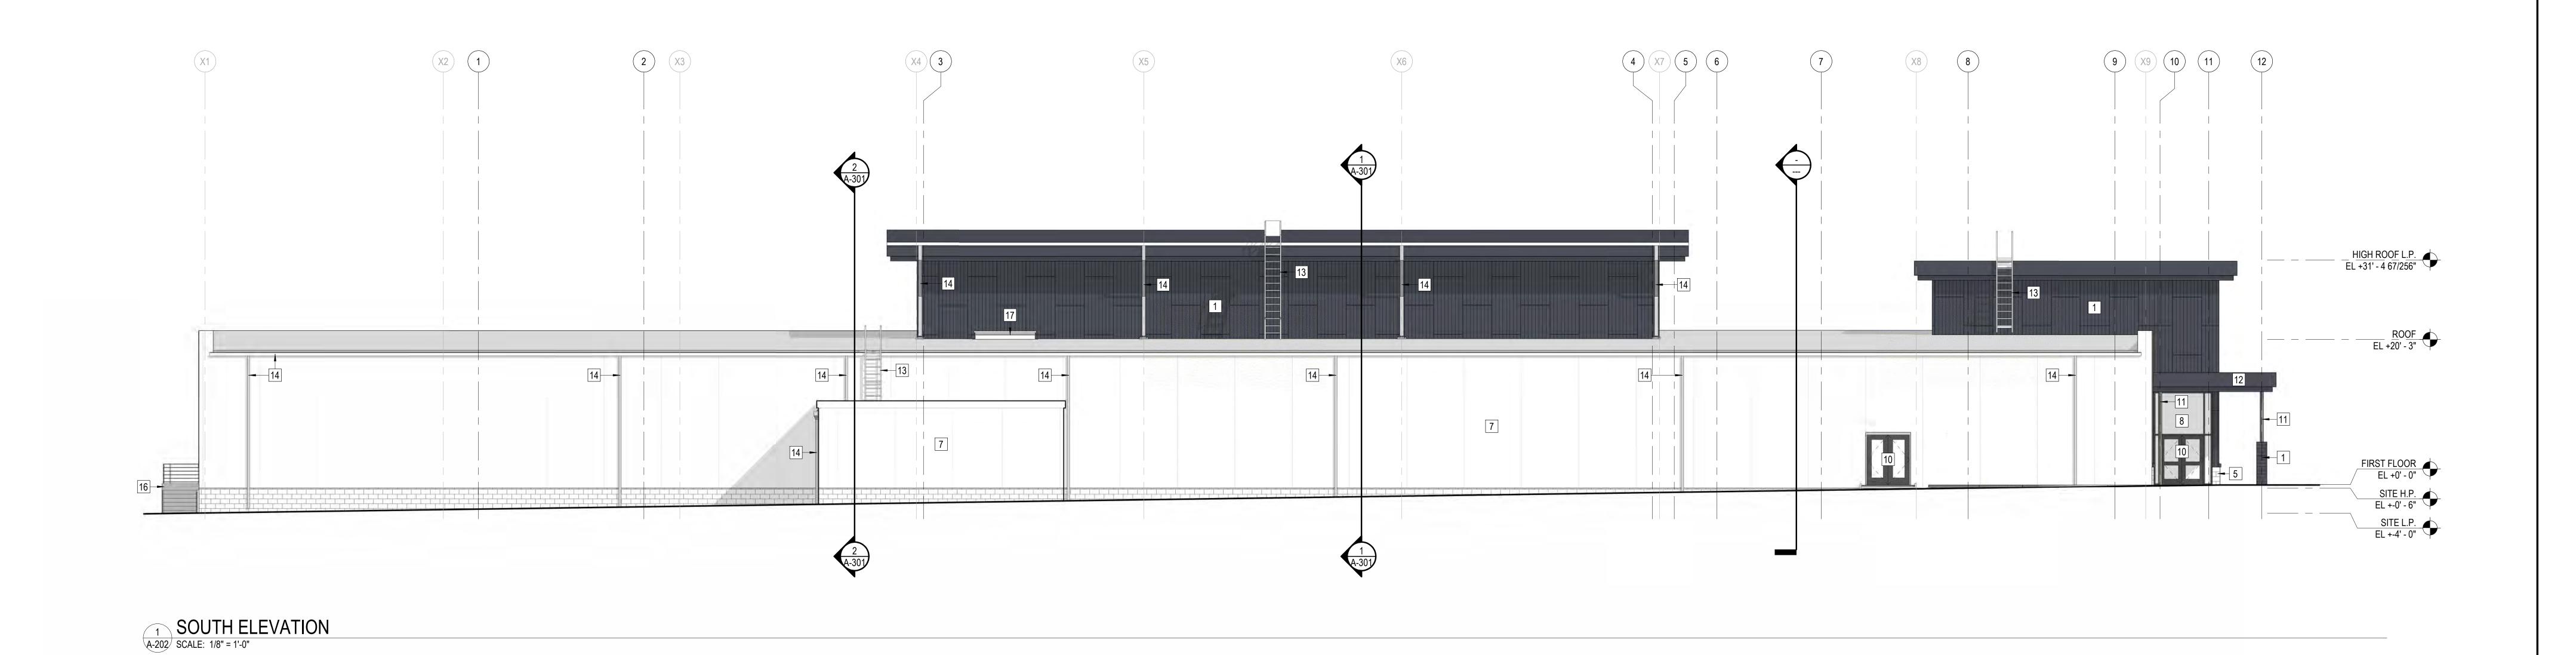

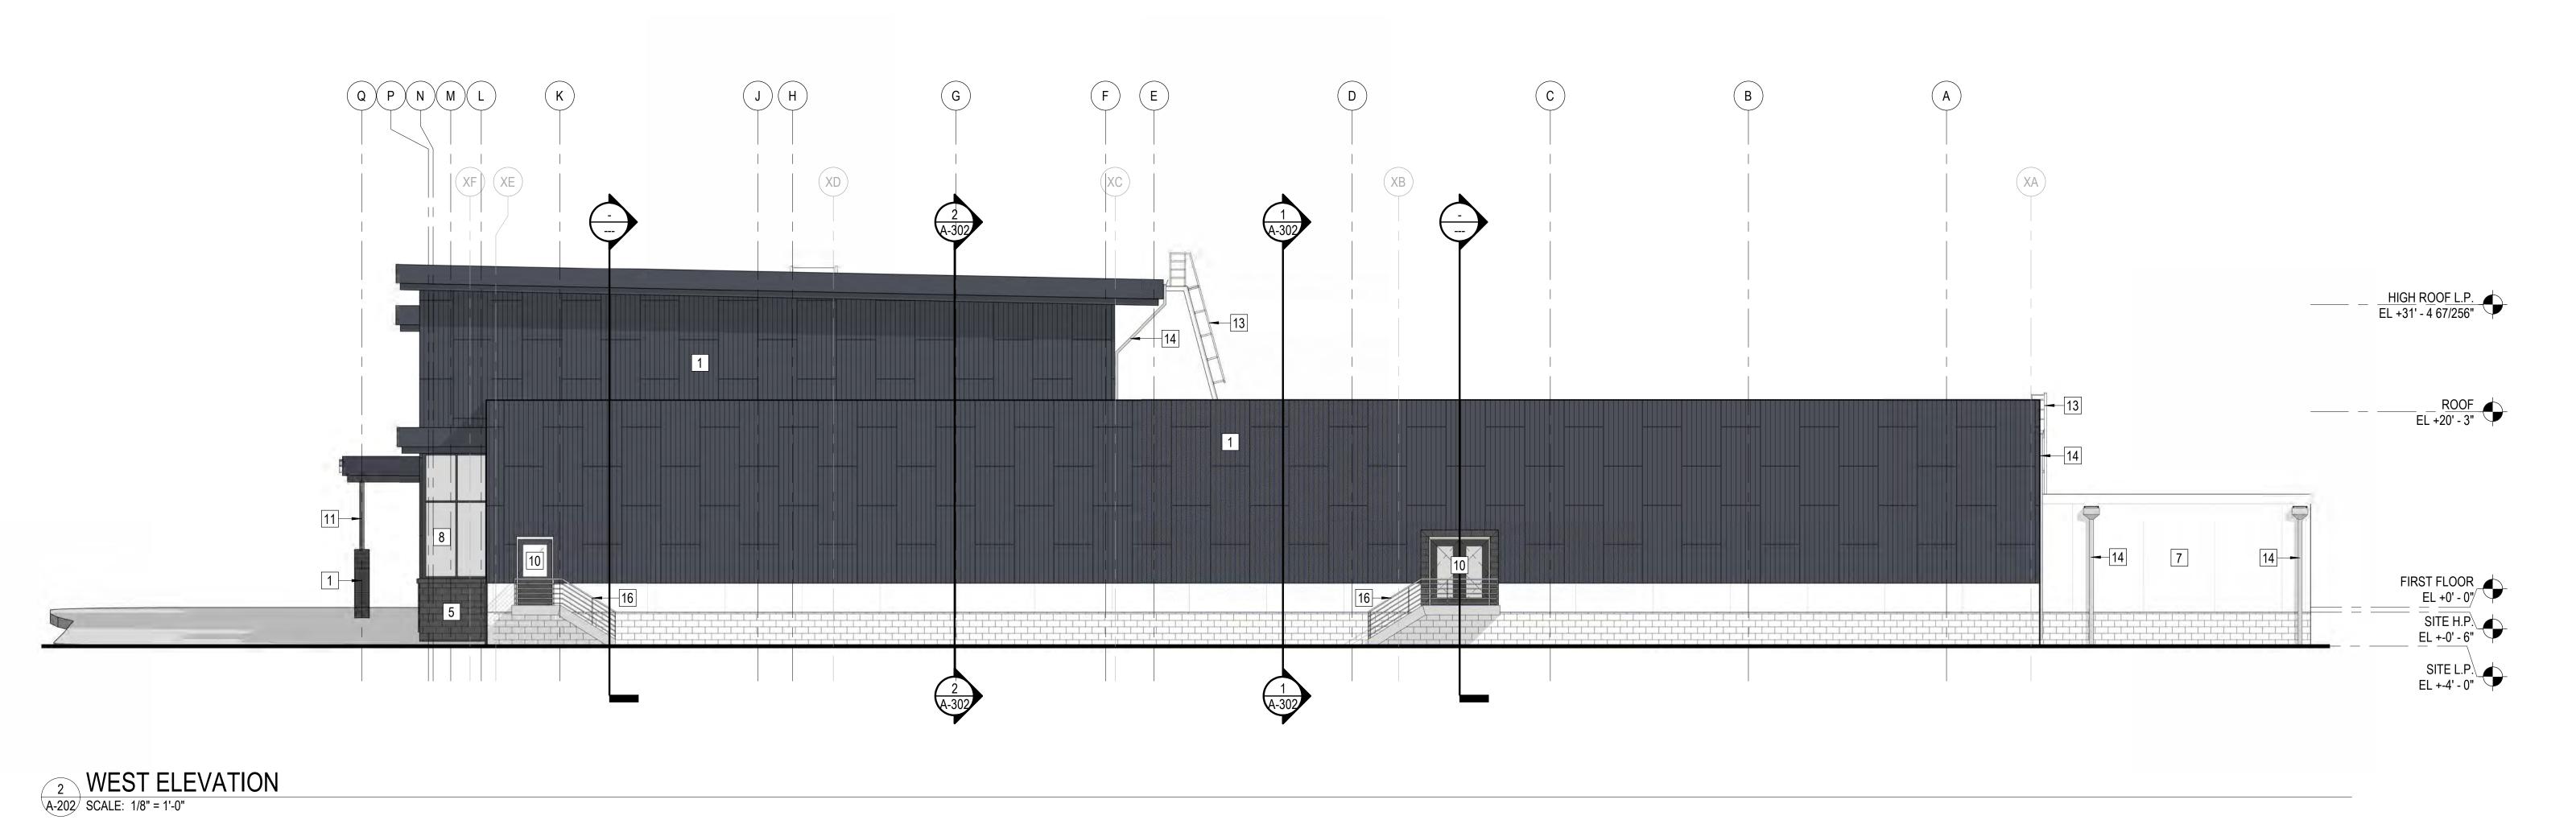



ELEVATION KEYNOTES


- 1 METAL PANEL HORIZONTAL LONGBOARD PANELBOARD SOLID 1/16" X 6" BLACK
- 2 METAL PANEL HORIZONTAL LONGBOARD PANELBOARD SPECIALTY 1/16" X 6" MOONSTONE
- METAL PANEL HORIZONTAL LONGBOARD PANELBOARD WOODGRAIN 1/16" X 6" SAND DRIFT
- 4 GROUND FACE CMU ON CMU
- 5 GROUND FACE CMU ON METAL STUD
- 6 GROUND FACE CMU ON PRECAST PANEL
- 7 PRECAST CONCRETE PANEL 8 STOREFRONT SYSTEM
- 9 CURTAIN WALL SYSTEM
- 10 DOOR. SEE SCHEDULE.
- 11 ROUND HOLLOW STRUCTURAL SECTION COLUMN HSS 6X0.375
- 12 ENTRY CANOPY. SEE DETAIL.
- 13 ROOF ACCESS LADDER.
- 14 GUTTERS & DOWNSPOUTS.
- 15 BUILDING NAME 24" DIMENSIONAL LETTERS.
- 16 EGRESS STAIR.
- 17 ROOF ACCESS HATCH.






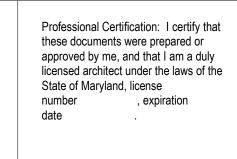

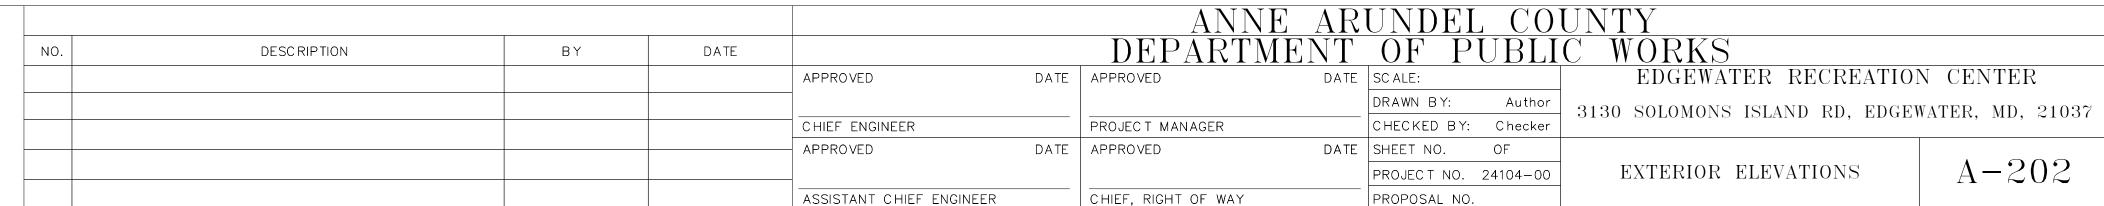

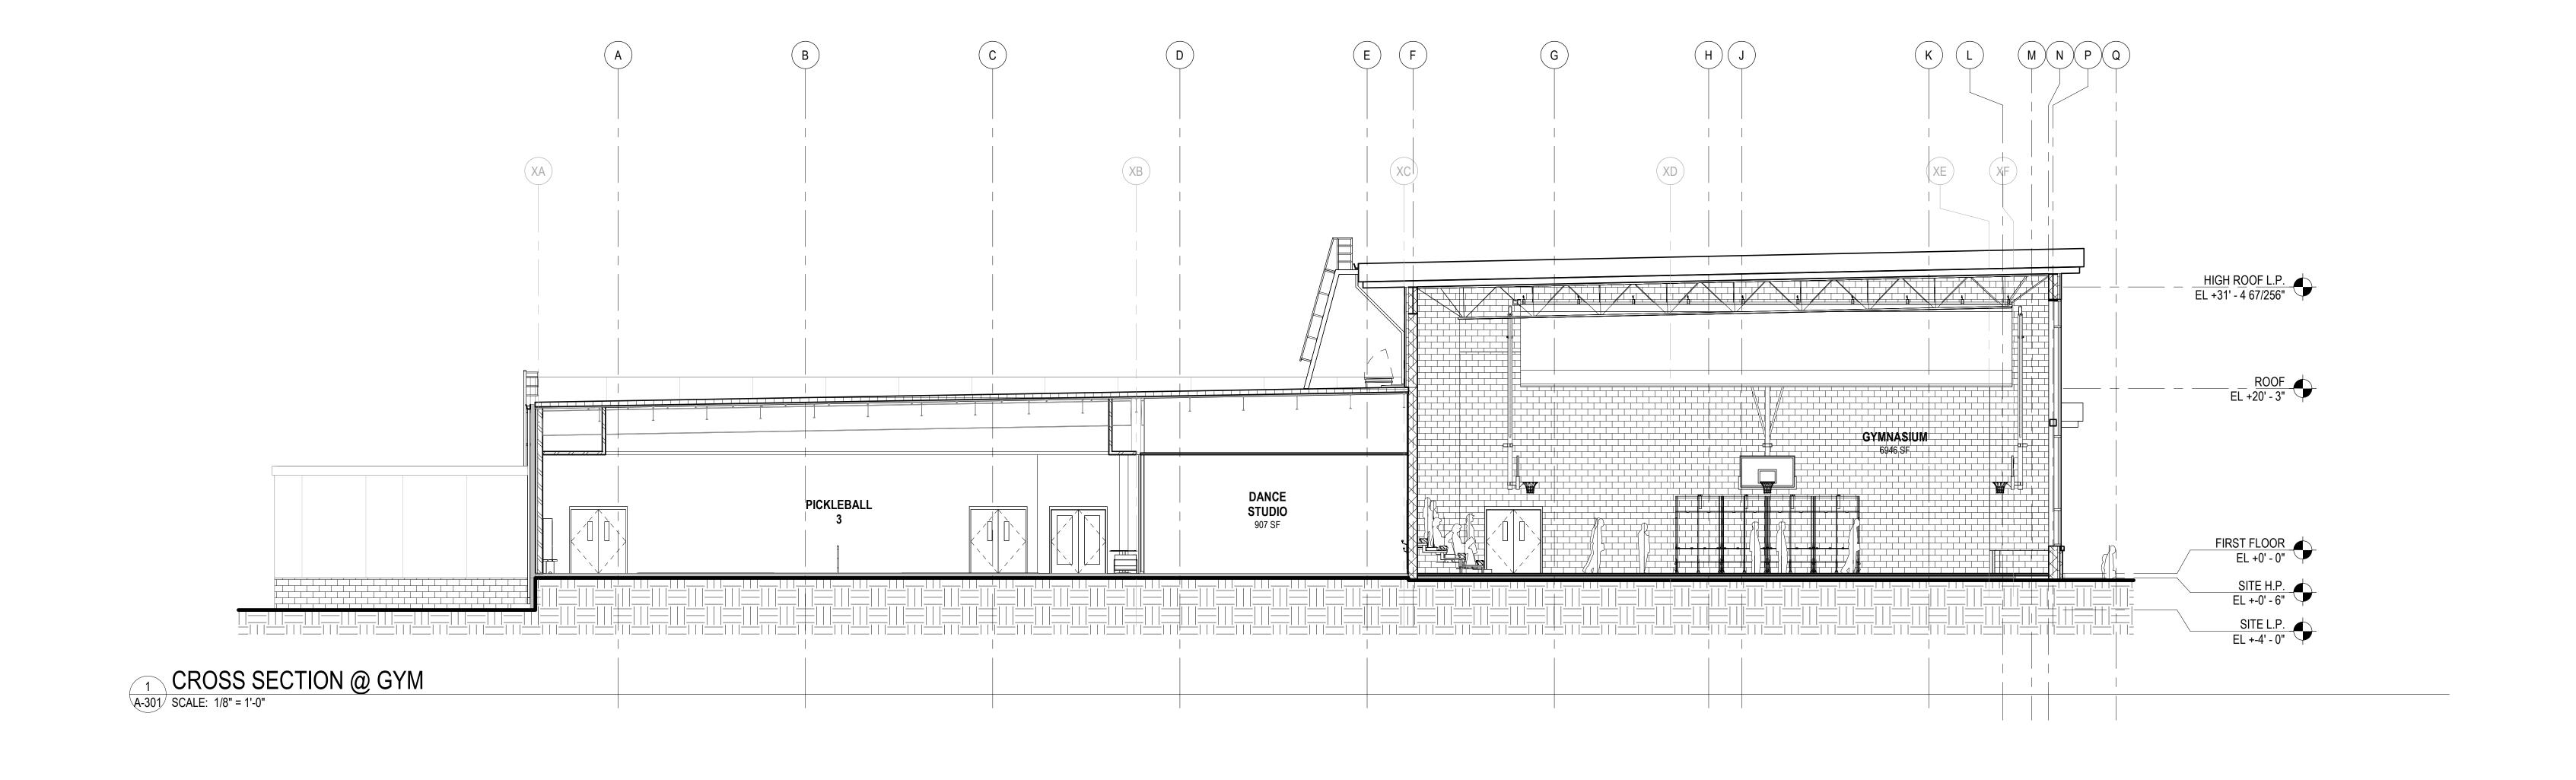

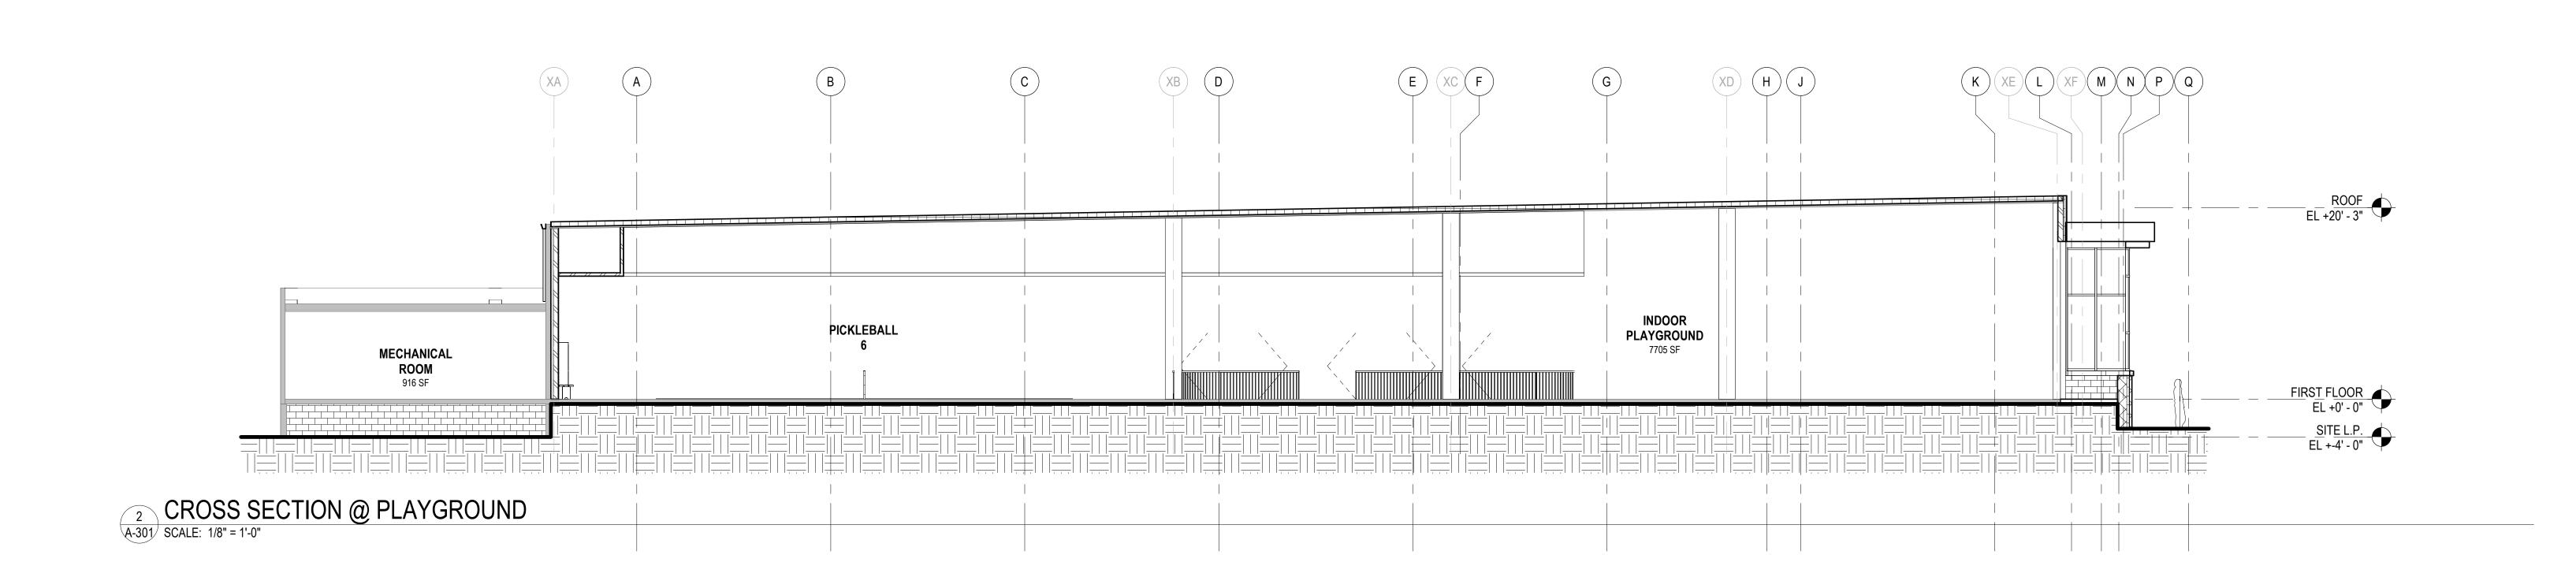



3130 SOLOMONS ISLAND RD, EDGEWATER, MD, 21037

A - 301






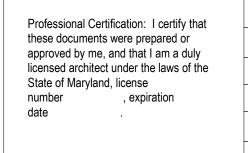

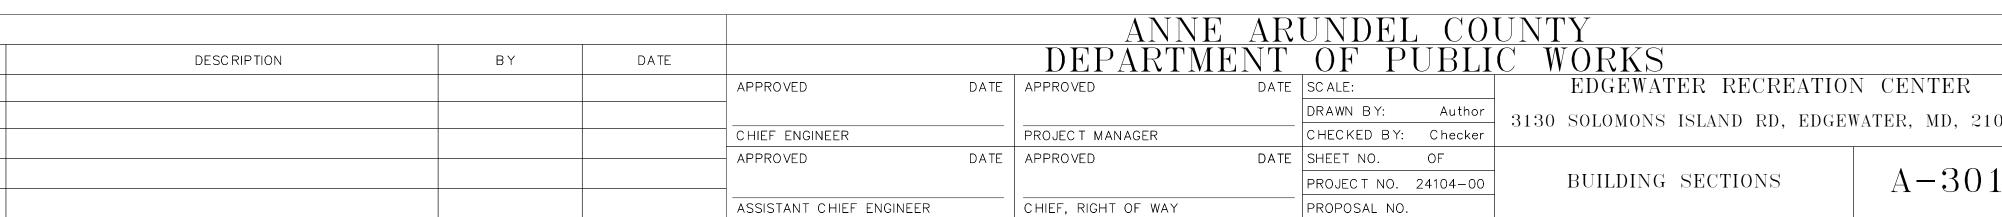


CHECKED BY: Checker DATE SHEET NO. OF BUILDING SECTIONS PROJECT NO. 24104-00 CHIEF, RIGHT OF WAY PROPOSAL NO.

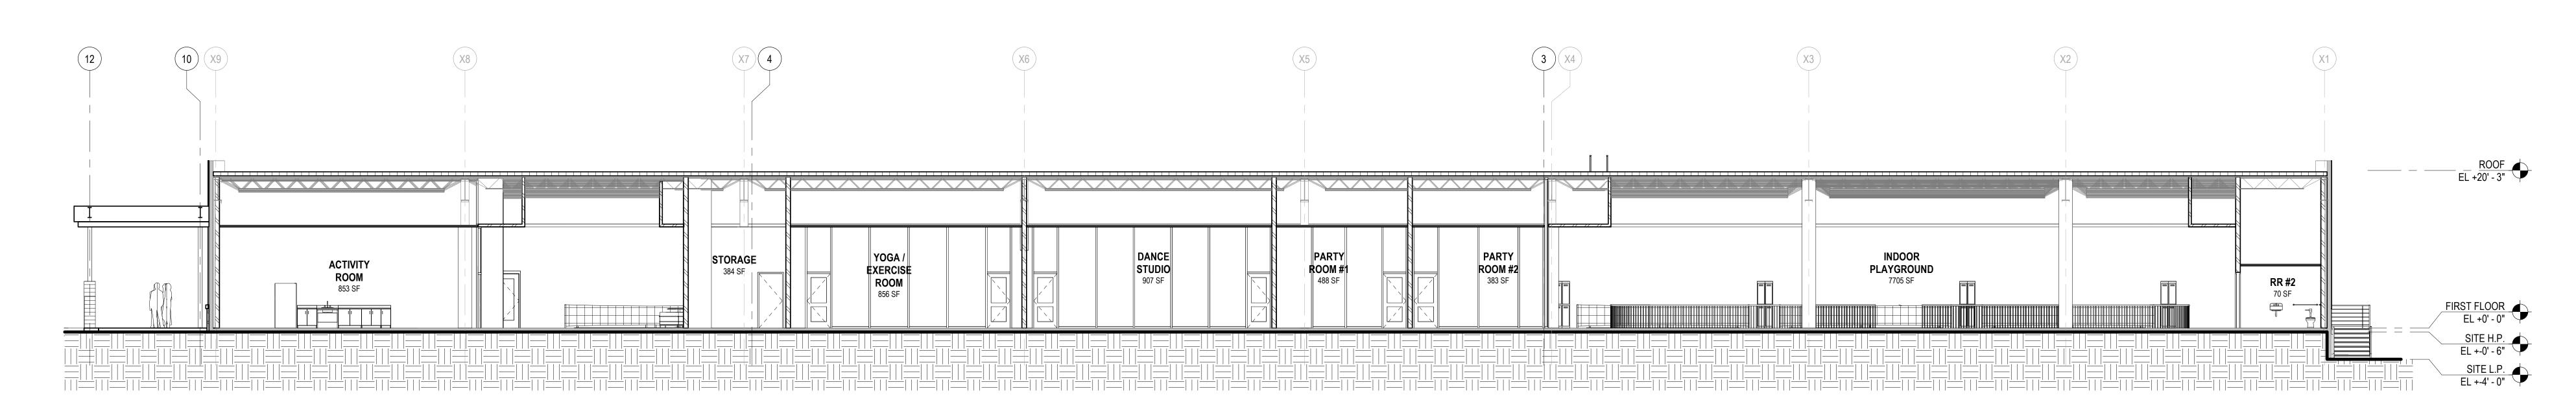

LONGITUDINAL SECTION @ ACTIVITY ROOMS


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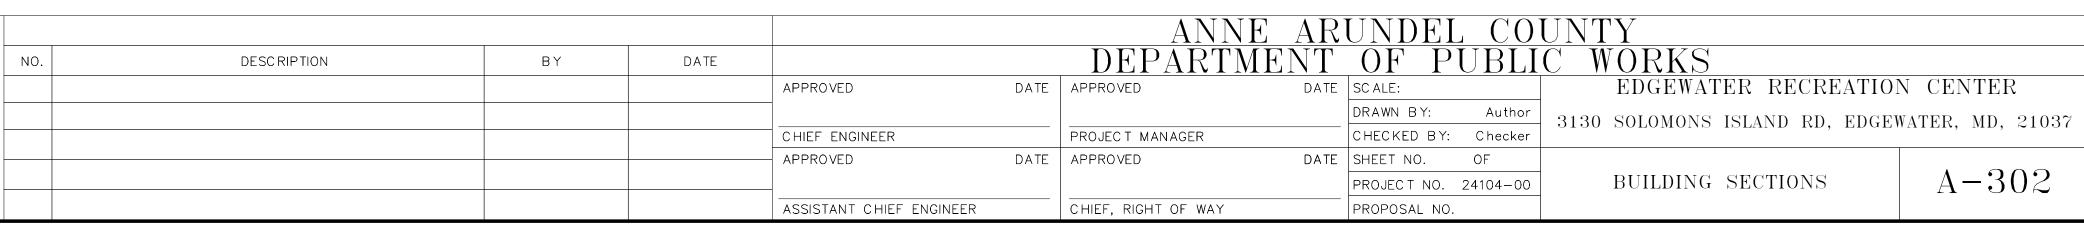


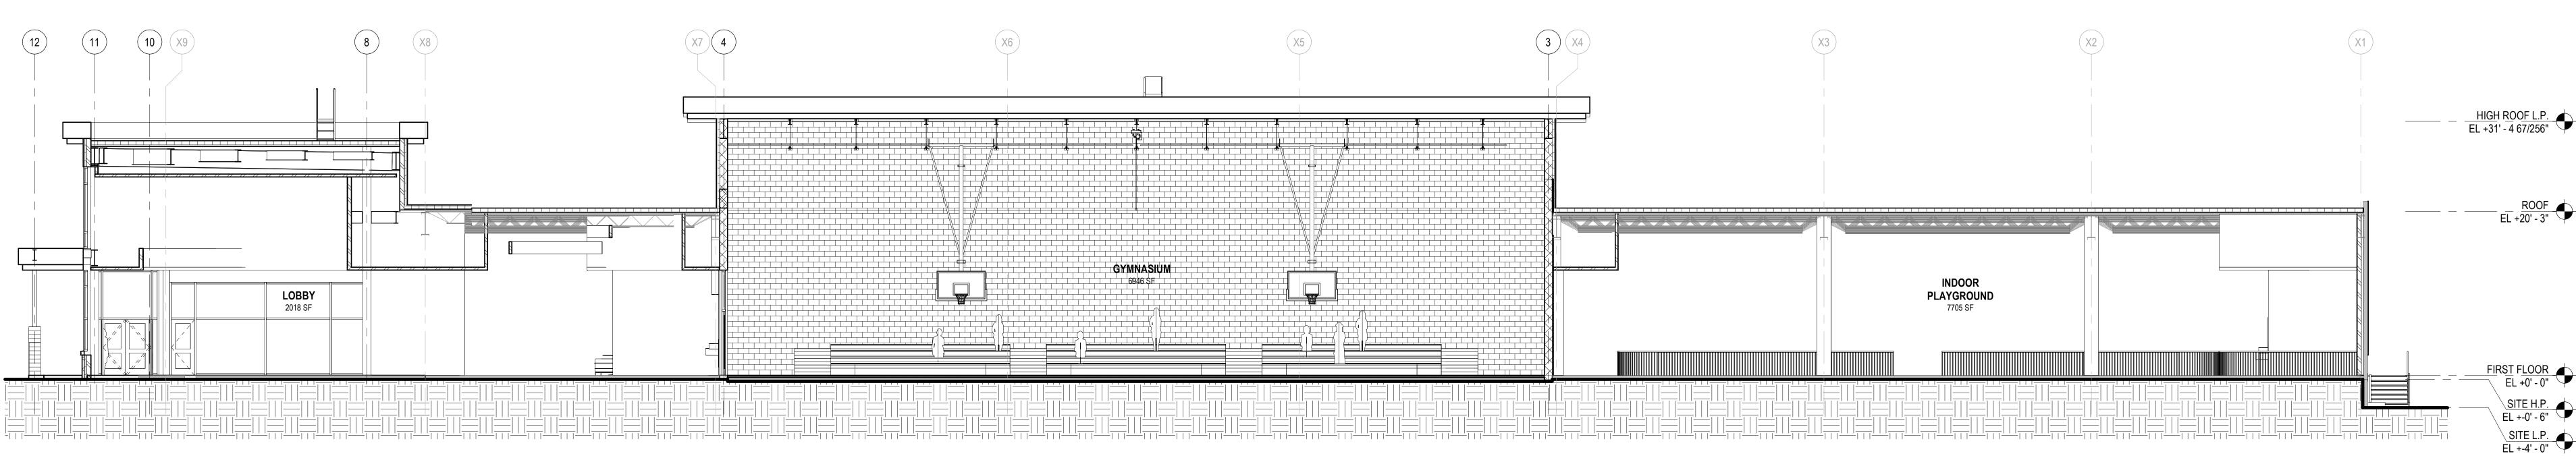2 LONGITUDINAL SECTION @ GYM
A-302 SCALE: 1/8" = 1'-0"







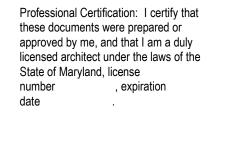

A - 302

